

EXHIBIT B-1

PTEP Alignment Sheets and Details

Contents

Legends and Symbols:

USPT-WP-YDSYM-060000-001

USPT-WP-YDSYM-060001-001

Pipeline Alignment Sheets:

USPT-WP-YDPAL-060001-001

USPT-WP-YDPAL-060001-002

USPT-WP-YDPAL-060010-001

USPT-WP-YDPAL-060011-001

USPT-WP-YDPAL-060012-001

USPT-WP-YDPAL-060013-001

USPT-WP-YDPAL-060014-001

USPT-WP-YDPAL-060015-001

USPT-WP-YDPAL-060016-001

USPT-WP-YDPAL-060017-001

USPT-WP-YDPAL-060018-001

USPT-WP-YDPAL-060019-001

USPT-WP-YDPAL-060020-001

USPT-WP-YDPAL-060021-001

USPT-WP-YDPAL-060022-001

USPT-WP-YDPAL-060023-001

USPT-WP-YDPAL-060024-001

USPT-WP-YDPAL-060025-001

USPT-WP-YDPAL-060026-001

USPT-WP-YDPAL-060027-001

USPT-WP-YDPAL-060028-001

USPT-WP-YDPAL-060029-001

USPT-WP-YDPAL-060030-001

USPT-WP-YDPAL-060031-001

USPT-WP-YDPAL-060032-001

USPT-WP-YDPAL-060033-001

Pipeline Alignment Sheets (Cont.):

USPT-WP-YDPAL-060034-001

USPT-WP-YDPAL-060035-001

USPT-WP-YDPAL-060036-001

USPT-WP-YDPAL-060037-001

USPT-WP-YDPAL-060038-001

USPT-WP-YDPAL-060039-001

Pipeline Crossing Details:

USPT-WP-YDPLX-060001-001

USPT-WP-YDPLX-060002-001

USPT-WP-YDPLX-060003-001

Detailed Drawings:

USPT-WP-YDDET-060001-001

USPT-WP-YDDET-060002-001

USPT-WP-YDDET-060009-001

USPT-WP-YDDET-060013-001

USPT-WP-YDDET-060014-001

USPT-WP-YDDET-060015-001

USPT-WP-YDDET-060016-001

USPT-WP-YDDET-110001-001

USPT-WP-YDDET-280001-001

Pipeline Isometrics:

USPT-WP-YDISO-060001-001

USPT-WP-YDISO-060002-001

USPT-WP-YDISO-060003-001

Wind-Induced Vibration Mitigation:

USPT-WP-YDWIV-060001-001

USPT-WP-YDWIV-060001-002

USPT-WP-YDWIV-060002-001

POINT THOMSON PROJECT

12" EXPORT PIPELINE
12"-LN-644-0049-ME8EV-3"H


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DECEMBER 28, 2011

ExonMobil
Development


POINT THOMSON PROJECT
12" EXPORT PIPELINE 12"-LN-644-0049-ME8EV-3"H
ISSUED FOR CONSTRUCTION
DECEMBER 28, 2011

Baker

Michael Baker Jr., Inc.

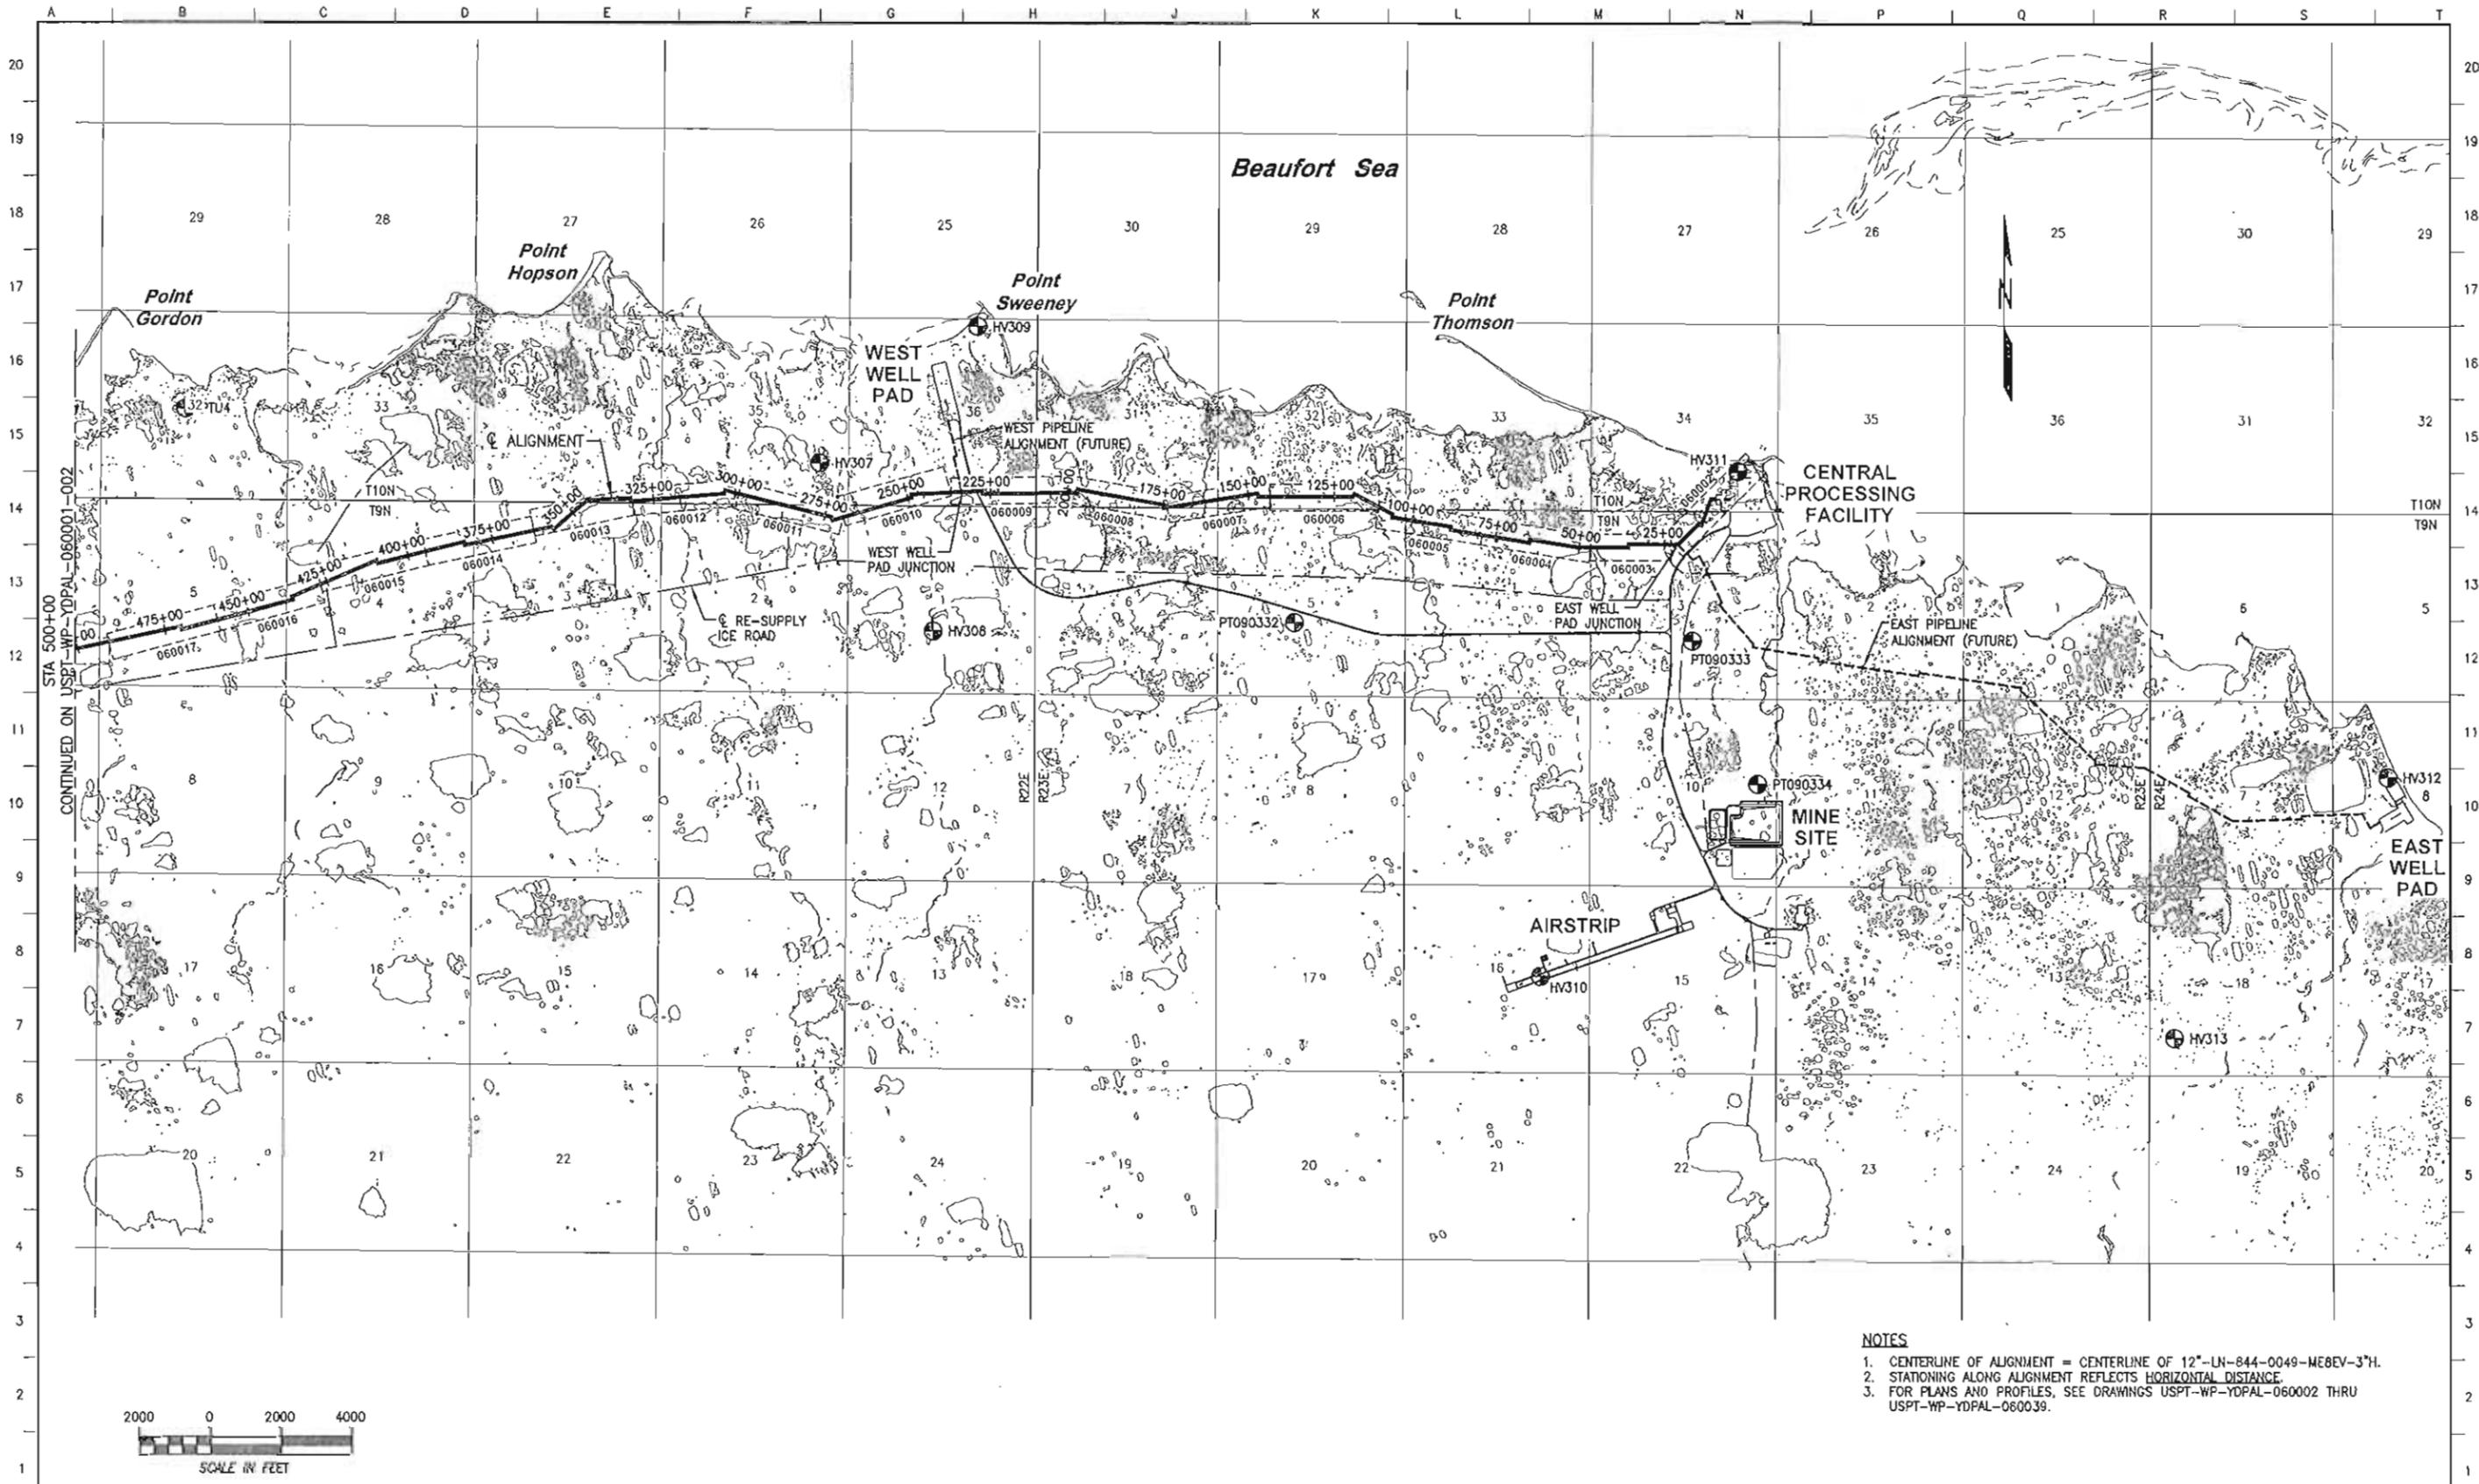

- NOTES**
1. CENTERLINE OF ALIGNMENT = CENTERLINE OF 12"-LN-844-0049-ME8EV-3"H.
 2. STATIONING ALONG ALIGNMENT REFLECTS HORIZONTAL DISTANCE.
 3. FOR PLANS AND PROFILES, SEE DRAWINGS USPT-WP-YDPAL-060002 THRU USPT-WP-YDPAL-060039.

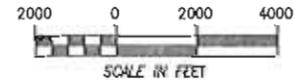

REFERENCE DRAWINGS	DESCRIPTION
USPT-WP-YDPAL-060002 THRU 060039	PLANS & PROFILES





REV	DATE	DESCRIPTION	BY	CHK	APPD	PROJ
10	12/28/11	ISSUED FOR CONSTRUCTION				



EXPORT PIPELINE - PIPELINE		ALASKA	
PIPELINE ALIGNMENT SHEET			
SITE PLAN			
BOP TO STA 500+00			
POINT THOMSON			
MODULE	DATE	SCALE	CHK
R. HOBBS	12/11	AS SHOWN	JWG
APPD			
DRAWING NO.		SHEET	REV
USPT-WP-YDPAL-060001-001		1 of 2	10

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FILENAME: USPT-WP-YDPAL-060001-001

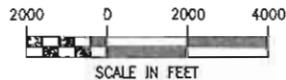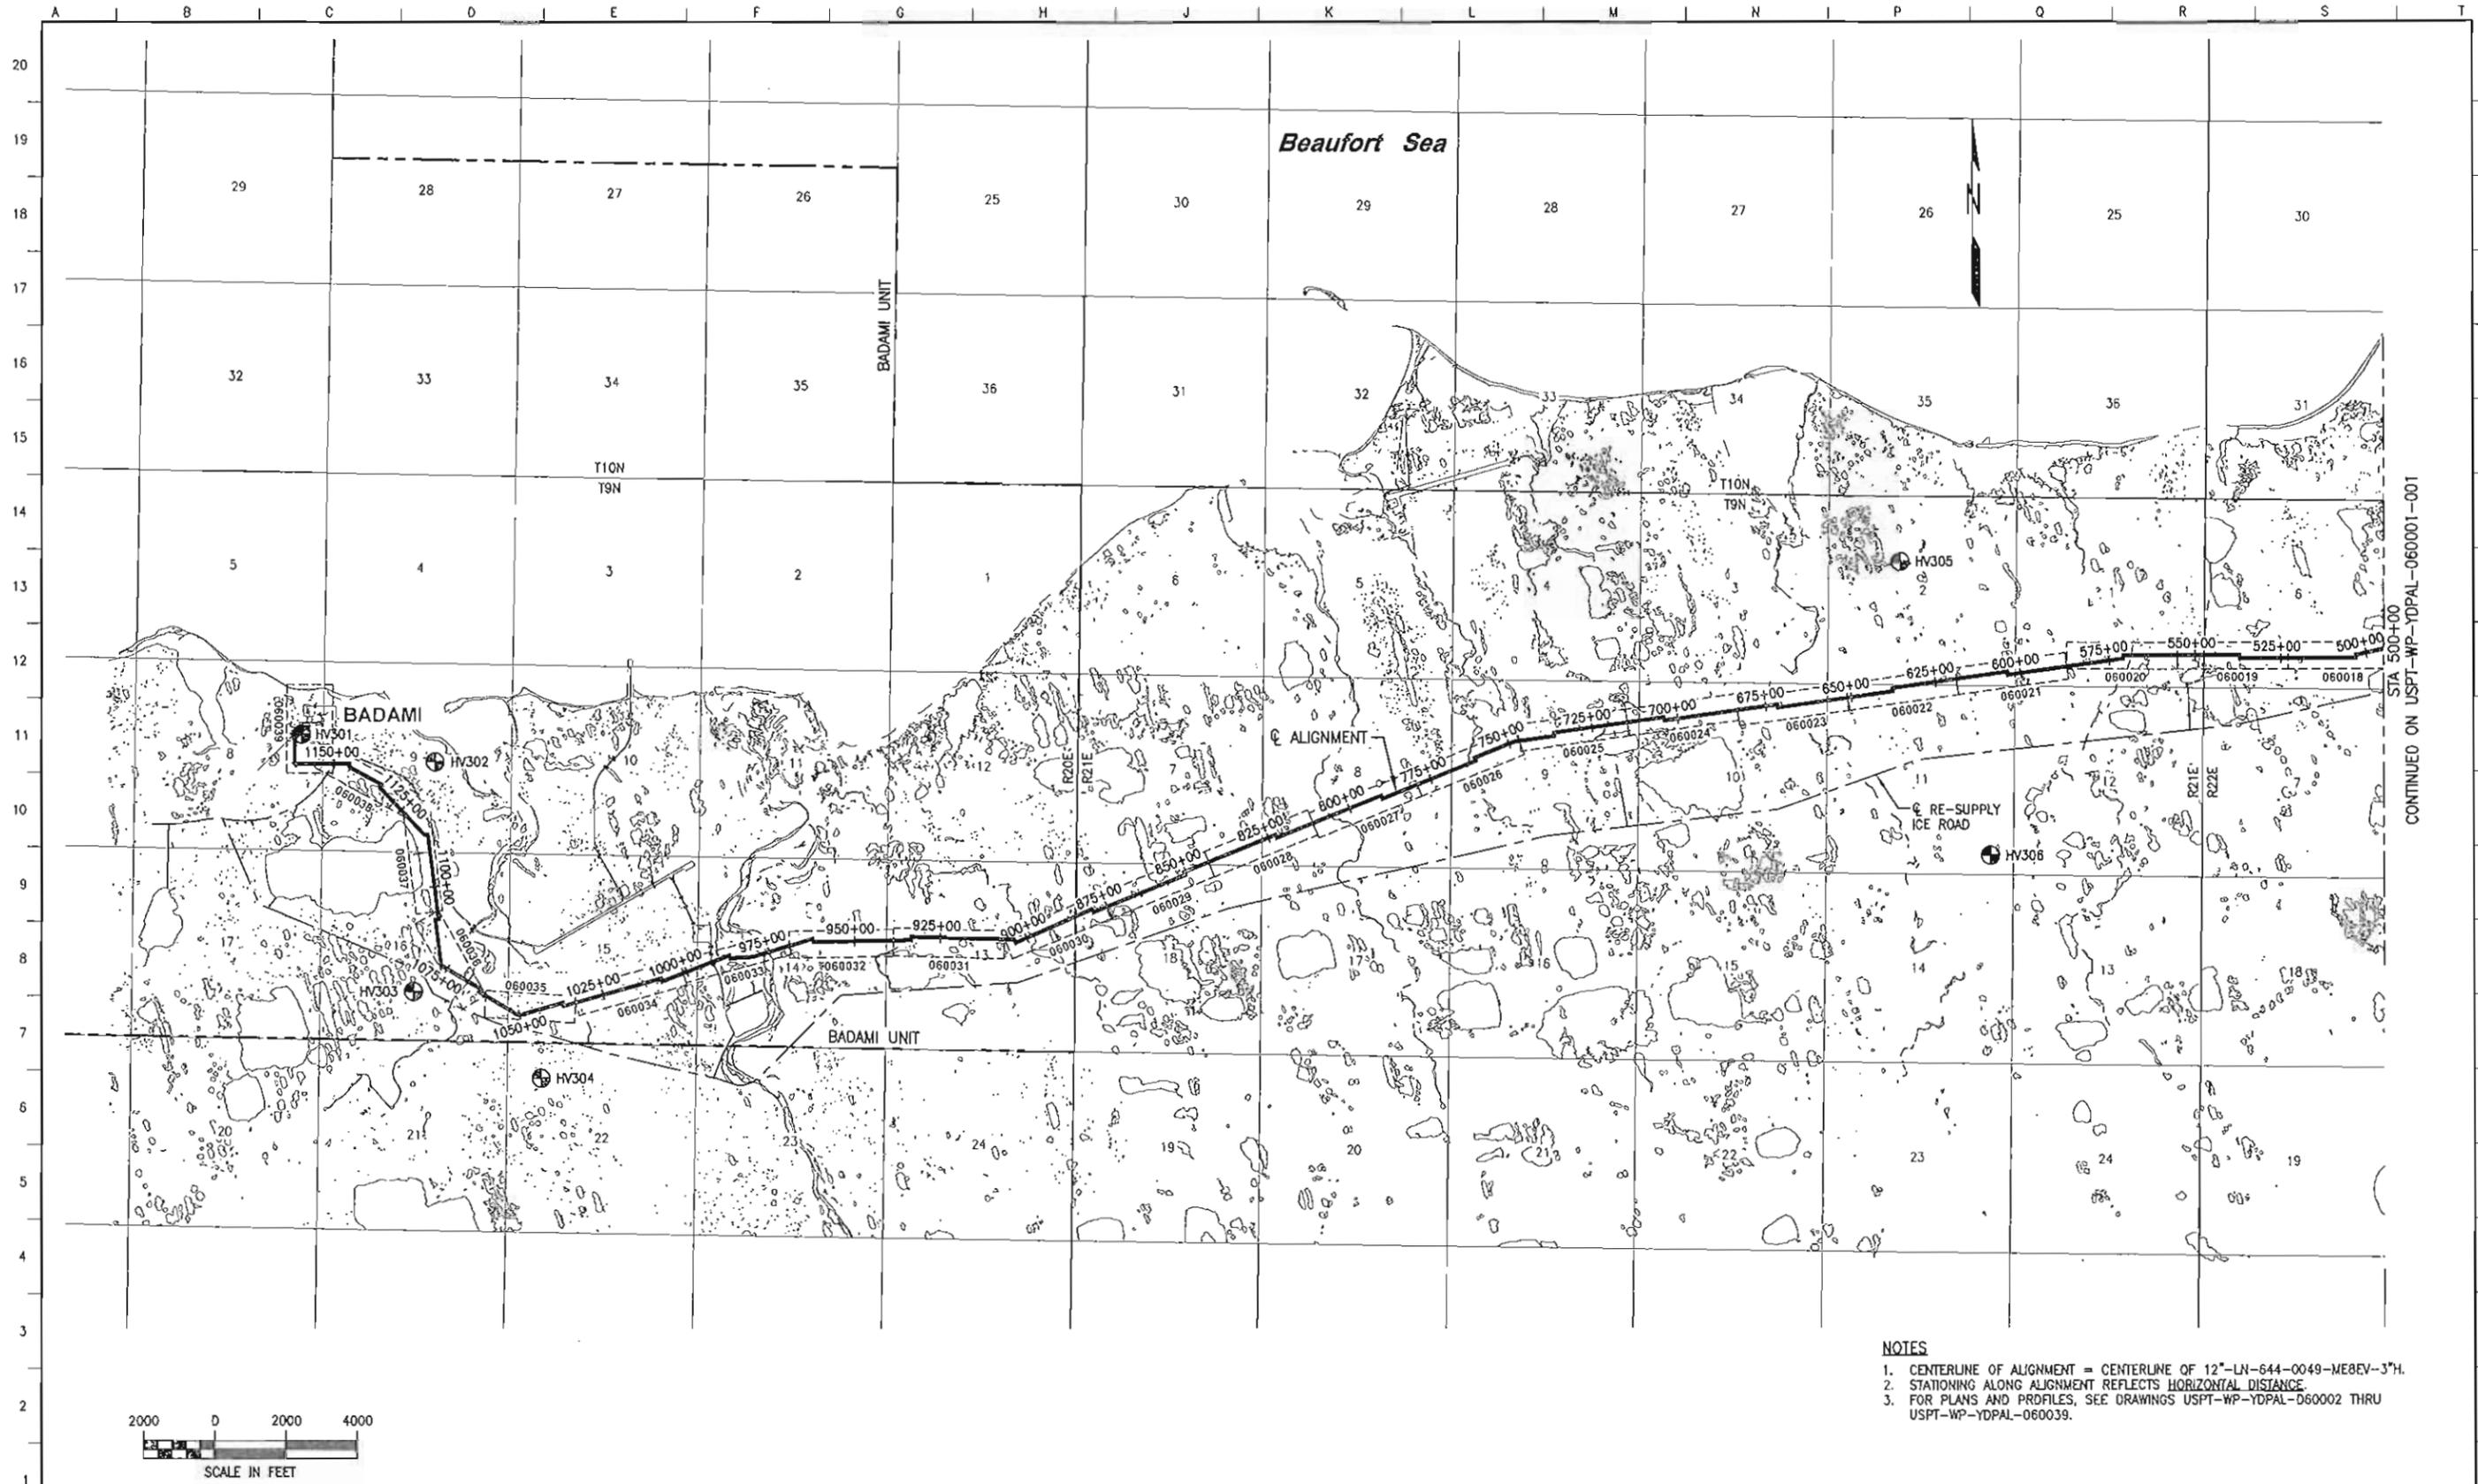

- NOTES**
- CENTERLINE OF ALIGNMENT = CENTERLINE OF 12"-LN-644-0049-ME8EV-3"H.
 - STATIONING ALONG ALIGNMENT REFLECTS HORIZONTAL DISTANCE.
 - FOR PLANS AND PROFILES, SEE DRAWINGS USPT-WP-YDPAL-D60002 THRU USPT-WP-YDPAL-D60039.

REFERENCE DRAWINGS	DESCRIPTION
USPT-WP-YDPAL-060002 THRU 060039	PLANS & PROFILES



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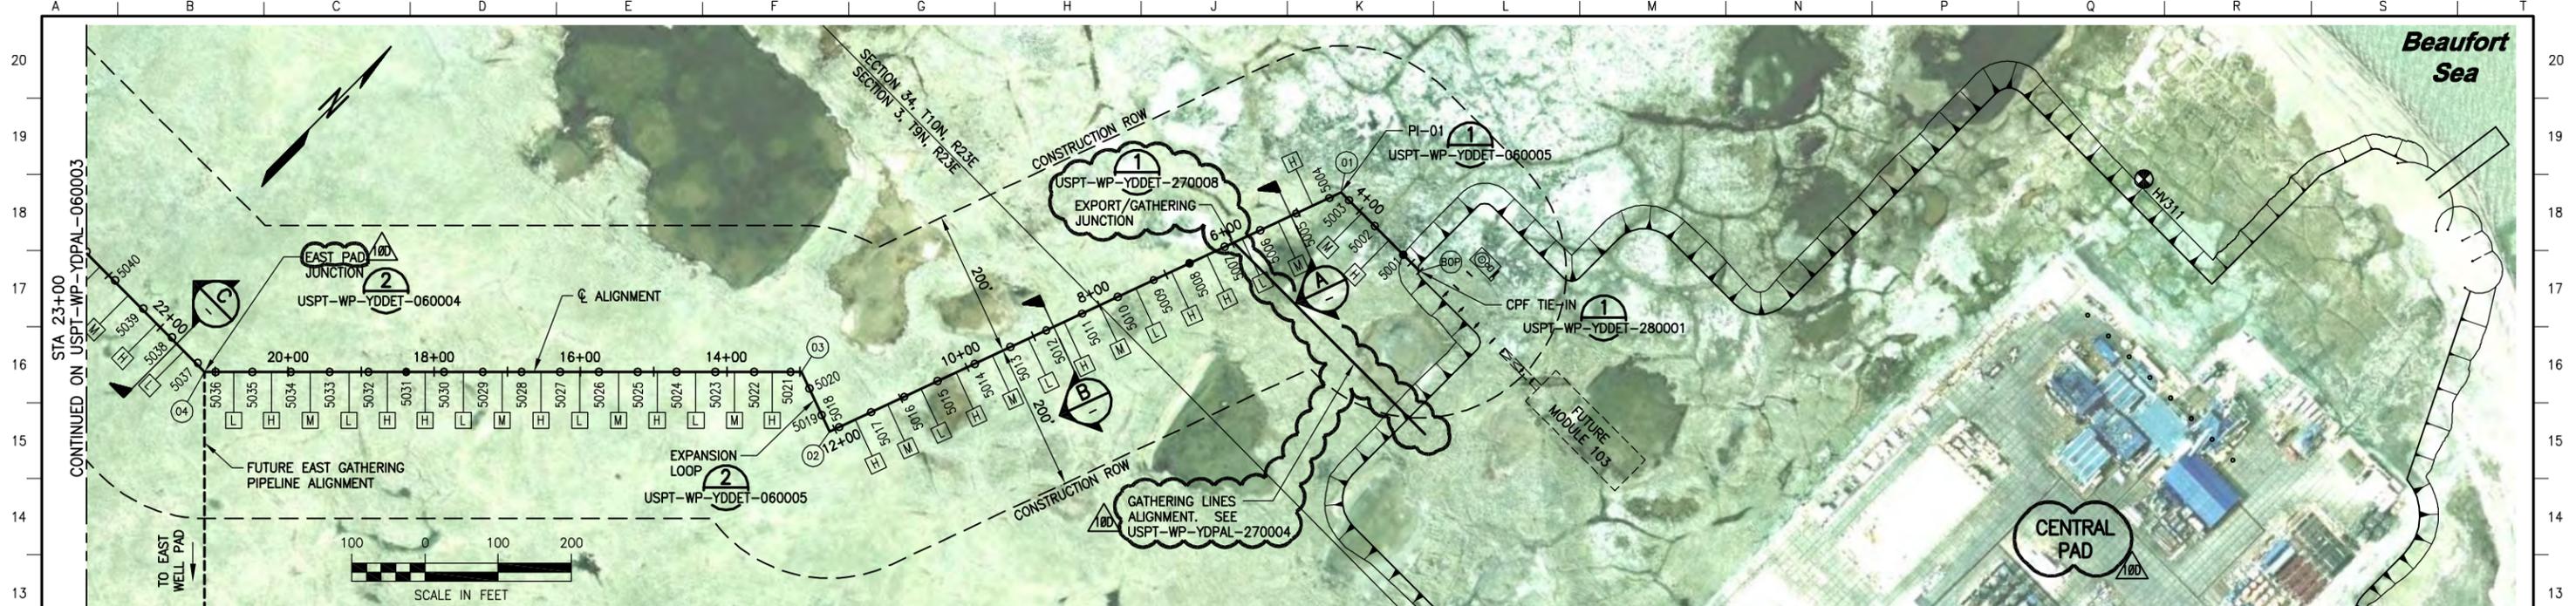
ExxonMobil Development

WorleyParsons FLUOR Baker

POINT THOMSON				ALASKA			
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	R. HOBBS	12/11	AS SHOWN				
DRAWING NO. USPT-WP-YDPAL-060001-002						SHEET 2 of 2	
						REV 10	

FILENAME: USPT-WP-YDPAL-060001-002

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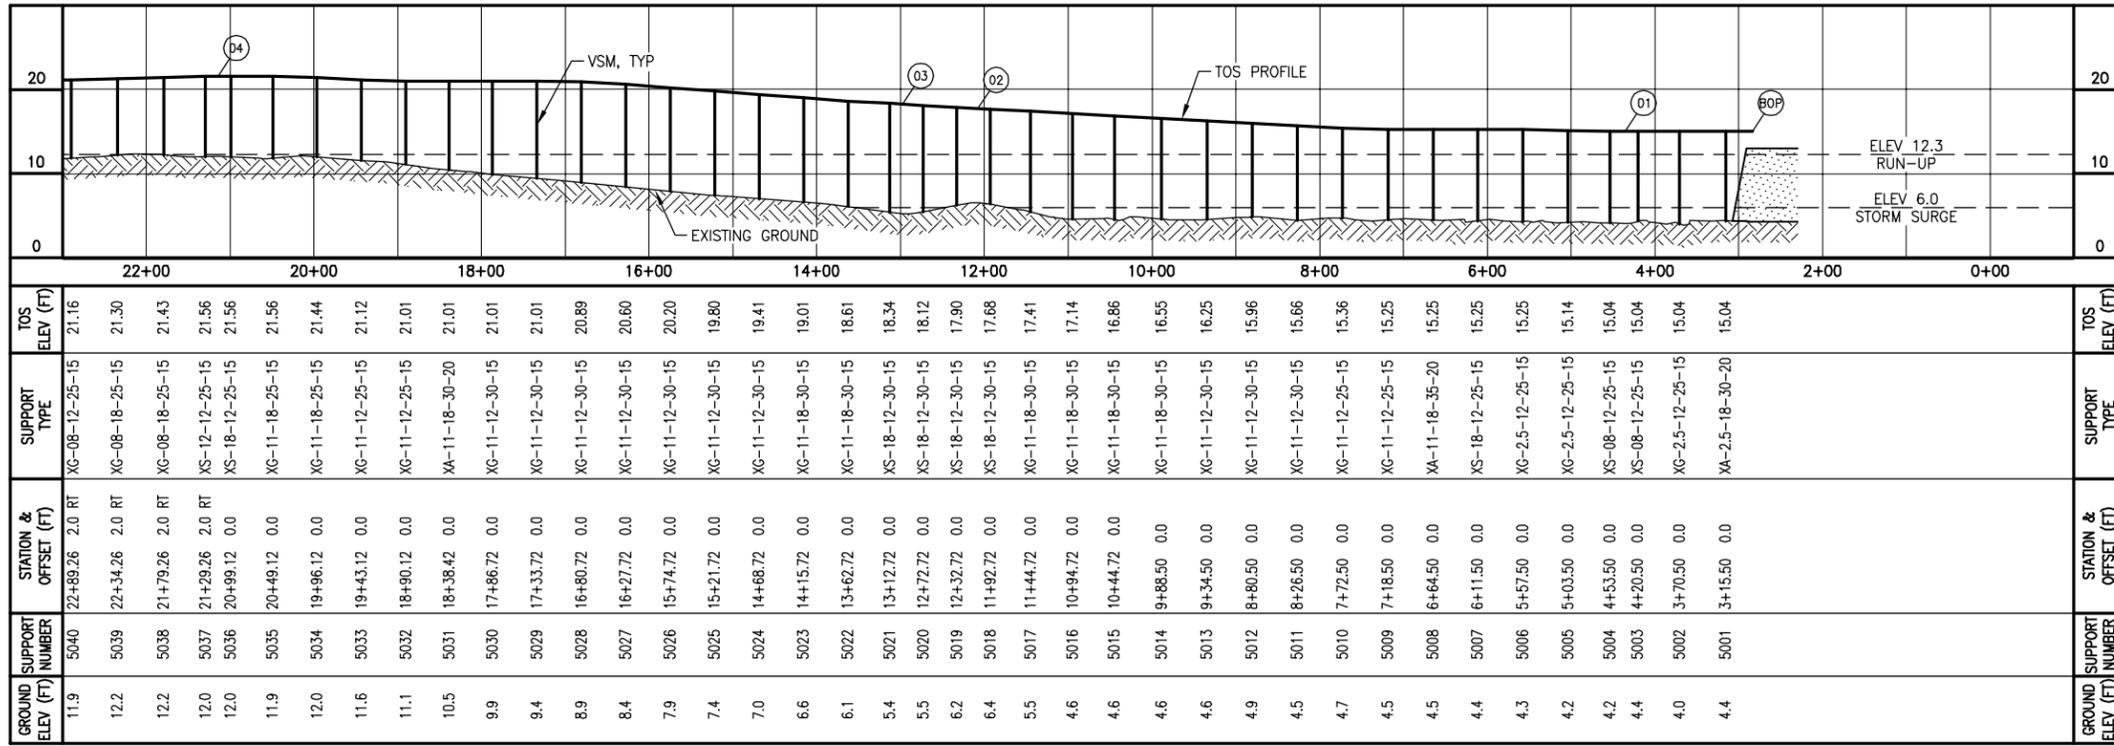
LOCATION	MATERIAL	WALL THK (IN)	FBE COATING (MIL)	INSULATION (IN)
BOP TO 23+00	12.75" DIA API 5L X65	0.500	SHOP: 20 MIN, 32 MAX FIELD: 25 MIN, 39 MAX	3.0
6+00 TO 23+00	8.625" DIA DNV SMLS 450 L UNS N08825	0.812 0.118	SHOP: 20 MIN, 32 MAX FIELD: 25 MIN, 39 MAX	3.0

POINT #	DESCRIPTION	STATION	NORTHING	EASTING	ANGLE
BOP	BEGINNING OF PIPELINE	2+83.50	5912104.40	1607616.00	-
01	PI	4+35.50	5912104.40	1607464.00	70.0°
02	PI	12+07.72	5911378.76	1607199.89	90.0°
03	PI	12+97.72	5911409.54	1607115.31	65.0°
04	PI	21+14.26	5910832.16	1606537.93	45.0°




PIPE SUPPORT IDENTIFICATION
 VS-06-704-XXXX
 VERTICAL SUPPORT
 LOCATION CODE
 UNIT/MODULE
 SEQUENTIAL NUMBER (SHOWN ON PLAN & PROFILE)

SUPPORT TYPE NOMENCLATURE
 XX-XX-XX-XX-XX
 EXPORT = "X"
 GUIDE = "G"
 SLIDE = "S"
 ANCHOR = "A"
 HSM LENGTH (FT)
 NOMINAL VSM DIAMETER (IN)
 VSM LENGTH (FT)
 MINIMUM EMBEDMENT (FT)

- NOTES**
- CENTERLINE OF ALIGNMENT = CENTERLINE OF 12"-LN-644-0049-ME8EV-3"H.
 - STATIONING ALONG ALIGNMENT REFLECTS HORIZONTAL DISTANCE.
 - HORIZONTAL DATUM IS NAD83, ALASKA STATE PLANE ZONE 3, US FOOT.
 - VERTICAL DATUM IS POINT THOMSON UNIT MEAN LOWER LOW WATER (PTU MLLW).
 - FOR GUIDED AND ANCHORED SUPPORT DETAILS, SEE USPT-WP-YDDET-060010.
 - FOR SLIDING SUPPORT DETAILS, SEE USPT-WP-YDDET-060011.
 - FOR WIND-INDUCED VIBRATION MITIGATION PLAN AND TUNED VIBRATION ABSORBER (TVA) INSTALLATION, SEE USPT-WP-YDWIV-060001 AND USPT-WP-YDWIV-270001.
- LEGEND**
- GUIDED OR SLIDING SUPPORT
 - ANCHORED SUPPORT
 - # PI OR VPI LOCATION
 - H HIGH FREQUENCY TVA
 - L LOW FREQUENCY TVA
 - M MEDIUM FREQUENCY TVA



GROUND SUPPORT ELEV (FT)	SUPPORT NUMBER	STATION & OFFSET (FT)	SUPPORT TYPE	TOS ELEV (FT)
11.9	5040	22+89.26 2.0 RT	XG-08-12-25-15	21.16
12.2	5039	22+34.26 2.0 RT	XG-08-18-25-15	21.30
12.2	5038	21+79.26 2.0 RT	XG-08-18-25-15	21.43
12.0	5037	21+29.26 2.0 RT	XS-12-12-25-15	21.56
12.0	5036	20+99.12 0.0	XS-18-12-25-15	21.56
11.9	5035	20+49.12 0.0	XG-11-18-25-15	21.56
12.0	5034	19+96.12 0.0	XG-11-18-25-15	21.44
11.6	5033	19+43.12 0.0	XG-11-12-25-15	21.12
11.1	5032	18+90.12 0.0	XG-11-12-25-15	21.01
10.5	5031	18+38.42 0.0	XA-11-18-30-20	21.01
9.9	5030	17+86.72 0.0	XG-11-12-30-15	21.01
9.4	5029	17+33.72 0.0	XG-11-12-30-15	20.89
8.9	5028	16+80.72 0.0	XG-11-12-30-15	20.60
8.4	5027	16+27.72 0.0	XG-11-12-30-15	20.20
7.9	5026	15+74.72 0.0	XG-11-12-30-15	19.80
7.4	5025	15+21.72 0.0	XG-11-12-30-15	19.41
7.0	5024	14+68.72 0.0	XG-11-18-30-15	19.01
6.6	5023	14+15.72 0.0	XG-11-18-30-15	18.61
6.1	5022	13+62.72 0.0	XG-11-18-30-15	18.34
5.4	5021	13+12.72 0.0	XS-18-12-30-15	18.12
5.5	5020	12+72.72 0.0	XS-18-12-30-15	17.90
6.2	5019	12+32.72 0.0	XS-18-12-30-15	17.68
6.4	5018	11+92.72 0.0	XG-11-18-30-15	17.41
5.5	5017	11+44.72 0.0	XG-11-18-30-15	17.14
4.6	5016	10+94.72 0.0	XG-11-18-30-15	16.86
4.6	5015	10+44.72 0.0	XG-11-18-30-15	16.55
4.6	5014	9+88.50 0.0	XG-11-18-30-15	16.25
4.6	5013	9+34.50 0.0	XG-11-12-30-15	15.96
4.9	5012	8+80.50 0.0	XG-11-12-30-15	15.66
4.5	5011	8+26.50 0.0	XG-11-12-30-15	15.36
4.7	5010	7+72.50 0.0	XG-11-12-25-15	15.25
4.5	5009	7+18.50 0.0	XG-11-12-25-15	15.25
4.5	5008	6+64.50 0.0	XA-11-18-35-20	15.14
4.4	5007	6+11.50 0.0	XS-18-12-25-15	15.04
4.3	5006	5+57.50 0.0	XG-2.5-12-25-15	15.04
4.2	5005	5+03.50 0.0	XG-2.5-12-25-15	15.04
4.2	5004	4+53.50 0.0	XS-08-12-25-15	15.04
4.4	5003	4+20.50 0.0	XS-08-12-25-15	15.04
4.0	5002	3+70.50 0.0	XG-2.5-12-25-15	15.04
4.4	5001	3+15.50 0.0	XA-2.5-18-30-20	15.04

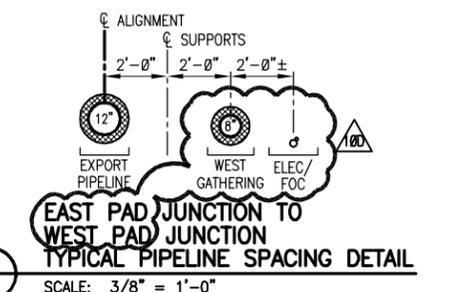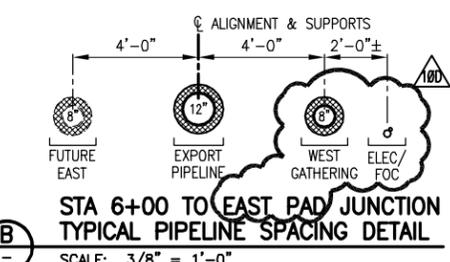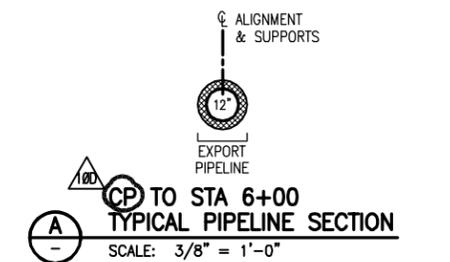

REFERENCE DRAWINGS	DESCRIPTION
USPT-WP-YDSYM-060001	PROJECT NOTES, ABBREVIATIONS AND LEGEND
USPT-WP-YDPAL-060001	SITE PLAN
USPT-WP-YDDET-060001	TYPICAL EXPANSION LOOP DETAIL
USPT-WP-YDDET-060010	GUIDED AND ANCHORED SUPPORT DETAILS
USPT-WP-YDDET-060011	SLIDING SUPPORT DETAILS
USPT-WP-YDDET-280001	CPF TIE-IN PLAN AND DETAILS
USPT-WP-YDWIV-060001	WIND-INDUCED VIBRATION MITIGATION PLAN

REV	DATE	DESCRIPTION	BY	CHK	APPD	PROJ
10	12/28/11	ISSUED FOR CONSTRUCTION	RFH	JAG	PAC	GMP
10A	05/14/12	ISSUED FOR INTERNAL REVIEW	RFH	JAG	PAC	GMP
10B	05/21/12	ISSUED FOR SQUAD CHECK	RFH	JAG	PAC	GMP
10C	06/08/12	ISSUED FOR CLIENT REVIEW	RFH	JAG	PAC	GMP
10D	06/29/12	ISSUED FOR QUOTE	RFH	JAG	PAC	GMP

PRELIMINARY NOT FOR CONSTRUCTION

ExxonMobil Development

WorleyParsons FLUOR Baker


EXPORT PIPELINE - PIPELINE PIPELINE ALIGNMENT SHEET PLAN & PROFILE BOP TO STA 23+00

MODULE	DRAWN	DATE	SCALE	CHK	JAG	ALASKA
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DRAWING NO.	USPT-WP-YDPAL-060002-001		SHEET		REV	
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PT-D-BAKER.DWG (24x36)

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FILENAME: USPT-WP-YDPAL-060002-001



LOCATION	MATERIAL	WALL THK (IN)	FBE COATING (MIL)	INSULATION (IN)
23+00 TO 47+00	12.75" DIA API 5L X65	0.500	SHOP: 20 MIN, 32 MAX FIELD: 25 MIN, 39 MAX	3.0
23+00 TO 47+00	8.625" DIA DNV SMLS 450 L - UNS N08825	0.812 0.118	SHOP: 20 MIN, 32 MAX FIELD: 25 MIN, 39 MAX	3.0

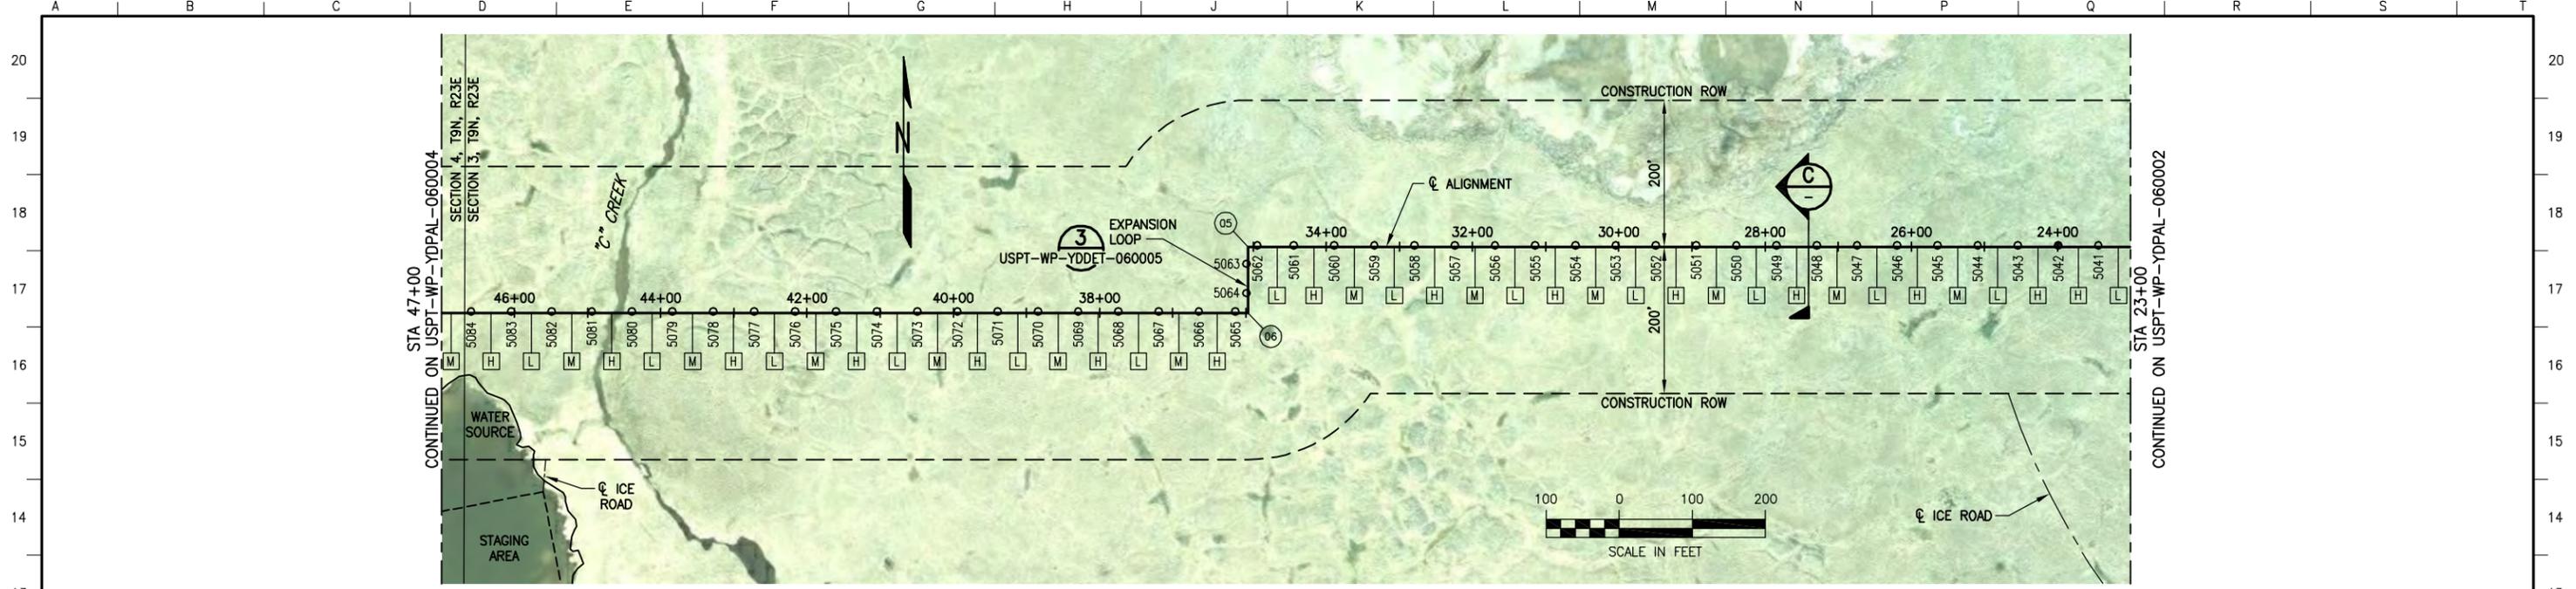POINT #	DESCRIPTION	STATION	NORTHING	EASTING	ANGLE
05	PI	35+06.76	5910832.16	1605145.43	90.0°
06	PI	35+96.76	5910742.16	1605145.43	90.0°

PIPE SUPPORT IDENTIFICATION

VS-06-704-XXXX

VERTICAL SUPPORT
LOCATION CODE
UNIT/MODULE
SEQUENTIAL NUMBER
(SHOWN ON PLAN & PROFILE)



SUPPORT TYPE NOMENCLATURE

XX-XX-XX-XX-XX

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GUIDE = "G"
SLIDE = "S"
ANCHOR = "A"
HSM LENGTH (FT)
NOMINAL VSM DIAMETER (IN)
VSM LENGTH (FT)
MINIMUM EMBEDMENT (FT)

- NOTES**
- CENTERLINE OF ALIGNMENT = CENTERLINE OF 12"-LN-644-0049-MEBEV-3"H.
 - STATIONING ALONG ALIGNMENT REFLECTS HORIZONTAL DISTANCE.
 - HORIZONTAL DATUM IS NAD83, ALASKA STATE PLANE ZONE 3, US FOOT.
 - VERTICAL DATUM IS POINT THOMSON UNIT MEAN LOWER LOW WATER (PTU MLLW).
 - FOR GUIDED AND ANCHORED SUPPORT DETAILS, SEE USPT-WP-YDDET-060010.
 - FOR SLIDING SUPPORT DETAILS, SEE USPT-WP-YDDET-060011.
 - FOR WIND-INDUCED VIBRATION MITIGATION PLAN AND TUNED VIBRATION ABSORBER (TVA) INSTALLATION, SEE USPT-WP-YDWIV-060001 AND USPT-WP-YDWIV-270001.

- LEGEND**
- GUIDED OR SLIDING SUPPORT
 - ANCHORED SUPPORT
 - # PI OR VPI LOCATION
 - H HIGH FREQUENCY TVA
 - L LOW FREQUENCY TVA
 - M MEDIUM FREQUENCY TVA

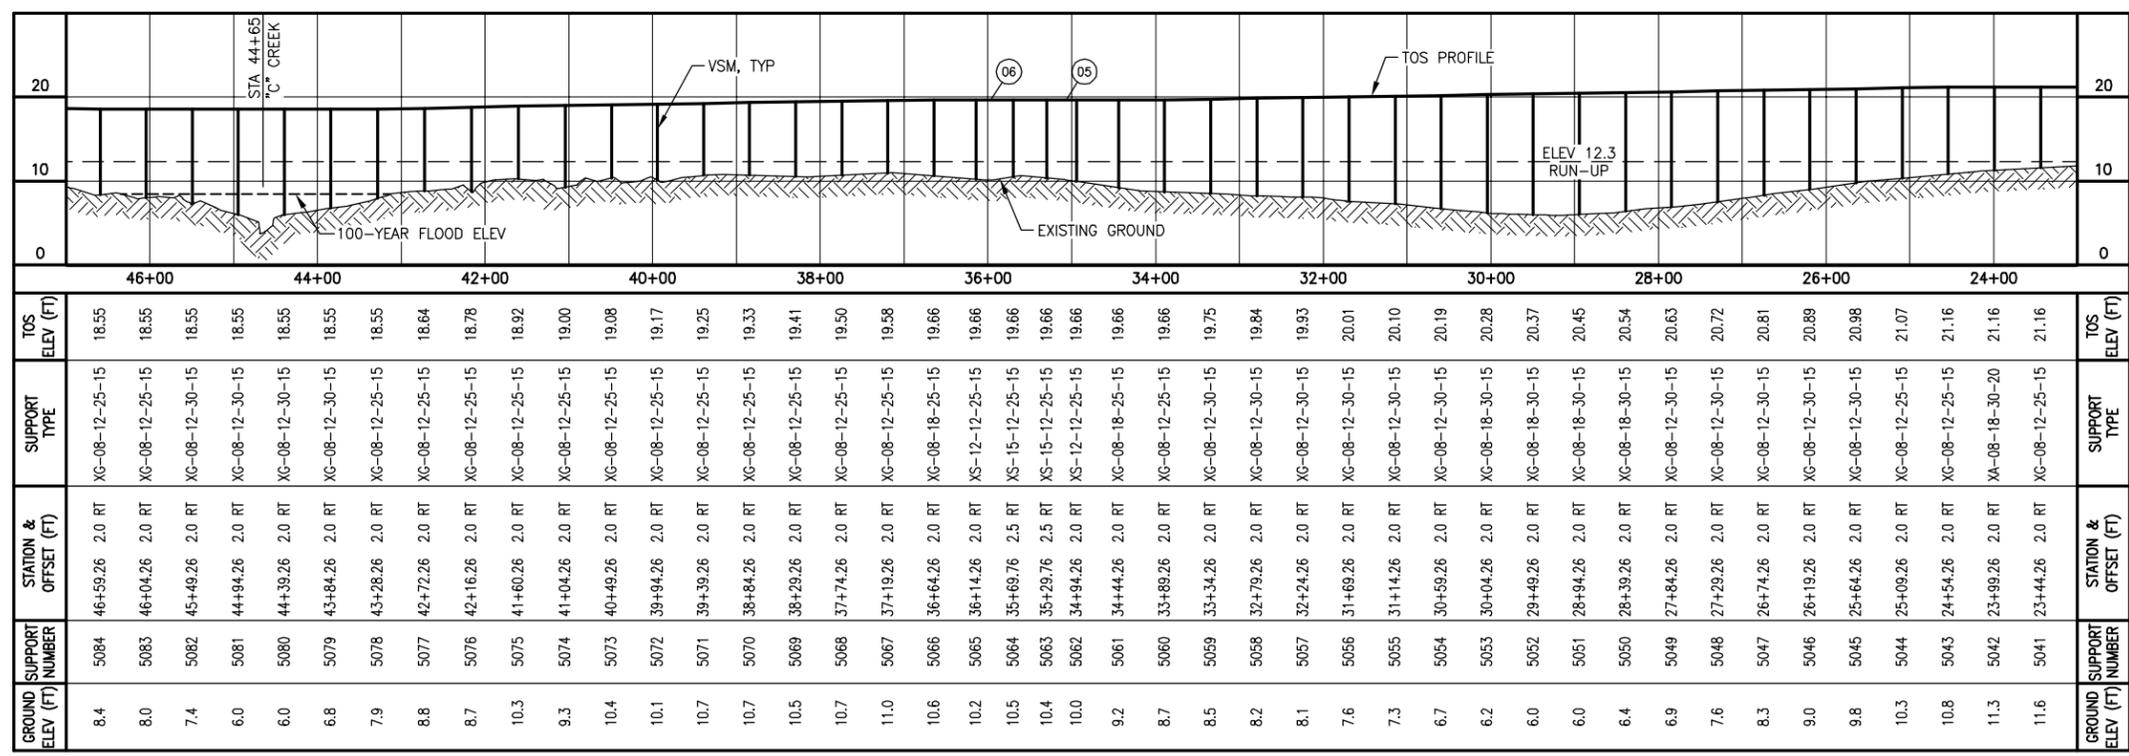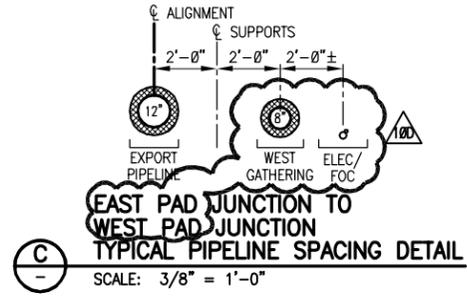

REFERENCE DRAWINGS	DESCRIPTION
USPT-WP-YDSYM-060001	PROJECT NOTES, ABBREVIATIONS AND LEGEND
USPT-WP-YDPAL-060001	SITE PLAN
USPT-WP-YDDET-060001	TYPICAL EXPANSION LOOP DETAIL
USPT-WP-YDDET-060010	GUIDED AND ANCHORED SUPPORT DETAILS
USPT-WP-YDDET-060011	SLIDING SUPPORT DETAILS
USPT-WP-YDWIV-060001	WIND-INDUCED VIBRATION MITIGATION PLAN


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10	12/28/11	ISSUED FOR CONSTRUCTION	RFH	JAG	PAC	GMP
10A	05/14/12	ISSUED FOR INTERNAL REVIEW	RFH	JAG	PAC	GMP
10B	05/21/12	ISSUED FOR SQUAD CHECK	RFH	JAG	PAC	GMP
10C	06/08/12	ISSUED FOR CLIENT REVIEW	RFH	JAG	PAC	GMP
10D	06/29/12	ISSUED FOR QUOTE	RFH	JAG	PAC	GMP

**PRELIMINARY
NOT FOR
CONSTRUCTION**

POINT THOMSON		ALASKA	
MODULE	DRAWN	DATE	SCALE
	R. HOBBS	12/11	AS SHOWN
DRAWING NO.	SHEET	CHK	APPD
USPT-WP-YDPAL-060003-001	1 of 1	JAG	PAC

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LOCATION	MATERIAL	WALL THK (IN)	FBE COATING (MIL)	INSULATION (IN)
47+00 TO 79+00	12.75" DIA API 5L X65	0.500	SHOP: 20 MIN, 32 MAX FIELD: 25 MIN, 39 MAX	3.0
47+00 TO 79+00	8.625" DIA DNV SMLS 450 L - UNS N08825	0.812	SHOP: 20 MIN, 32 MAX FIELD: 25 MIN, 39 MAX	3.0

PIPE SUPPORT IDENTIFICATION

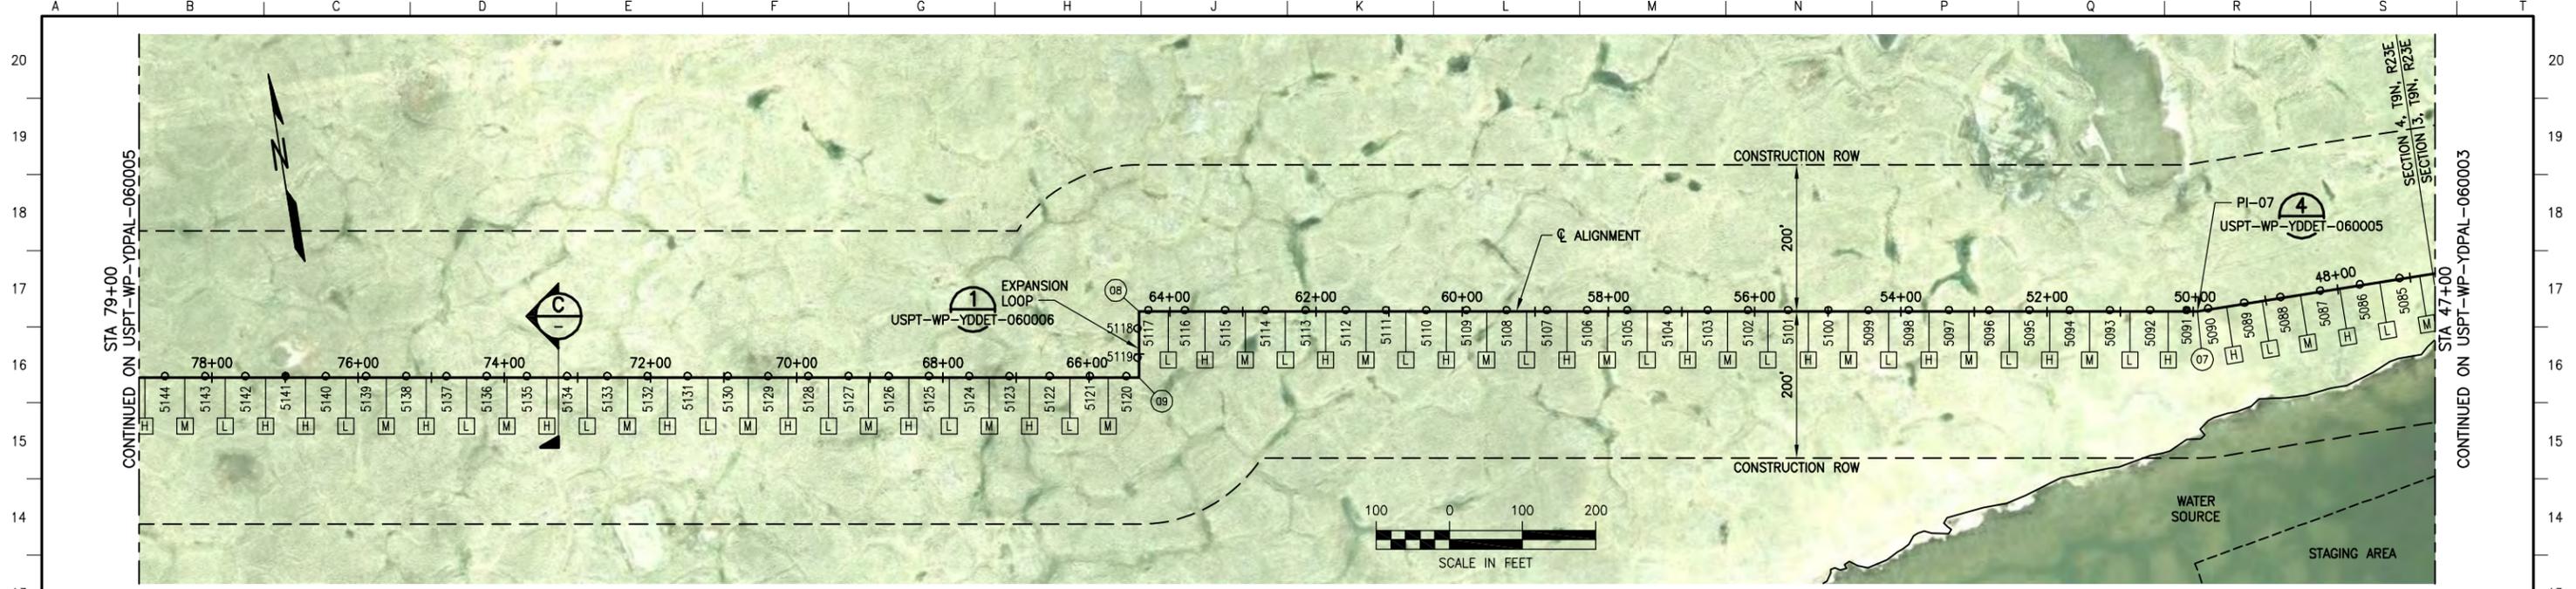VS-06-704-XXXX

VERTICAL SUPPORT
LOCATION CODE
UNIT/MODULE
SEQUENTIAL NUMBER
(SHOWN ON PLAN & PROFILE)


SUPPORT TYPE NOMENCLATURE

XX-XX-XX-XX-XX


EXPORT = "X"
GUIDE = "G"
SLIDE = "S"
ANCHOR = "A"
HSM LENGTH (FT)
NOMINAL VSM DIAMETER (IN)
VSM LENGTH (FT)
MINIMUM EMBEDMENT (FT)

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 - FOR SLIDING SUPPORT DETAILS, SEE USPT-WP-YDDET-060011.
 - FOR WIND-INDUCED VIBRATION MITIGATION PLAN AND TUNED VIBRATION ABSORBER (TVA) INSTALLATION, SEE USPT-WP-YDWIV-060001 AND USPT-WP-YDWIV-270001.

- LEGEND**
- GUIDED OR SLIDING SUPPORT
 - ANCHORED SUPPORT
 - # PI OR VPI LOCATION
 - H HIGH FREQUENCY TVA
 - L LOW FREQUENCY TVA
 - M MEDIUM FREQUENCY TVA

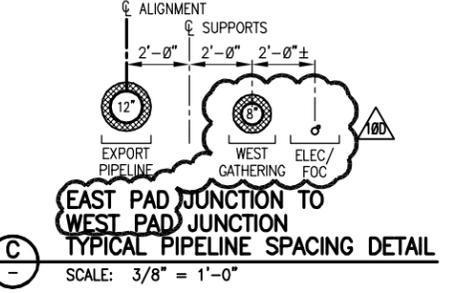

POINT #	DESCRIPTION	STATION	NORTHING	EASTING	ANGLE
07	PI	49+94.26	5910742.16	1603747.93	90.0°
08	PI	64+41.76	5910968.59	1602318.25	90.0°
09	PI	65+31.76	5910879.70	1602304.18	90.0°

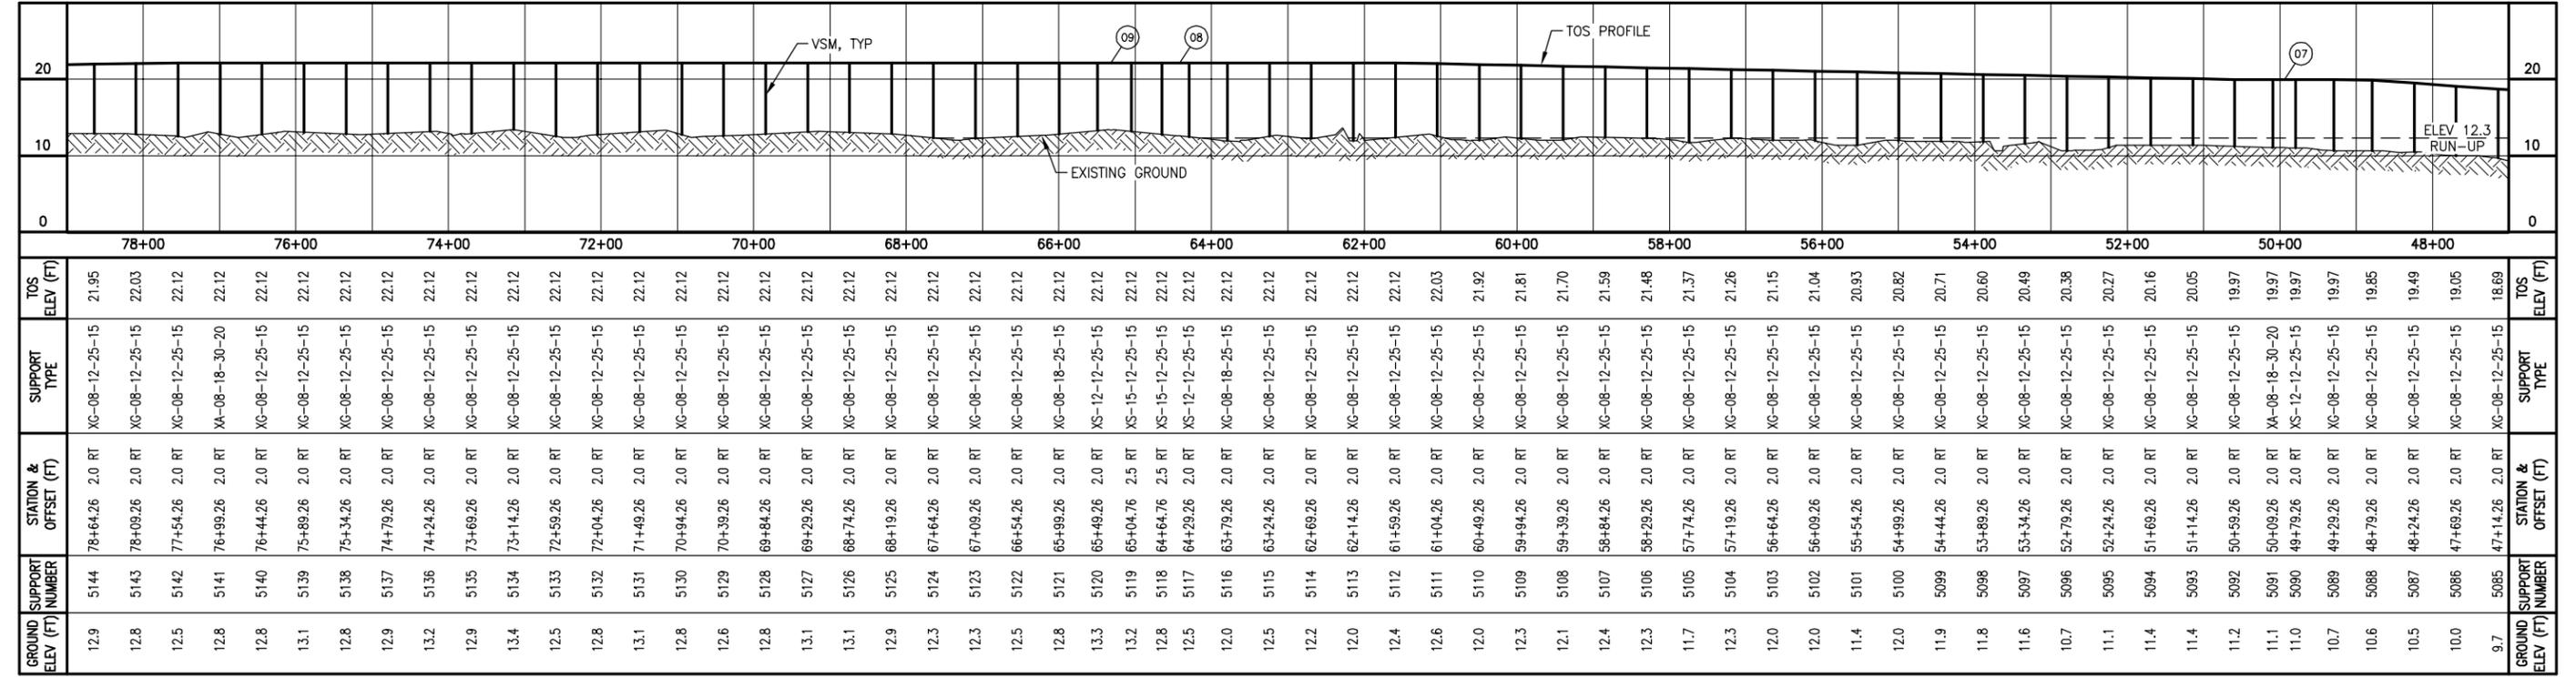

REFERENCE DRAWINGS	DESCRIPTION
USPT-WP-YDSYM-060001	PROJECT NOTES, ABBREVIATIONS AND LEGEND
USPT-WP-YDPAL-060001	SITE PLAN
USPT-WP-YDDET-060001	TYPICAL EXPANSION LOOP DETAIL
USPT-WP-YDDET-060010	GUIDED AND ANCHORED SUPPORT DETAILS
USPT-WP-YDDET-060011	SLIDING SUPPORT DETAILS
USPT-WP-YDWIV-060001	WIND-INDUCED VIBRATION MITIGATION PLAN

**PRELIMINARY
NOT FOR
CONSTRUCTION**

REV	DATE	DESCRIPTION	BY	CHK	APPD	PROJ
10	12/28/11	ISSUED FOR CONSTRUCTION	RFH	JAG	PAC	GMP
10A	05/14/12	ISSUED FOR INTERNAL REVIEW	RFH	JAG	PAC	GMP
10B	05/21/12	ISSUED FOR SQUAD CHECK	RFH	JAG	PAC	GMP
10C	06/08/12	ISSUED FOR CLIENT REVIEW	RFH	JAG	PAC	GMP
10D	06/29/12	ISSUED FOR QUOTE	RFH	JAG	PAC	GMP

ExxonMobil
Development


WorleyParsons FLUOR

Baker

EXPORT PIPELINE - PIPELINE PIPELINE ALIGNMENT SHEET PLAN & PROFILE STA 47+00 TO STA 79+00			
POINT THOMSON	ALASKA	MODULE	DRAWN
R. HOBBS	12/11	SCALE	AS SHOWN
DRAWING NO.	USPT-WP-YDPAL-060004-001	CHEK	JAG
SHEET	1 of 1	APPD	PAC
REV	10D		

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FILENAME: USPT-WP-YDPAL-060004-001

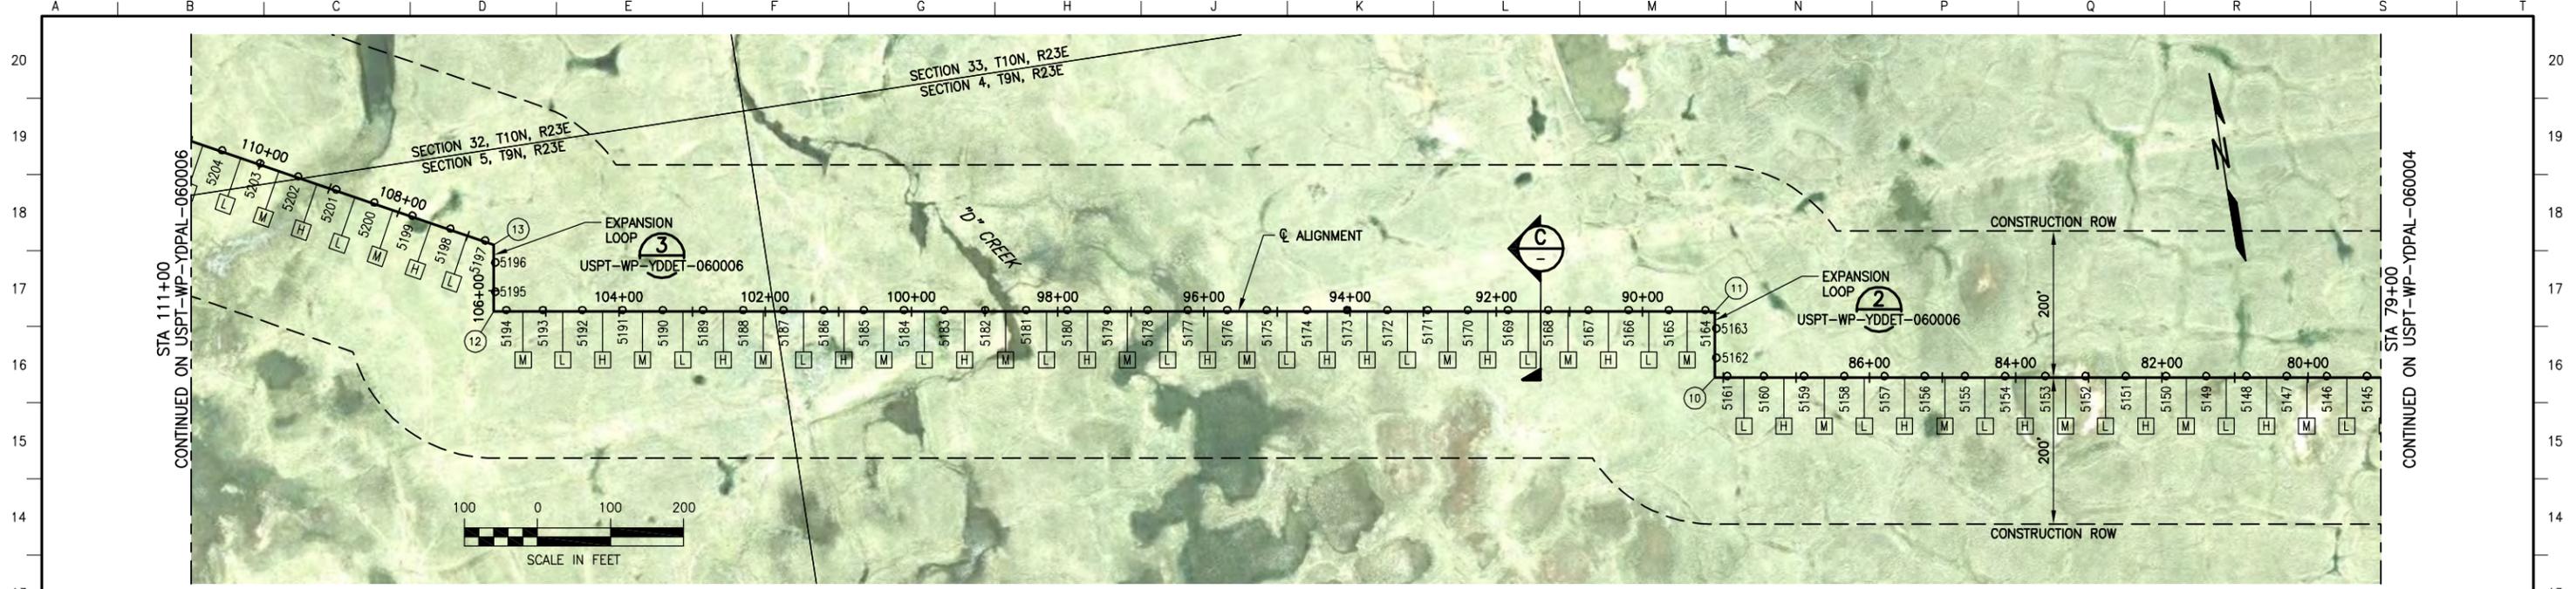

LOCATION	MATERIAL	WALL THK (IN)	FBE COATING (MIL)	INSULATION (IN)
79+00 TO 111+00	12.75" DIA API 5L X65	0.500	SHOP: 20 MIN, 32 MAX FIELD: 25 MIN, 39 MAX	3.0
79+00 TO 111+00	8.625" DIA DNV SMLS 450 L - UNS N08825	0.812 0.118	SHOP: 20 MIN, 32 MAX FIELD: 25 MIN, 39 MAX	3.0

POINT #	DESCRIPTION	STATION	NORTHING	EASTING	ANGLE
10	PI	88+11.76	5911236.37	1600052.25	90.0°
11	PI	89+01.76	5911325.27	1600066.33	90.0°
12	PI	105+71.76	5911586.51	1598416.89	90.0°
13	PI	106+62.50	5911676.14	1598431.08	71.11°

PIPE SUPPORT IDENTIFICATION

VS-06-704-XXXX

VERTICAL SUPPORT
LOCATION CODE
UNIT/MODULE
SEQUENTIAL NUMBER (SHOWN ON PLAN & PROFILE)



SUPPORT TYPE NOMENCLATURE

XX-XX-XX-XX-XX

EXPORT = "X"
GUIDE = "G"
SLIDE = "S"
ANCHOR = "A"
HSM LENGTH (FT)
NOMINAL VSM DIAMETER (IN)
VSM LENGTH (FT)
MINIMUM EMBEDMENT (FT)

- NOTES**
- CENTERLINE OF ALIGNMENT = CENTERLINE OF 12"-LN-644-0049-ME8EV-3"H.
 - STATIONING ALONG ALIGNMENT REFLECTS HORIZONTAL DISTANCE.
 - HORIZONTAL DATUM IS NAD83, ALASKA STATE PLANE ZONE 3, US FOOT.
 - VERTICAL DATUM IS POINT THOMSON UNIT MEAN LOWER LOW WATER (PTU MLLW).
 - FOR GUIDED AND ANCHORED SUPPORT DETAILS, SEE USPT-WP-YDDET-060010.
 - FOR SLIDING SUPPORT DETAILS, SEE USPT-WP-YDDET-060011.
 - FOR WIND-INDUCED VIBRATION MITIGATION PLAN AND TUNED VIBRATION ABSORBER (TVA) INSTALLATION, SEE USPT-WP-YDWIV-060001 AND USPT-WP-YDWIV-270001.

- LEGEND**
- GUIDED OR SLIDING SUPPORT
 - ANCHORED SUPPORT
 - ⊙ PI OR VPI LOCATION
 - ⊠ HIGH FREQUENCY TVA
 - ⊡ LOW FREQUENCY TVA
 - ⊞ MEDIUM FREQUENCY TVA

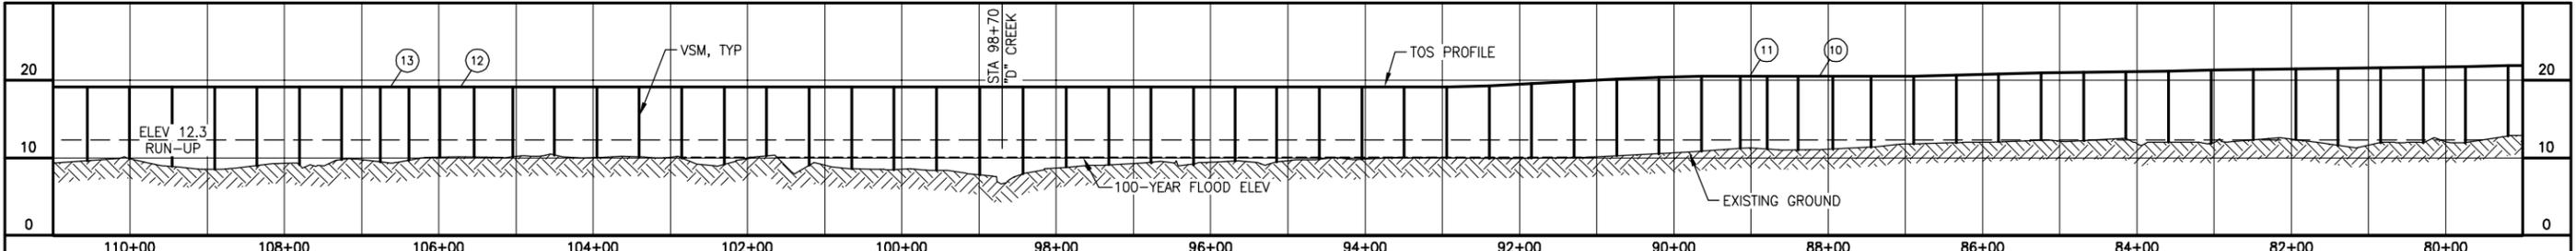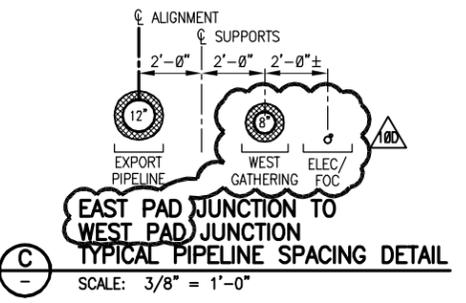

GROUND ELEV (FT)	SUPPORT NUMBER	STATION & OFFSET (FT)	SUPPORT TYPE	TOS ELEV (FT)
9.6	5204	110+55.54 2.0 RT	XG-08-12-25-15	19.17
9.9	5203	110+00.54 2.0 RT	XG-08-12-25-15	19.17
8.9	5202	109+45.54 2.0 RT	XG-08-12-25-15	19.17
8.5	5201	108+90.54 2.0 RT	XG-08-12-25-15	19.17
9.0	5200	108+35.54 2.0 RT	XG-08-12-25-15	19.17
9.1	5199	107+80.54 2.0 RT	XG-08-12-25-15	19.17
9.8	5198	107+25.54 2.0 RT	XG-08-18-25-15	19.17
9.5	5197	106+75.54 2.0 RT	XG-12-12-25-15	19.17
9.7	5196	106+38.76 2.5 RT	XG-15-12-25-15	19.17
10.1	5195	105+98.76 2.5 RT	XG-15-12-25-15	19.17
10.1	5194	105+54.26 2.0 RT	XG-12-12-25-15	19.17
10.1	5193	105+04.26 2.0 RT	XG-08-18-25-15	19.17
10.4	5192	104+50.26 2.0 RT	XG-08-12-25-15	19.17
10.0	5191	103+95.26 2.0 RT	XG-08-12-25-15	19.17
10.1	5190	103+40.26 2.0 RT	XG-08-12-25-15	19.17
10.0	5189	102+85.26 2.0 RT	XG-08-12-25-15	19.17
9.2	5188	102+30.26 2.0 RT	XG-08-12-25-15	19.17
10.3	5187	101+75.26 2.0 RT	XG-08-12-25-15	19.17
9.0	5186	101+20.26 2.0 RT	XG-08-12-25-15	19.17
8.6	5185	100+65.26 2.0 RT	XG-08-12-25-15	19.17
8.5	5184	100+10.26 2.0 RT	XG-08-12-25-15	19.17
8.4	5183	99+55.26 2.0 RT	XG-08-12-25-15	19.17
7.8	5182	98+99.26 2.0 RT	XG-08-12-30-15	19.17
7.9	5181	98+43.26 2.0 RT	XG-08-12-30-15	19.17
8.8	5180	97+87.26 2.0 RT	XG-08-12-25-15	19.17
9.1	5179	97+32.26 2.0 RT	XG-08-12-25-15	19.17
9.4	5178	96+77.26 2.0 RT	XG-08-12-25-15	19.17
9.1	5177	96+22.26 2.0 RT	XG-08-12-25-15	19.17
9.6	5176	95+68.26 2.0 RT	XG-08-12-25-15	19.17
9.5	5175	95+14.26 2.0 RT	XG-08-12-25-15	19.17
9.9	5174	94+58.26 2.0 RT	XG-08-12-25-15	19.17
9.8	5173	94+04.26 2.0 RT	XA-08-18-30-20	19.17
10.0	5172	93+49.26 2.0 RT	XG-08-12-25-15	19.17
10.0	5171	92+94.26 2.0 RT	XG-08-12-25-15	19.17
9.9	5170	92+39.26 2.0 RT	XG-08-12-25-15	19.31
10.0	5169	91+84.26 2.0 RT	XG-08-12-25-15	19.59
10.0	5168	91+29.26 2.0 RT	XG-08-12-25-15	19.86
10.3	5167	90+74.26 2.0 RT	XG-08-12-25-15	20.14
10.5	5166	90+19.26 2.0 RT	XG-08-12-25-15	20.41
10.9	5165	89+64.26 2.0 RT	XG-08-18-25-15	20.55
11.2	5164	89+14.26 2.0 RT	XG-12-12-25-15	20.55
11.1	5163	88+78.76 2.5 RT	XG-15-12-25-15	20.55
11.0	5162	88+38.76 2.5 RT	XG-15-12-25-15	20.55
11.1	5161	87+94.26 2.0 RT	XG-12-12-25-15	20.55
11.4	5160	87+44.26 2.0 RT	XG-08-18-25-15	20.55
11.8	5159	86+89.26 2.0 RT	XG-08-12-25-15	20.55
12.0	5158	86+34.26 2.0 RT	XG-08-12-25-15	20.63
12.1	5157	85+79.26 2.0 RT	XG-08-12-25-15	20.80
12.3	5156	85+24.26 2.0 RT	XG-08-12-25-15	20.96
12.3	5155	84+69.26 2.0 RT	XG-08-12-25-15	21.04
12.5	5154	84+14.26 2.0 RT	XG-08-12-25-15	21.13
12.0	5153	83+59.26 2.0 RT	XG-08-12-25-15	21.21
11.9	5152	83+04.26 2.0 RT	XG-08-12-25-15	21.29
12.3	5151	82+49.26 2.0 RT	XG-08-12-25-15	21.37
12.4	5150	81+94.26 2.0 RT	XG-08-12-25-15	21.46
11.6	5149	81+39.26 2.0 RT	XG-08-12-25-15	21.54
12.0	5148	80+84.26 2.0 RT	XG-08-12-25-15	21.62
12.0	5147	80+29.26 2.0 RT	XG-08-12-25-15	21.70
12.0	5146	79+74.26 2.0 RT	XG-08-12-25-15	21.79
12.8	5145	79+19.26 2.0 RT	XG-08-12-25-15	21.87


REFERENCE DRAWINGS	DESCRIPTION
USPT-WP-YDSYM-060001	PROJECT NOTES, ABBREVIATIONS AND LEGEND
USPT-WP-YDPAL-060001	SITE PLAN
USPT-WP-YDDET-060001	TYPICAL EXPANSION LOOP DETAIL
USPT-WP-YDDET-060010	GUIDED AND ANCHORED SUPPORT DETAILS
USPT-WP-YDDET-060011	SLIDING SUPPORT DETAILS
USPT-WP-YDWIV-060001	WIND-INDUCED VIBRATION MITIGATION PLAN

REV	DATE	DESCRIPTION	BY	CHK	APPD	PROJ
10	12/28/11	ISSUED FOR CONSTRUCTION	RFH	JAG	PAC	GMP
10A	05/14/12	ISSUED FOR INTERNAL REVIEW	RFH	JAG	PAC	GMP
10B	05/21/12	ISSUED FOR SQUAD CHECK	RFH	JAG	PAC	GMP
10C	06/08/12	ISSUED FOR CLIENT REVIEW	RFH	JAG	PAC	GMP
10D	06/29/12	ISSUED FOR QUOTE	RFH	JAG	PAC	GMP

EXPORT PIPELINE - PIPELINE		PIPELINE ALIGNMENT SHEET	
PLAN & PROFILE			
STA 79+00 TO STA 111+00			
POINT THOMSON	DATE	SCALE	CHK JAG
MODULE	R. HOBBS	12/11	AS SHOWN
DRAWING NO.	USPT-WP-YDPAL-060005-001	SHEET	REV
		1 of 1	10D

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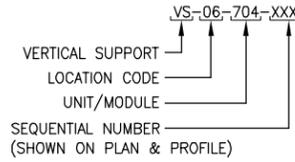
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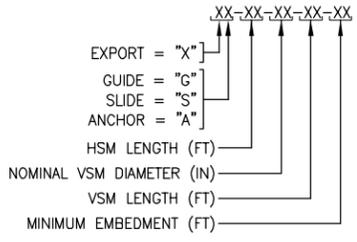
LOCATION	MATERIAL	WALL THK (IN)	FBE COATING (MIL)	INSULATION (IN)
111+00 TO 143+00	12.75" DIA API 5L X65	0.500	SHOP: 20 MIN, 32 MAX FIELD: 25 MIN, 39 MAX	3.0
111+00 TO 143+00	8.625" DIA DNV SMLS 450 L - UNS N08825	0.812 0.118	SHOP: 20 MIN, 32 MAX FIELD: 25 MIN, 39 MAX	3.0

POINT #	DESCRIPTION	STATION	NORTHING	EASTING	ANGLE
14	PI	118+79.76	5912245.48	1597355.19	90.0°
15	PI	119+68.70	5912166.87	1597313.59	62.11°

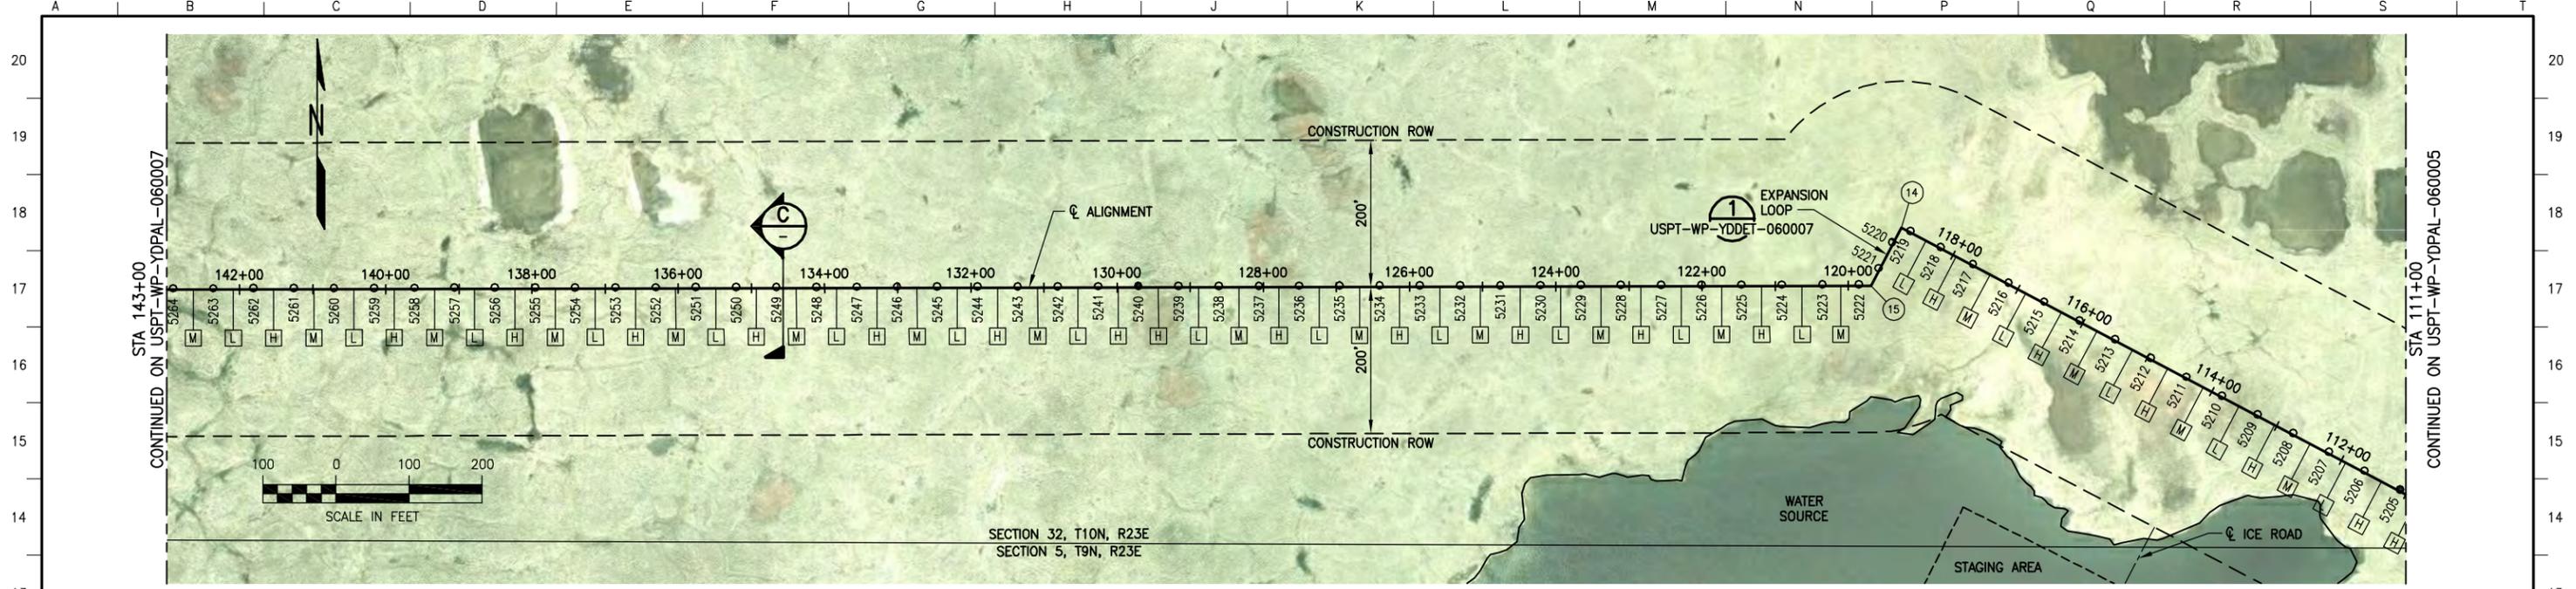PIPE SUPPORT IDENTIFICATION



SUPPORT TYPE NOMENCLATURE





NOTES

- CENTERLINE OF ALIGNMENT = CENTERLINE OF 12"-LN-644-0049-ME8EV-3"H.
- STATIONING ALONG ALIGNMENT REFLECTS HORIZONTAL DISTANCE.
- HORIZONTAL DATUM IS NAD83, ALASKA STATE PLANE ZONE 3, US FOOT.
- VERTICAL DATUM IS POINT THOMSON UNIT MEAN LOWER LOW WATER (PTU MLLW).
- FOR GUIDED AND ANCHORED SUPPORT DETAILS, SEE USPT-WP-YDDET-060010.
- FOR SLIDING SUPPORT DETAILS, SEE USPT-WP-YDDET-060011.
- FOR WIND-INDUCED VIBRATION MITIGATION PLAN AND TUNED VIBRATION ABSORBER (TVA) INSTALLATION, SEE USPT-WP-YDWIV-060001 AND USPT-WP-YDWIV-270001.

LEGEND

- GUIDED OR SLIDING SUPPORT
- ANCHORED SUPPORT
- # PI OR VPI LOCATION
- H HIGH FREQUENCY TVA
- L LOW FREQUENCY TVA
- M MEDIUM FREQUENCY TVA

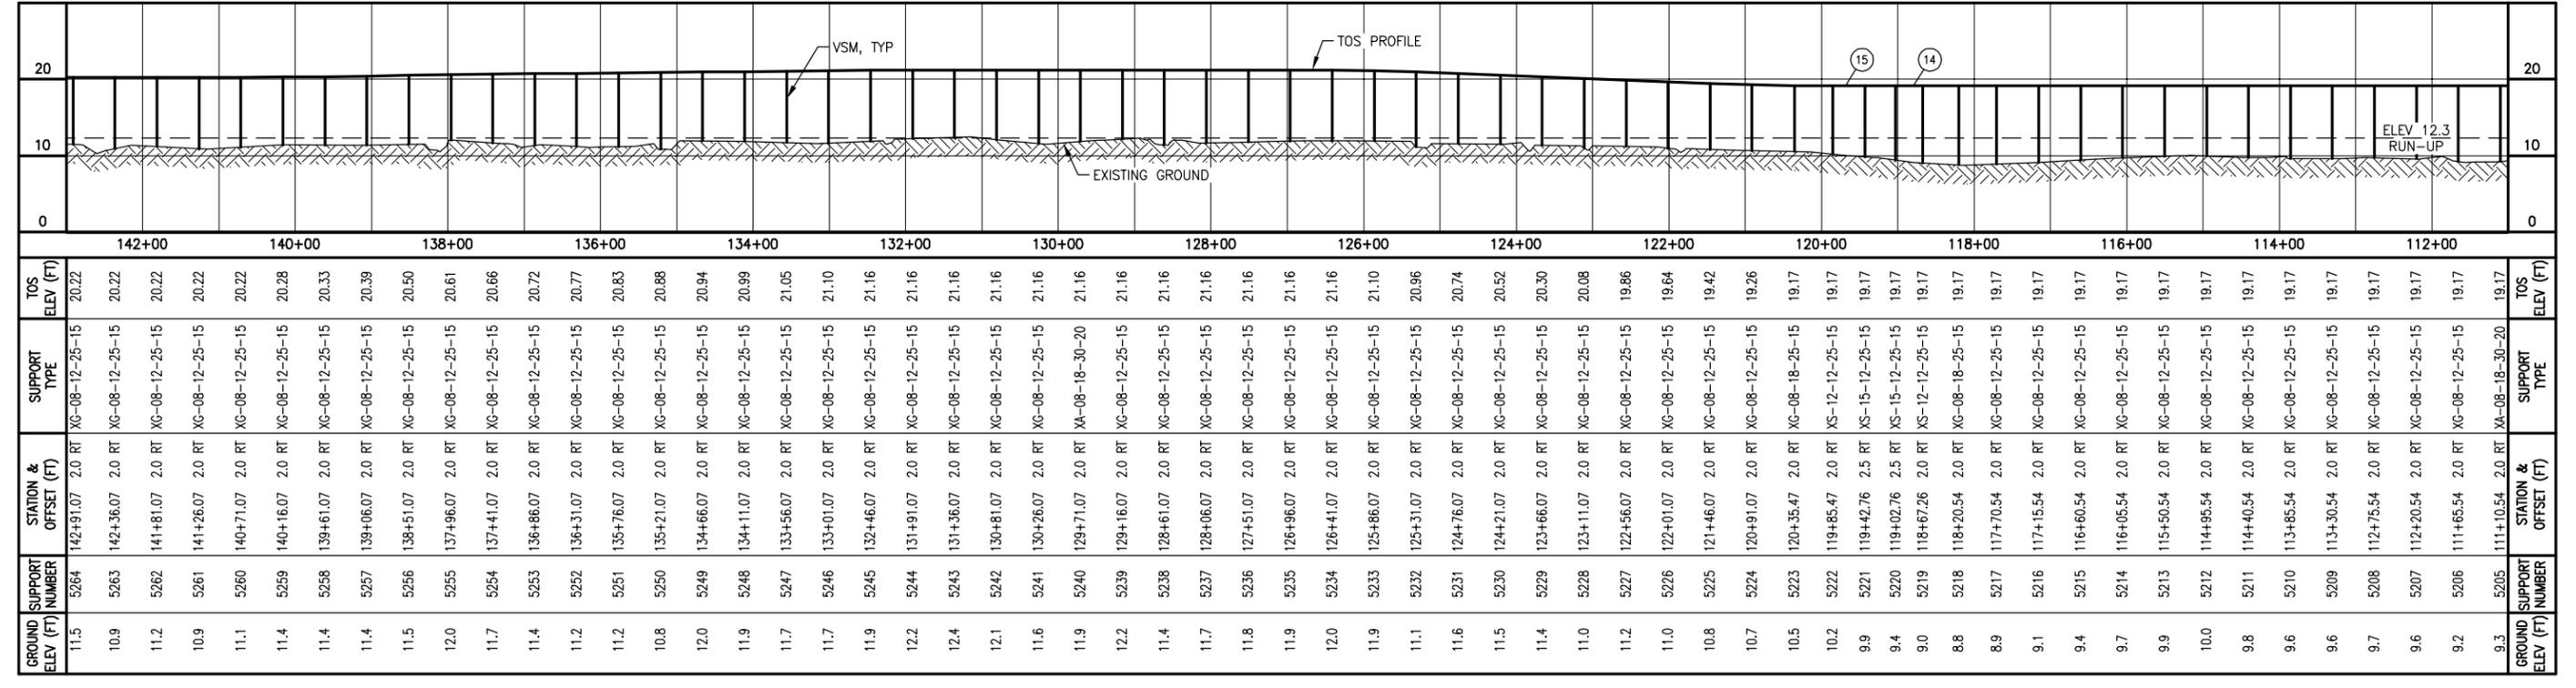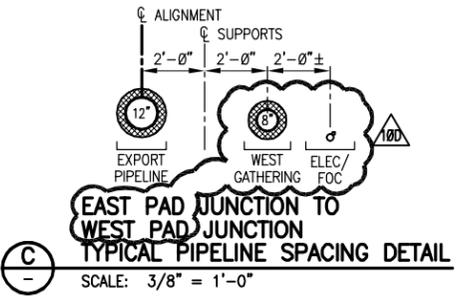

REFERENCE DRAWINGS	DESCRIPTION
USPT-WP-YDSYM-060001	PROJECT NOTES, ABBREVIATIONS AND LEGEND
USPT-WP-YDPAL-060001	SITE PLAN
USPT-WP-YDDET-060001	TYPICAL EXPANSION LOOP DETAIL
USPT-WP-YDDET-060010	GUIDED AND ANCHORED SUPPORT DETAILS
USPT-WP-YDDET-060011	SLIDING SUPPORT DETAILS
USPT-WP-YDWIV-060001	WIND-INDUCED VIBRATION MITIGATION PLAN


REV	DATE	DESCRIPTION	BY	CHK	APPD	PROJ
10	12/28/11	ISSUED FOR CONSTRUCTION	RFH	JAG	PAC	GMP
10A	05/14/12	ISSUED FOR INTERNAL REVIEW	RFH	JAG	PAC	GMP
10B	05/21/12	ISSUED FOR SQUAD CHECK	RFH	JAG	PAC	GMP
10C	06/08/12	ISSUED FOR CLIENT REVIEW	RFH	JAG	PAC	GMP
10D	06/29/12	ISSUED FOR QUOTE	RFH	JAG	PAC	GMP

POINT THOMSON		ALASKA	
MODULE	DRAWN	DATE	SCALE
	R. HOBBS	12/11	AS SHOWN
DRAWING NO.	SHEET		REV
USPT-WP-YDPAL-060006-001	1 of 1		10D

**PRELIMINARY
NOT FOR
CONSTRUCTION**

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FILENAME: USPT-WP-YDPAL-060006-001

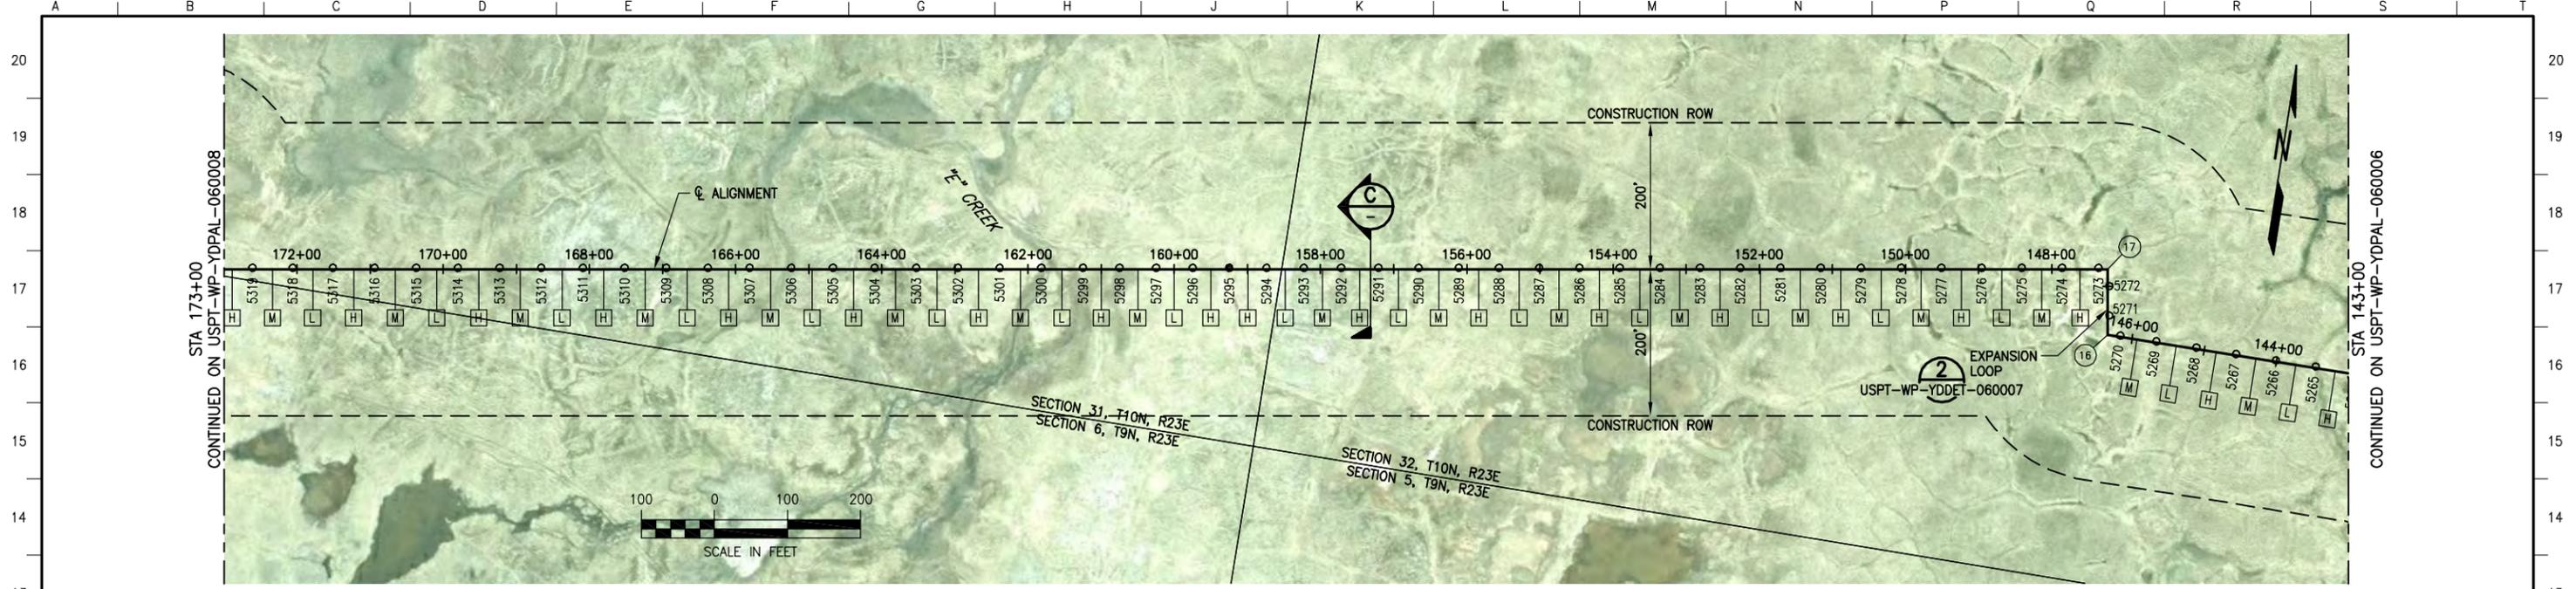

LOCATION	MATERIAL	WALL THK (IN)	FBE COATING (MIL)	INSULATION (IN)
143+00 TO 173+00	12.75" DIA API 5L X65	0.500	SHOP: 20 MIN, 32 MAX FIELD: 25 MIN, 39 MAX	3.0
143+00 TO 173+00	8.625" DIA DNV SMLS 450 L - UNS NO8825	0.812 0.118	SHOP: 20 MIN, 32 MAX FIELD: 25 MIN, 39 MAX	3.0

POINT #	DESCRIPTION	STATION	NORTHING	EASTING	ANGLE
16	PI	146+33.88	5912166.87	1594648.40	81.0°
17	PI	147+23.51	5912255.40	1594634.38	90.0°

PIPE SUPPORT IDENTIFICATION

VS-06-704-XXXX

VERTICAL SUPPORT
LOCATION CODE
UNIT/MODULE
SEQUENTIAL NUMBER
(SHOWN ON PLAN & PROFILE)

SUPPORT TYPE NOMENCLATURE



XX-XX-XX-XX-XX

EXPORT = "X"
GUIDE = "G"
SLIDE = "S"
ANCHOR = "A"

HSM LENGTH (FT)
NOMINAL VSM DIAMETER (IN)
VSM LENGTH (FT)
MINIMUM EMBEDMENT (FT)

- NOTES**
- CENTERLINE OF ALIGNMENT = CENTERLINE OF 12"-LN-644-0049-ME8EV-3"H.
 - STATIONING ALONG ALIGNMENT REFLECTS HORIZONTAL DISTANCE.
 - HORIZONTAL DATUM IS NAD83, ALASKA STATE PLANE ZONE 3, US FOOT.
 - VERTICAL DATUM IS POINT THOMSON UNIT MEAN LOWER LOW WATER (PTU MLLW).
 - FOR GUIDED AND ANCHORED SUPPORT DETAILS, SEE USPT-WP-YDDET-060010.
 - FOR SLIDING SUPPORT DETAILS, SEE USPT-WP-YDDET-060011.
 - FOR WIND-INDUCED VIBRATION MITIGATION PLAN AND TUNED VIBRATION ABSORBER (TVA) INSTALLATION, SEE USPT-WP-YDWIV-060001 AND USPT-WP-YDWIV-270001.

- LEGEND**
- GUIDED OR SLIDING SUPPORT
 - ANCHORED SUPPORT
 - ⊕ PI OR VPI LOCATION
 - H HIGH FREQUENCY TVA
 - L LOW FREQUENCY TVA
 - M MEDIUM FREQUENCY TVA

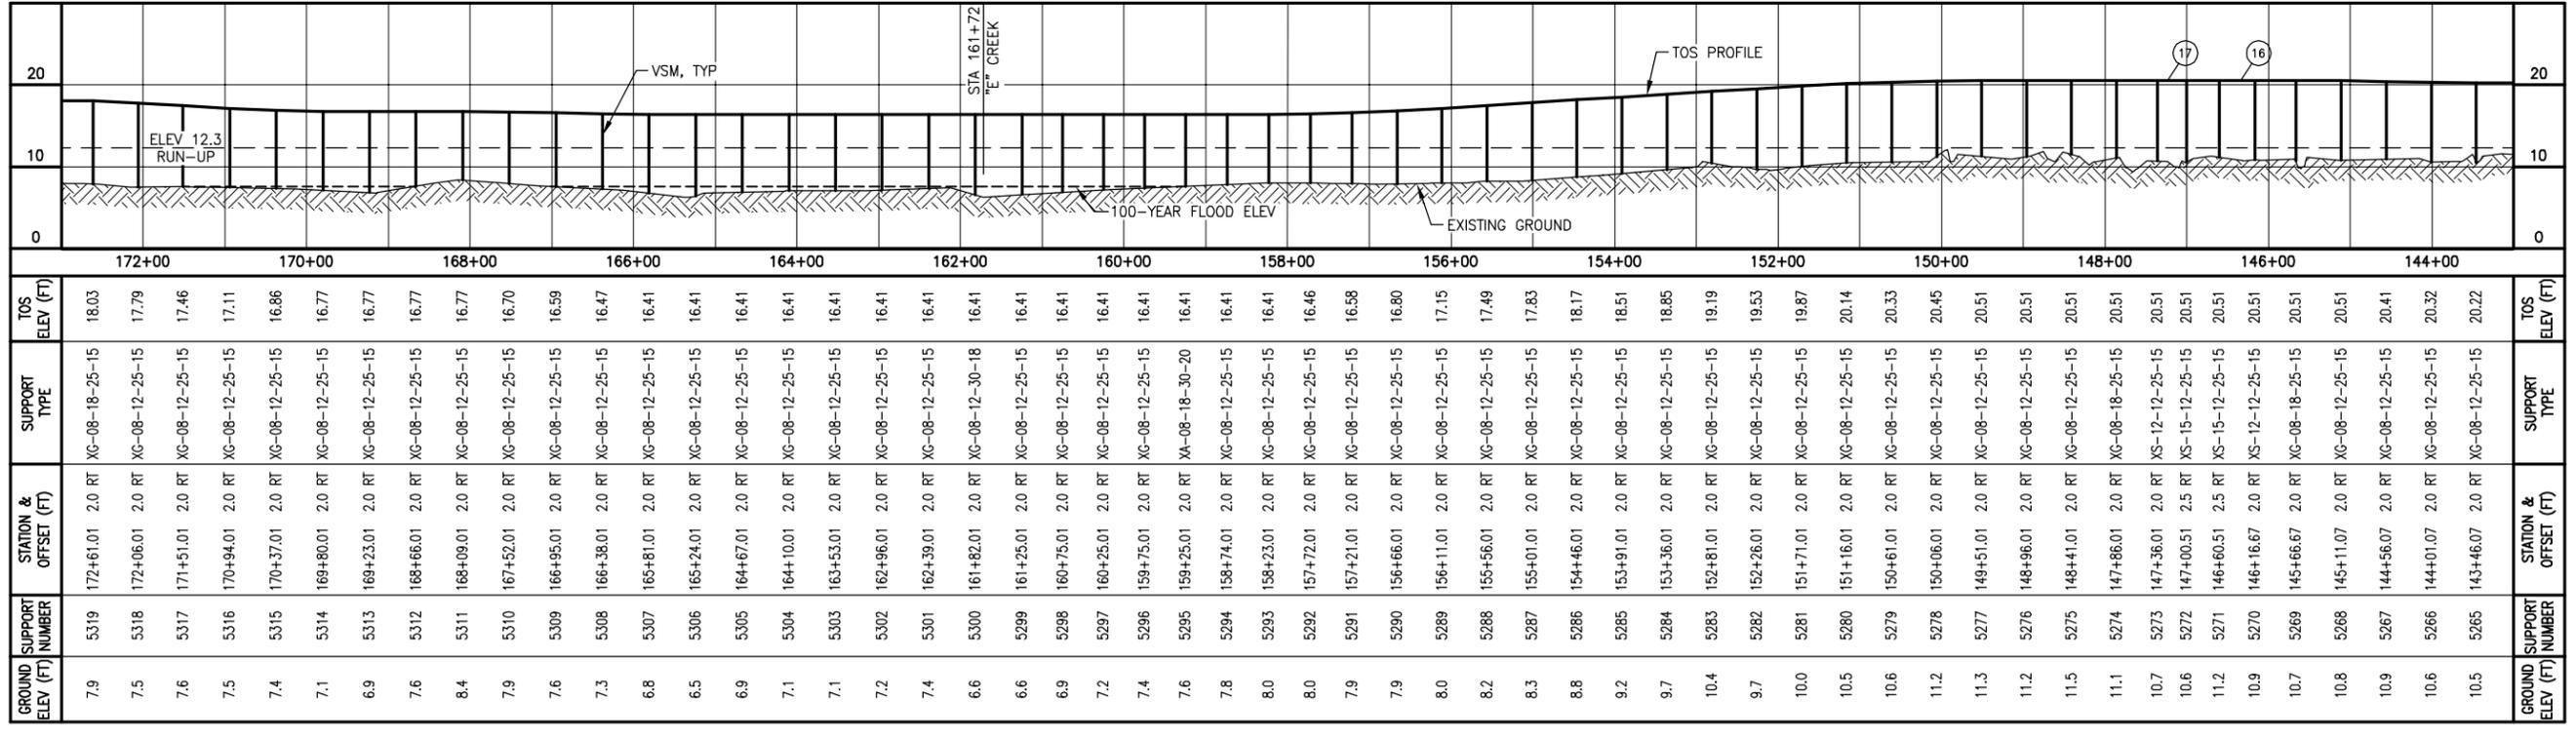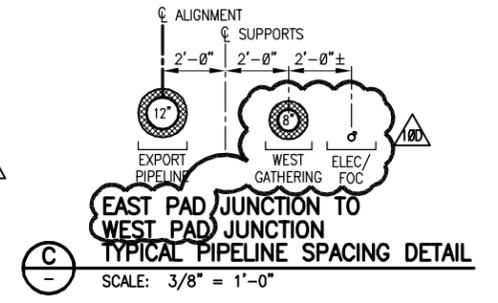

REFERENCE DRAWINGS	DESCRIPTION
USPT-WP-YDSYM-060001	PROJECT NOTES, ABBREVIATIONS AND LEGEND
USPT-WP-YDPAL-060001	SITE PLAN
USPT-WP-YDDET-060001	TYPICAL EXPANSION LOOP DETAIL
USPT-WP-YDDET-060010	GUIDED AND ANCHORED SUPPORT DETAILS
USPT-WP-YDDET-060011	SLIDING SUPPORT DETAILS
USPT-WP-YDWIV-060001	WIND-INDUCED VIBRATION MITIGATION PLAN

**PRELIMINARY
NOT FOR
CONSTRUCTION**

REV	DATE	DESCRIPTION	BY	CHK	APPD	PROJ
10	12/28/11	ISSUED FOR CONSTRUCTION	RFH	JAG	PAC	GMP
10A	05/14/12	ISSUED FOR INTERNAL REVIEW	RFH	JAG	PAC	GMP
10B	05/21/12	ISSUED FOR SQUAD CHECK	RFH	JAG	PAC	GMP
10C	06/08/12	ISSUED FOR CLIENT REVIEW	RFH	JAG	PAC	GMP
10D	06/29/12	ISSUED FOR QUOTE	RFH	JAG	PAC	GMP

**ExxonMobil
Development**


WorleyParsons FLUOR

Baker

EXPORT PIPELINE - PIPELINE PIPELINE ALIGNMENT SHEET PLAN & PROFILE STA 143+00 TO STA 173+00			
POINT THOMSON	ALASKA	DATE	SCALE
MODULE	DRAWN	DATE	SCALE
R. HOBBS	12/11	AS SHOWN	
DRAWING NO.	USPT-WP-YDPAL-060007-001	CHECKED	DATE
		APPD	DATE
		SHEET	REV
		1 of 1	10D

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FILENAME: USPT-WP-YDPAL-060007-001

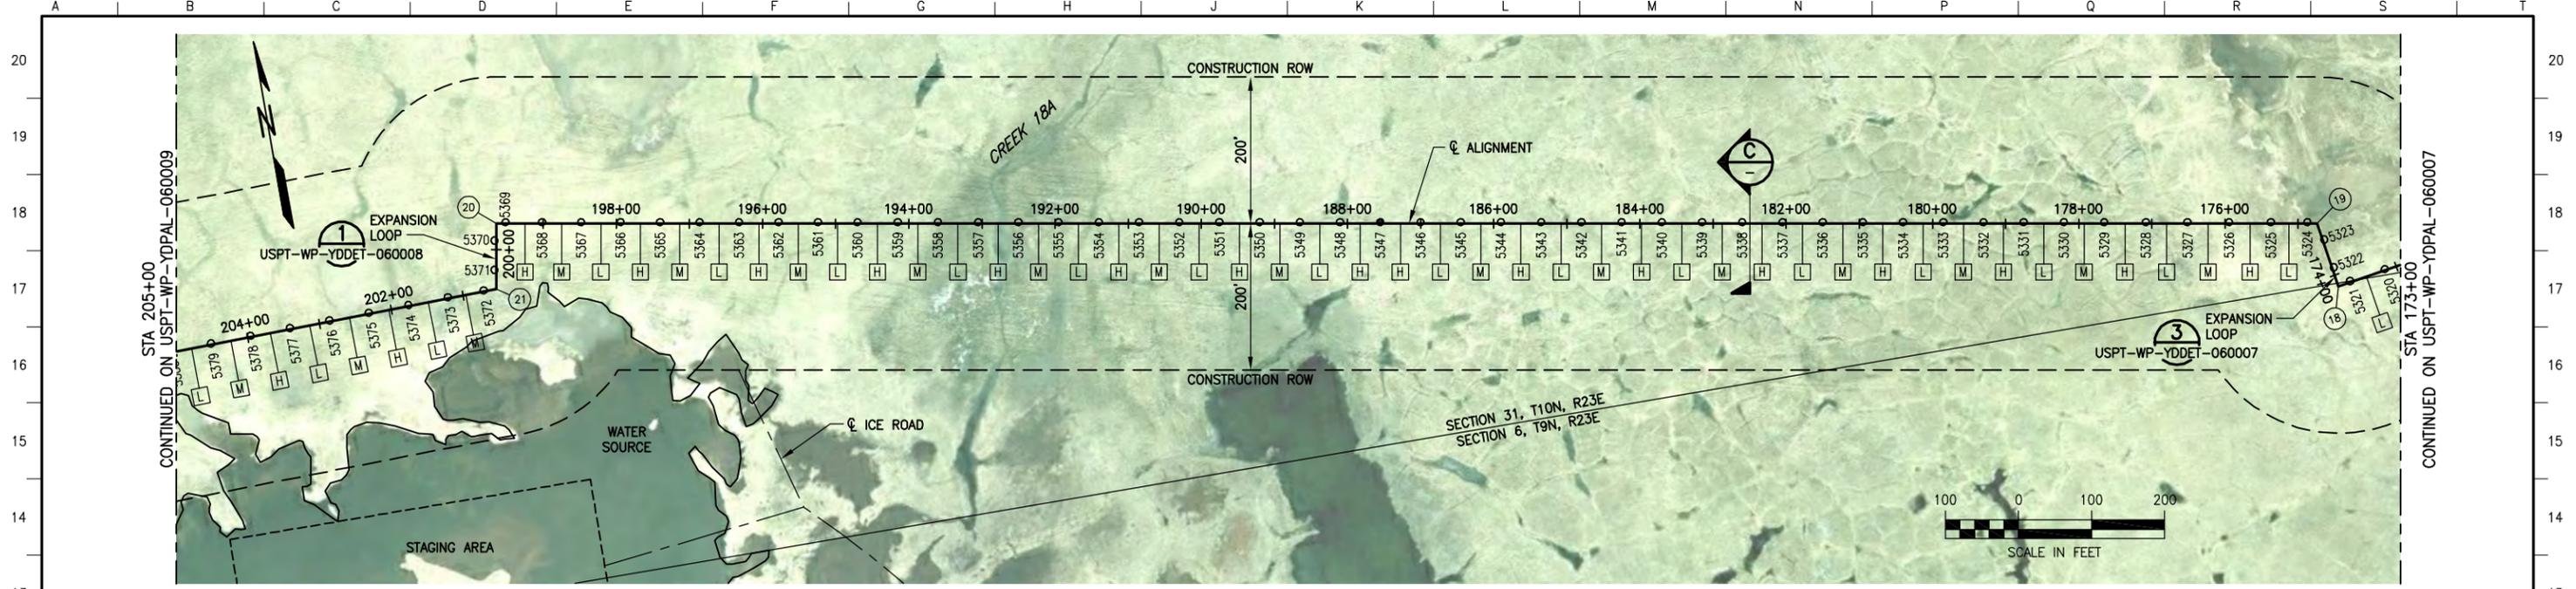

LOCATION	MATERIAL	WALL THK (IN)	FBE COATING (MIL)	INSULATION (IN)
173+00 TO 205+00	12.75" DIA API 5L X65	0.500	SHOP: 20 MIN, 32 MAX FIELD: 25 MIN, 39 MAX	3.0
173+00 TO 205+00	8.625" DIA DNV SMLS 450 L - UNS N08825	0.812 0.118	SHOP: 20 MIN, 32 MAX FIELD: 25 MIN, 39 MAX	3.0

POINT #	DESCRIPTION	STATION	NORTHING	EASTING	ANGLE
18	PI	173+83.51	5911839.28	1592007.13	90.0°
19	PI	174+74.25	5911928.91	1591992.93	71.0°
20	PI	199+64.22	5912361.29	1589540.79	90.0°
21	PI	200+53.78	5912273.10	1589525.24	79.0°

PIPE SUPPORT IDENTIFICATION

VS-06-704-XXXX

VERTICAL SUPPORT
LOCATION CODE
UNIT/MODULE
SEQUENTIAL NUMBER (SHOWN ON PLAN & PROFILE)

SUPPORT TYPE NOMENCLATURE



XX-XX-XX-XX-XX

EXPORT = "X"
GUIDE = "G"
SLIDE = "S"
ANCHOR = "A"

HSM LENGTH (FT)
NOMINAL VSM DIAMETER (IN)
VSM LENGTH (FT)
MINIMUM EMBEDMENT (FT)

- NOTES**
- CENTERLINE OF ALIGNMENT = CENTERLINE OF 12"-LN-644-0049-MEBEV-3"H.
 - STATIONING ALONG ALIGNMENT REFLECTS HORIZONTAL DISTANCE.
 - HORIZONTAL DATUM IS NAD83, ALASKA STATE PLANE ZONE 3, US FOOT.
 - VERTICAL DATUM IS POINT THOMSON UNIT MEAN LOWER LOW WATER (PTU MLLW).
 - FOR GUIDED AND ANCHORED SUPPORT DETAILS, SEE USPT-WP-YDDET-060010.
 - FOR SLIDING SUPPORT DETAILS, SEE USPT-WP-YDDET-060011.
 - FOR WIND-INDUCED VIBRATION MITIGATION PLAN AND TUNED VIBRATION ABSORBER (TVA) INSTALLATION, SEE USPT-WP-YDWIV-060001 AND USPT-WP-YDWIV-270001.

- LEGEND**
- GUIDED OR SLIDING SUPPORT
 - ANCHORED SUPPORT
 - # PI OR VPI LOCATION
 - H HIGH FREQUENCY TVA
 - L LOW FREQUENCY TVA
 - M MEDIUM FREQUENCY TVA

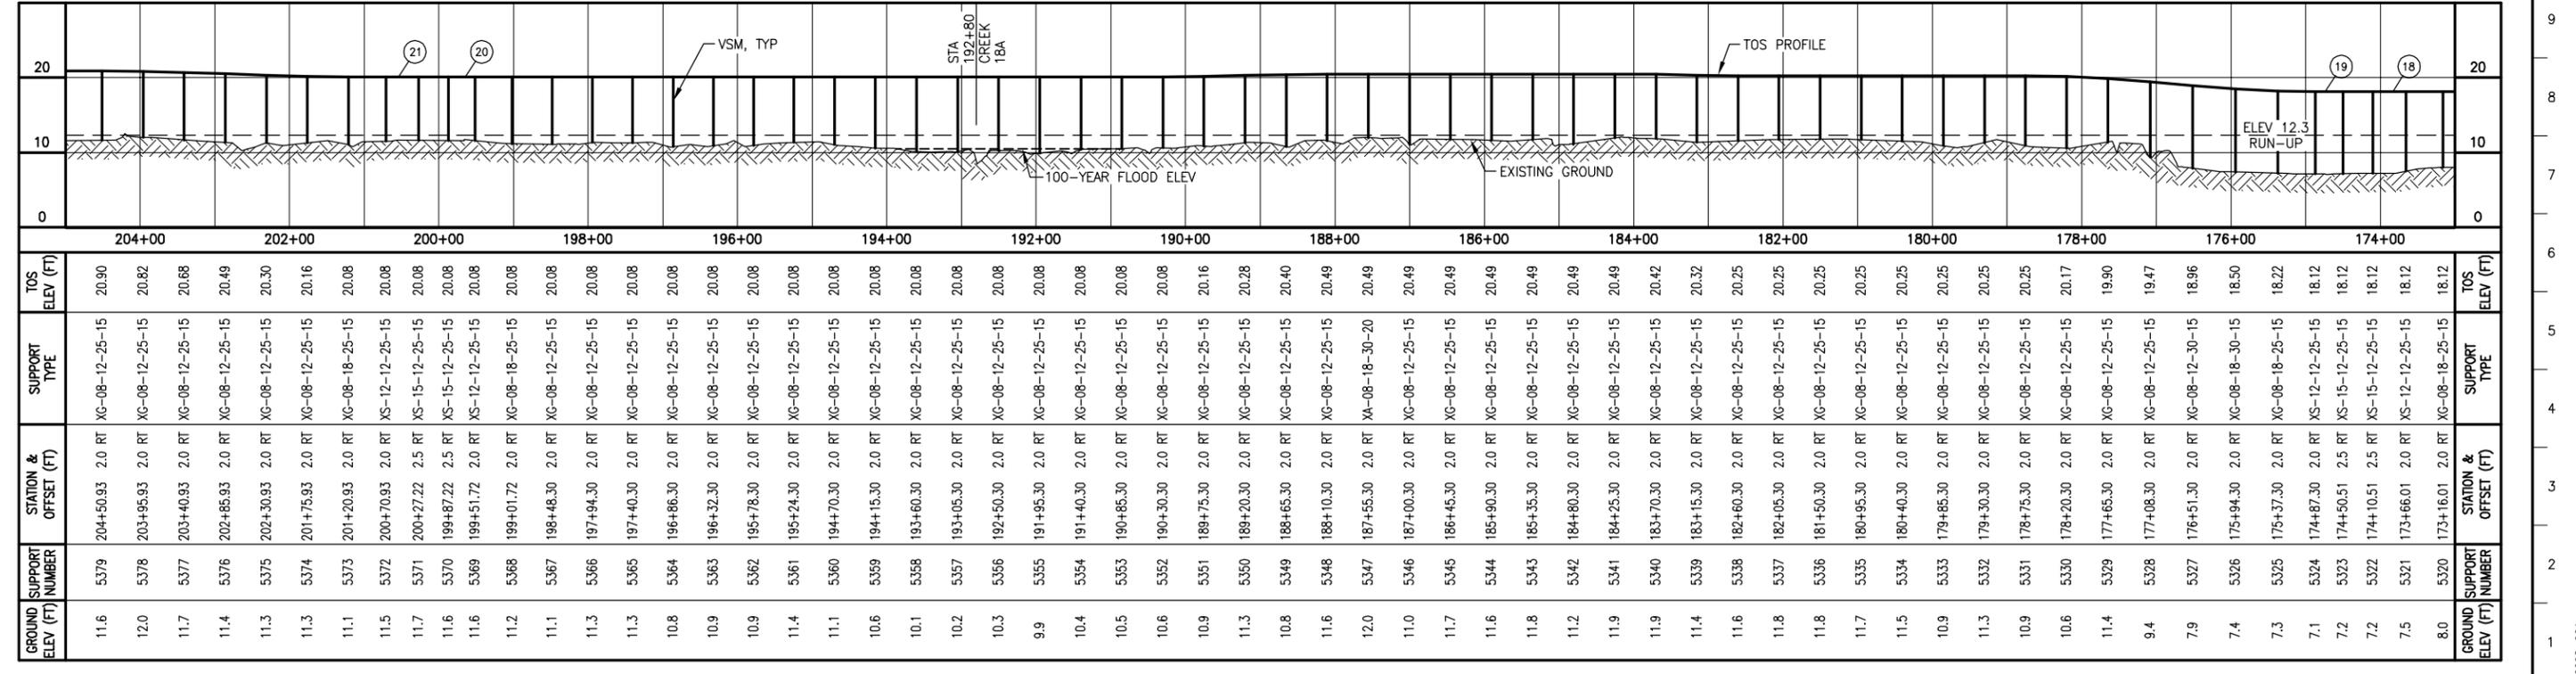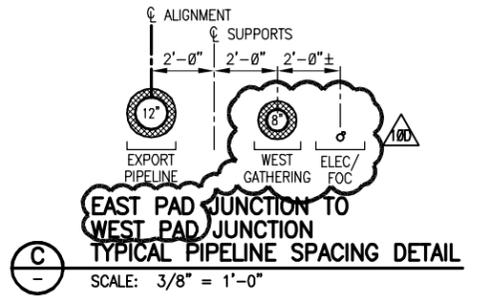

REFERENCE DRAWINGS	DESCRIPTION
USPT-WP-YDSYM-060001	PROJECT NOTES, ABBREVIATIONS AND LEGEND
USPT-WP-YDPAL-060001	SITE PLAN
USPT-WP-YDDET-060001	TYPICAL EXPANSION LOOP DETAIL
USPT-WP-YDDET-060010	GUIDED AND ANCHORED SUPPORT DETAILS
USPT-WP-YDDET-060011	SLIDING SUPPORT DETAILS
USPT-WP-YDWIV-060001	WIND-INDUCED VIBRATION MITIGATION PLAN

REV	DATE	DESCRIPTION	BY	CHK	APPD	PROJ
10	12/28/11	ISSUED FOR CONSTRUCTION	RFH	JAG	PAC	GMP
10A	05/14/12	ISSUED FOR INTERNAL REVIEW	RFH	JAG	PAC	GMP
10B	05/21/12	ISSUED FOR SQUAD CHECK	RFH	JAG	PAC	GMP
10C	06/08/12	ISSUED FOR CLIENT REVIEW	RFH	JAG	PAC	GMP
10D	06/29/12	ISSUED FOR QUOTE	RFH	JAG	PAC	GMP

PRELIMINARY NOT FOR CONSTRUCTION

ExxonMobil Development

WorleyParsons FLUOR Baker


EXPORT PIPELINE - PIPELINE ALIGNMENT SHEET
PLAN & PROFILE
STA 173+00 TO STA 205+00

MODULE	DRAWN	DATE	SCALE	CHK	JAG
	R. HOBBS	12/11	AS SHOWN	APPD	PAC
DRAWING NO.	USPT-WP-YDPAL-060008-001			SHEET	REV
				1 of 1	10D

POINT THOMSON ALASKA

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FILENAME: USPT-WP-YDPAL-060008-001

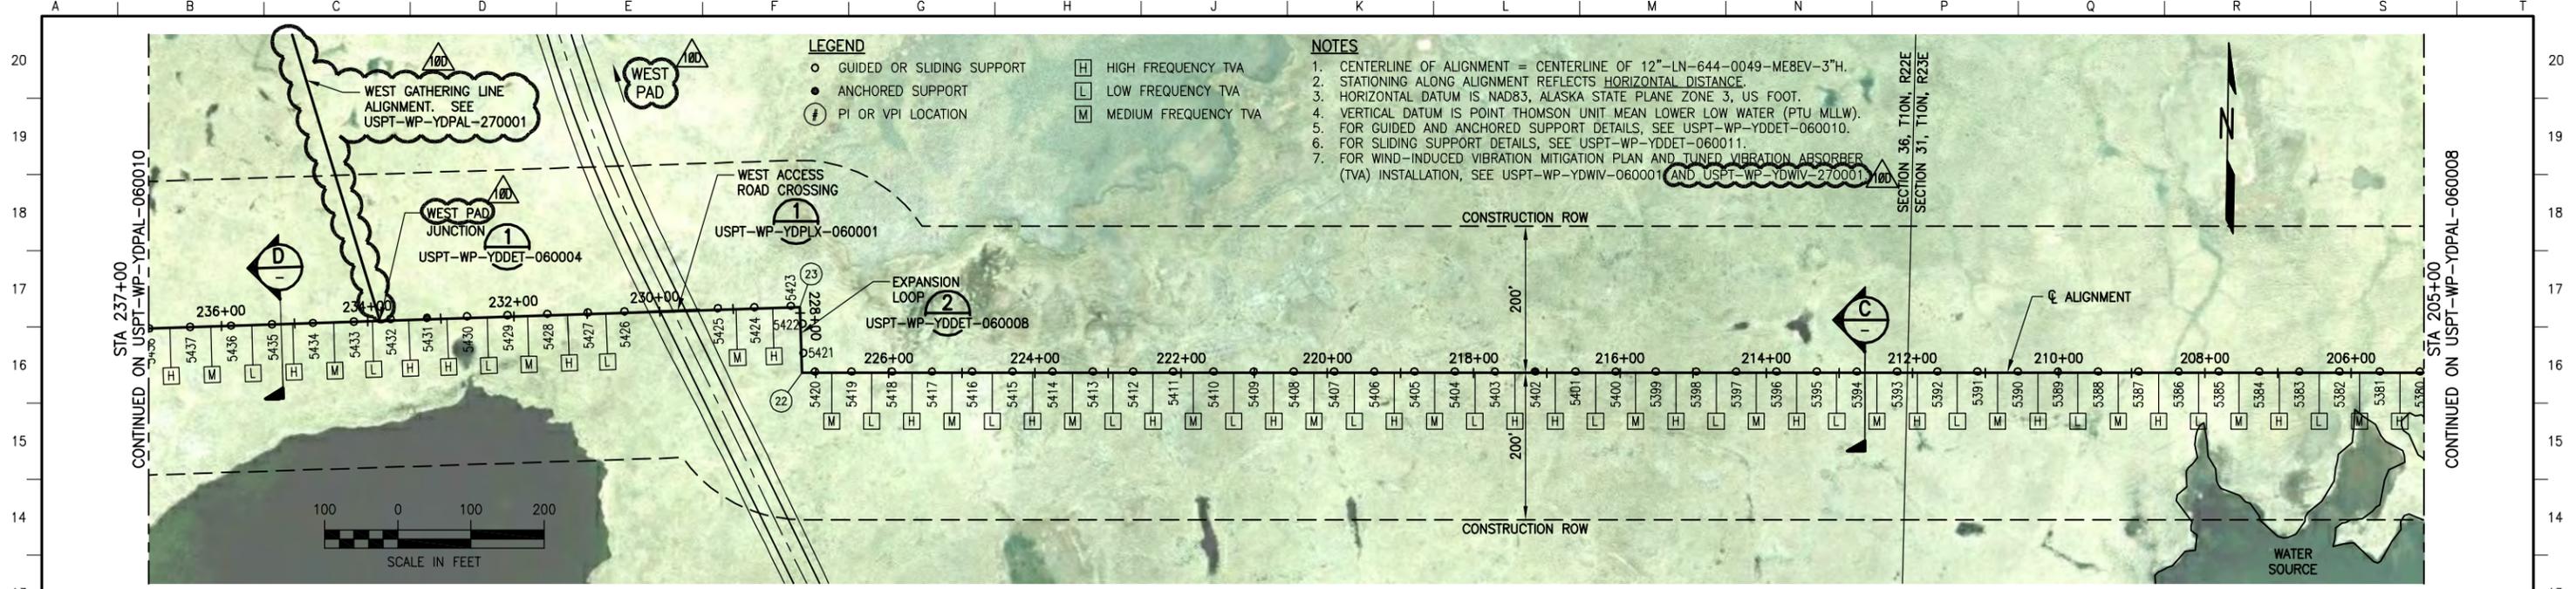

- LEGEND**
- GUIDED OR SLIDING SUPPORT
 - ANCHORED SUPPORT
 - ⊕ PI OR VPI LOCATION
 - ⊠ HIGH FREQUENCY TVA
 - ⊠ LOW FREQUENCY TVA
 - ⊠ MEDIUM FREQUENCY TVA






- NOTES**
- CENTERLINE OF ALIGNMENT = CENTERLINE OF 12"-LN-644-0049-MEDEV-3"H.
 - STATIONING ALONG ALIGNMENT REFLECTS HORIZONTAL DISTANCE.
 - HORIZONTAL DATUM IS NAD83, ALASKA STATE PLANE ZONE 3, US FOOT.
 - VERTICAL DATUM IS POINT THOMSON UNIT MEAN LOWER LOW WATER (PTU MLLW).
 - FOR GUIDED AND ANCHORED SUPPORT DETAILS, SEE USPT-WP-YDDET-060010.
 - FOR SLIDING SUPPORT DETAILS, SEE USPT-WP-YDDET-060011.
 - FOR WIND-INDUCED VIBRATION MITIGATION PLAN AND TUNED VIBRATION ABSORBER (TVA) INSTALLATION, SEE USPT-WP-YDWIV-060001 (AND USPT-WP-YDWIV-270001).

PIPELINE DATA TABLE

LOCATION	MATERIAL	WALL THK (IN)	FBE COATING (MIL)	INSULATION (IN)
205+00 TO 237+00	12.75" DIA API 5L X65	0.500	SHOP: 20 MIN, 32 MAX FIELD: 25 MIN, 39 MAX	3.0
205+00 TO 237+00	8.625" DIA DNV SMLS 450 L - UNS N08825	0.812 0.118	SHOP: 20 MIN, 32 MAX FIELD: 25 MIN, 39 MAX	3.0

COORDINATE TABLE

POINT #	DESCRIPTION	STATION	NORTHING	EASTING	ANGLE
22	PI	227+18.37	5912226.60	1586861.05	88.13°
23	PI	228+08.29	5912316.40	1586856.56	90.0°
23A	VPI	229+28.79	5912310.37	1586736.21	45.0°
23B	VPI	229+35.12	5912310.06	1586729.89	45.0°
23C	VPI	230+28.58	5912305.38	1586636.54	45.0°
23D	VPI	230+40.74	5912304.77	1586624.40	45.0°

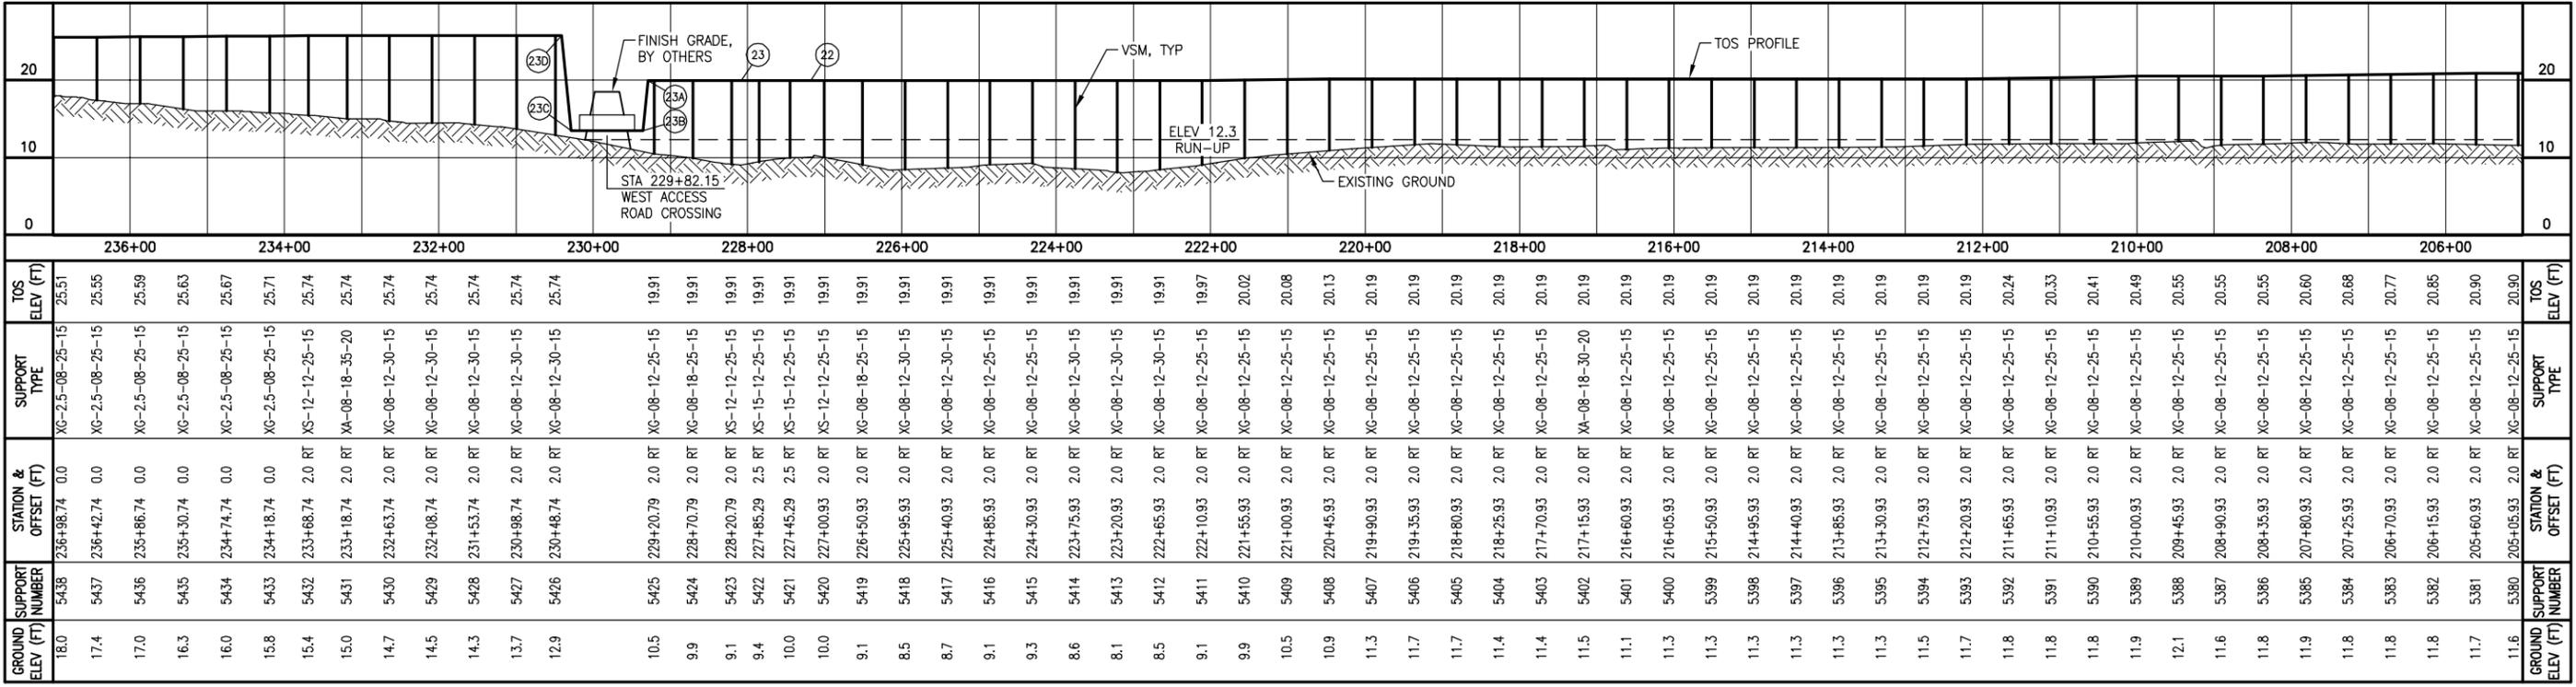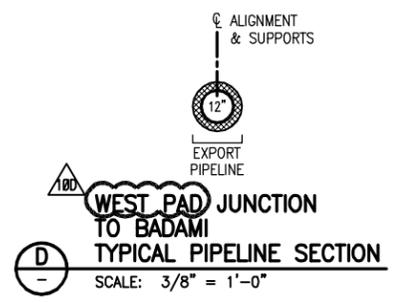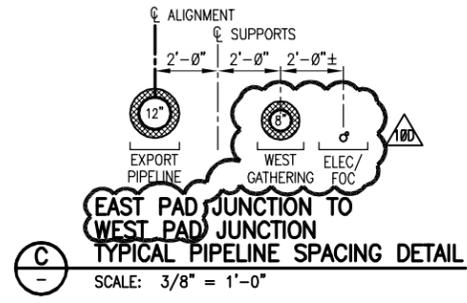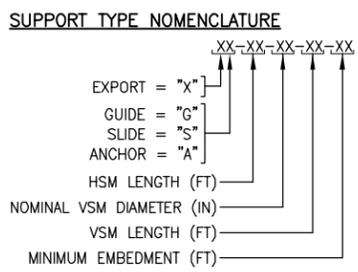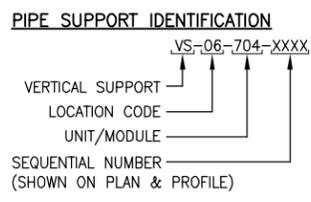

REFERENCE DRAWINGS

MODULE	DESCRIPTION
USPT-WP-YDSYM-060001	PROJECT NOTES, ABBREVIATIONS AND LEGEND
USPT-WP-YDPAL-060001	SITE PLAN
USPT-WP-YDDET-060001	TYPICAL EXPANSION LOOP DETAIL
USPT-WP-YDDET-060010	GUIDED AND ANCHORED SUPPORT DETAILS
USPT-WP-YDDET-060011	SLIDING SUPPORT DETAILS
USPT-WP-YDPLX-060001	ROAD CROSSING PLAN AND SECTION WEST PAD ACCESS ROAD
USPT-WP-YDWIV-060001	WIND-INDUCED VIBRATION MITIGATION PLAN

PRELIMINARY NOT FOR CONSTRUCTION

REV	DATE	DESCRIPTION	BY	CHK	APPD	PROJ
10	12/28/11	ISSUED FOR CONSTRUCTION	RFH	JAG	PAC	GMP
10A	05/14/12	ISSUED FOR INTERNAL REVIEW	RFH	JAG	PAC	GMP
10B	05/21/12	ISSUED FOR SQUAD CHECK	RFH	JAG	PAC	GMP
10C	06/08/12	ISSUED FOR CLIENT REVIEW	RFH	JAG	PAC	GMP
10D	06/29/12	ISSUED FOR QUOTE	RFH	JAG	PAC	GMP

ExxonMobil Development

WorleyParsons FLUOR


Baker

EXPORT PIPELINE - PIPELINE PIPELINE ALIGNMENT SHEET PLAN & PROFILE STA 205+00 TO STA 237+00

POINT THOMSON	ALASKA
MODULE	DATE
R. HOBBS	12/11
DRAWN	SCALE
AS SHOWN	CHK APPD
JAG PAC	JAG PAC
DRAWING NO.	SHEET
USPT-WP-YDPAL-060009-001	1 of 1


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PT-D-BAKER.DWG (24x36)


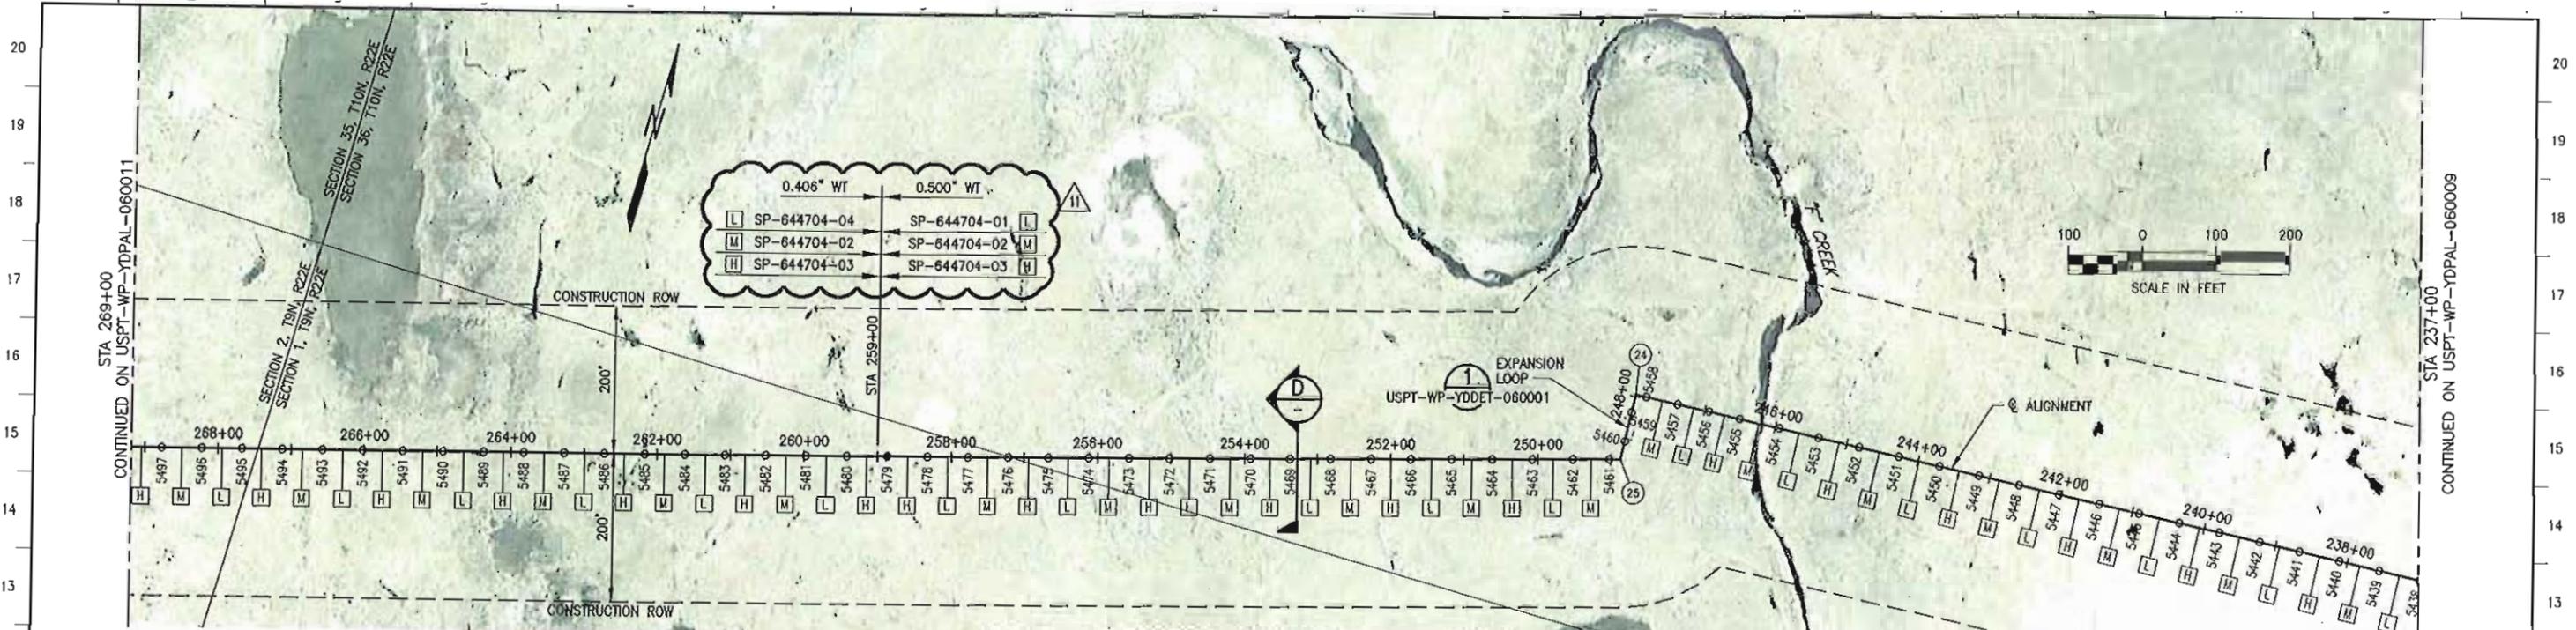


LOCATION	MATERIAL	WALL THK (IN)	FBE COATING (MIL)	INSULATION (IN)
237+00 TO 259+00	12.75" DIA API 5L X65	0.500	SHOP: 20 MIN, 32 MAX FIELD: 25 MIN, 39 MAX	3.0
259+00 TO 269+00	12.75" DIA API 5L X65	0.406	SHOP: 20 MIN, 32 MAX FIELD: 25 MIN, 39 MAX	3.0

POINT #	DESCRIPTION	STATION	NORTHING	EASTING	ANGLE
24	PI	247+97.09	5912216.91	1584870.24	90.0°
25	PI	248+87.09	5912127.03	1584874.75	76.87°

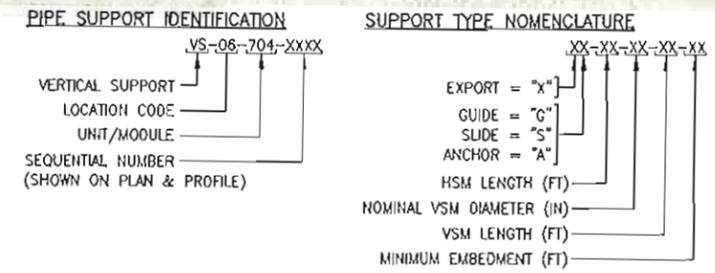

- NOTES**
- CENTERLINE OF ALIGNMENT = CENTERLINE OF 12"-LN-644-0049-ME6EV-3"H.
 - STATIONING ALONG ALIGNMENT REFLECTS HORIZONTAL DISTANCE.
 - HORIZONTAL DATUM IS NAD83, ALASKA STATE PLANE ZONE 3, US FOOT.
 - VERTICAL DATUM IS POINT THOMSON UNIT MEAN LOWER LOW WATER (PTU MLW).
 - FOR GUIDED AND ANCHORED SUPPORT DETAILS, SEE USPT-WP-YDDET-060010.
 - FOR SLIDING SUPPORT DETAILS, SEE USPT-WP-YDDET-060011.
 - FOR WIND-INDUCED VIBRATION MITIGATION PLAN AND TUNED VIBRATION ABSORBER (TVA) INSTALLATION, SEE USPT-WP-YDDEV-060001.
- LEGEND**
- GUIDED OR SLIDING SUPPORT
 - ANCHORED SUPPORT
 - ⊙ PI OR VPI LOCATION
 - H HIGH FREQUENCY TVA
 - L LOW FREQUENCY TVA
 - M MEDIUM FREQUENCY TVA

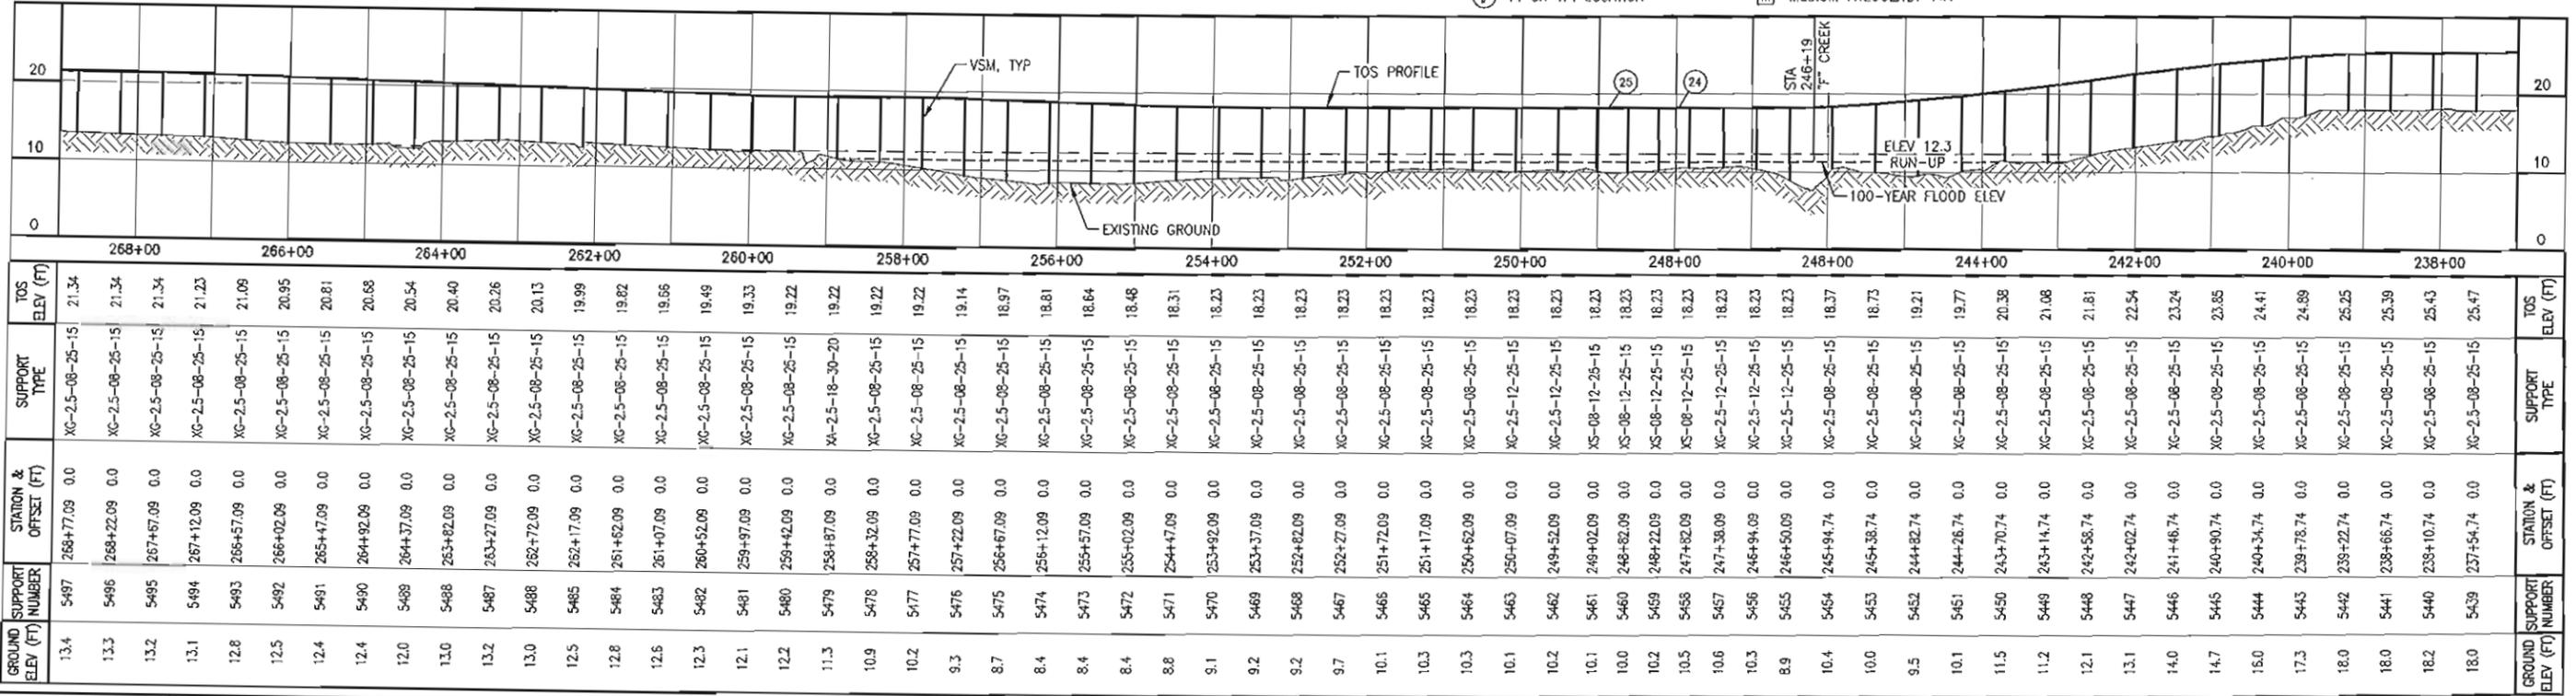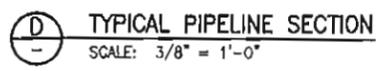

REFERENCE DRAWINGS	DESCRIPTION
USPT-WP-YDSYM-060001	PROJECT NOTES, ABBREVIATIONS AND LEGEND
USPT-WP-YDPAL-060001	SITE PLAN
USPT-WP-YDDET-060001	TYPICAL EXPANSION LOOP DETAIL
USPT-WP-YDDET-060010	GUIDED AND ANCHORED SUPPORT DETAILS
USPT-WP-YDDET-060011	SLIDING SUPPORT DETAILS
USPT-WP-YDDEV-060001	WIND-INDUCED VIBRATION MITIGATION PLAN



REV	DATE	DESCRIPTION	BY	CHK	APPD	PROJ
10	12/28/11	ISSUED FOR CONSTRUCTION	RTH	JAG	PAC	GUP
11	03/02/12	ISSUED FOR CONSTRUCTION	RTH	JAG	PAC	GUP

POINT THOMSON
MODULE
R. HOBBS


DATE: 12/11
SCALE: AS SHOWN

CHEK APPD JAC
SHEET PAC

FILENAME: USPT-WP-YDPAL-060010-001

EXPORT PIPELINE - PIPELINE
PIPELINE ALIGNMENT SHEET
PLAN & PROFILE
STA 237+00 TO STA 269+00

ALASKA
1 of 1 11

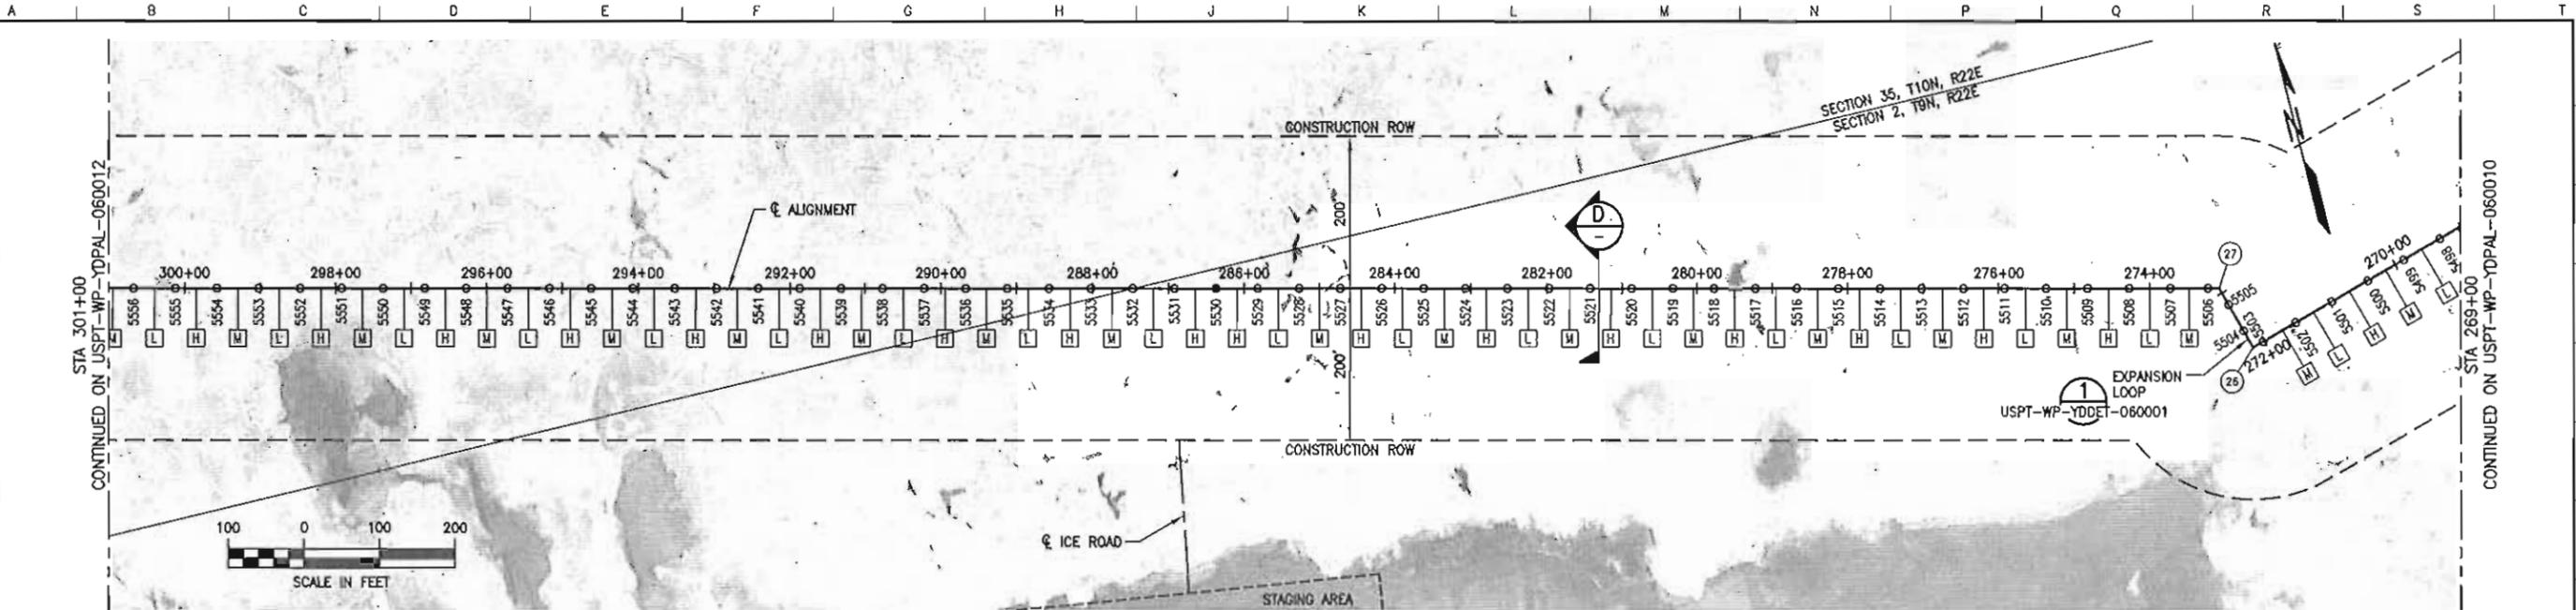

LOCATION	MATERIAL	WALL THK (IN)	FBE COATING (MIL)	INSULATION (IN)
269+00 TO 301+00	12.75" DIA API 5L X65	0.406	SHOP: 20 MIN, 32 MAX FIELD: 25 MIN, 39 MAX	3.0

POINT	DESCRIPTION	STATION	NORTHING	EASTING	ANGLE
26	PI	272+17.09	5911484.79	1582635.01	90.0°
27	PI	273+07.09	5911571.31	1582610.20	60.0°

PIPE SUPPORT IDENTIFICATION
 VS-06-704-XXXX

SUPPORT TYPE NOMENCLATURE
 XX-XX-XX-XX-XX

VERTICAL SUPPORT
 LOCATION CODE
 UNIT/MODULE
 SEQUENTIAL NUMBER (SHOWN ON PLAN & PROFILE)

EXPORT = "X"
 GUIDE = "G"
 SLOPE = "S"
 ANCHOR = "A"
 HSM LENGTH (FT)
 NOMINAL VSM DIAMETER (IN)
 VSM LENGTH (FT)
 MINIMUM EMBEDMENT (FT)


NOTES

- CENTERLINE OF ALIGNMENT = CENTERLINE OF 12"-LN-644-0049-ME8EV-3"H.
- STATIONING ALONG ALIGNMENT REFLECTS HORIZONTAL DISTANCE.
- HORIZONTAL DATUM IS NAD83, ALASKA STATE PLANE ZONE 3, US FOOT.
- VERTICAL DATUM IS POINT THOMSON UNIT MEAN LOWER LOW WATER (PTU MLLW).
- FOR GUIDED AND ANCHORED SUPPORT DETAILS, SEE USPT-WP-YDOET-060010.
- FOR SLIDING SUPPORT DETAILS, SEE USPT-WP-YDOET-060011.
- FOR WIND-INDUCED VIBRATION MITIGATION PLAN AND TUNED VIBRATION ABSORBER (TVA) INSTALLATION, SEE USPT-WP-YDWN-060001.

LEGEND

- GUIDED OR SLIDING SUPPORT
- ANCHORED SUPPORT
- ⊙ PI OR VPI LOCATION
- HIGH FREQUENCY TVA
- ▭ LOW FREQUENCY TVA
- ▭ MEDIUM FREQUENCY TVA

TYPICAL PIPELINE SECTION
 SCALE: 3/8" = 1'-0"

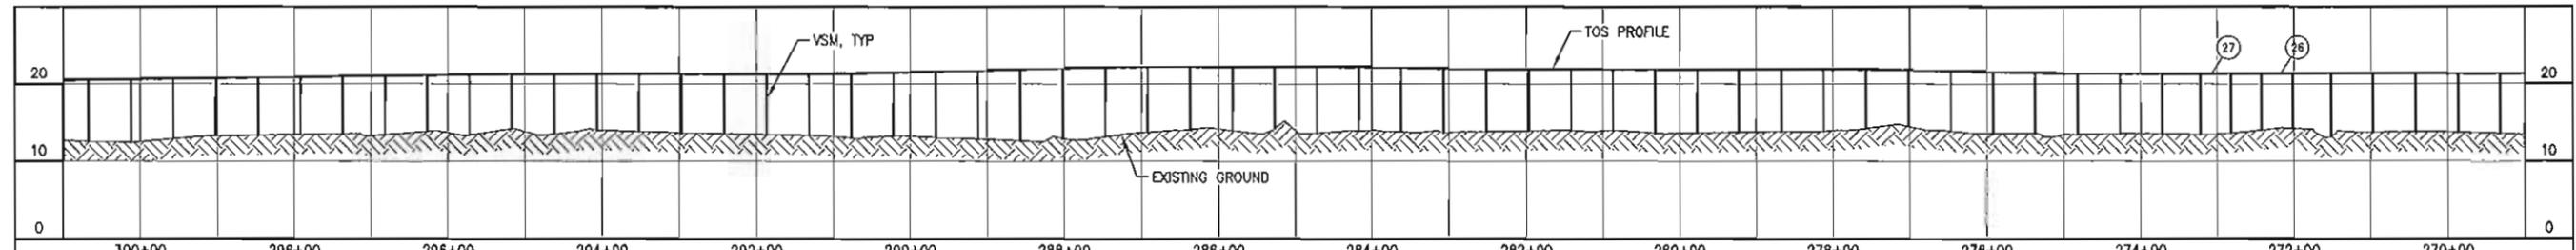


GROUND ELEV (FT)	GROUND SUPPORT NUMBER	STATION & OFFSET (FT)	SUPPORT TYPE	TOS ELEV (FT)
12.6	5556	300+67.09 0.0	XG-2.5-08-25-15	20.52
12.5	5555	300+12.09 0.0	XG-2.5-08-25-15	20.60
12.9	5554	299+57.09 0.0	XG-2.5-08-25-15	20.67
13.3	5553	299+02.09 0.0	XG-2.5-08-25-15	20.75
13.4	5552	298+47.09 0.0	XG-2.5-08-25-15	20.82
13.5	5551	297+92.09 0.0	XG-2.5-08-25-15	20.90
13.6	5550	297+37.09 0.0	XG-2.5-08-25-15	20.97
13.4	5549	296+82.09 0.0	XG-2.5-08-25-15	21.04
13.9	5548	296+27.09 0.0	XG-2.5-08-25-15	21.12
13.4	5547	295+72.09 0.0	XG-2.5-08-25-15	21.19
14.2	5546	295+17.09 0.0	XG-2.5-08-25-15	21.27
13.5	5545	294+62.09 0.0	XG-2.5-08-25-15	21.27
14.0	5544	294+07.09 0.0	XG-2.5-08-25-15	21.27
13.9	5543	293+52.09 0.0	XG-2.5-08-25-15	21.27
13.6	5542	292+97.09 0.0	XG-2.5-08-25-15	21.27
13.6	5541	292+42.09 0.0	XG-2.5-08-25-15	21.27
13.5	5540	291+87.09 0.0	XG-2.5-08-25-15	21.27
13.4	5539	291+32.09 0.0	XG-2.5-08-25-15	21.27
13.0	5538	290+77.09 0.0	XG-2.5-08-25-15	21.34
13.3	5537	290+22.09 0.0	XG-2.5-08-25-15	21.47
13.1	5536	289+67.09 0.0	XG-2.5-08-25-15	21.61
12.9	5535	289+12.09 0.0	XG-2.5-08-25-15	21.75
12.7	5534	288+57.09 0.0	XG-2.5-08-25-15	21.89
13.0	5533	288+02.09 0.0	XG-2.5-08-25-15	22.02
13.2	5532	287+47.09 0.0	XG-2.5-08-25-15	22.16
13.8	5531	286+92.09 0.0	XG-2.5-08-25-15	22.23
14.1	5530	286+37.09 0.0	XA-2.5-18-30-20	22.23
14.0	5529	285+82.09 0.0	XG-2.5-08-25-15	22.23
14.3	5528	285+27.09 0.0	XG-2.5-08-25-15	22.23
13.6	5527	284+72.09 0.0	XG-2.5-08-25-15	22.23
14.0	5526	284+17.09 0.0	XG-2.5-08-25-15	22.17
13.8	5525	283+62.09 0.0	XG-2.5-08-25-15	22.09
13.7	5524	283+07.09 0.0	XG-2.5-08-25-15	22.01
13.9	5523	282+52.09 0.0	XG-2.5-08-25-15	21.93
13.9	5522	281+97.09 0.0	XG-2.5-08-25-15	21.87
14.0	5521	281+42.09 0.0	XG-2.5-08-25-15	21.87
14.0	5520	280+87.09 0.0	XG-2.5-08-25-15	21.87
13.7	5519	280+32.09 0.0	XG-2.5-08-25-15	21.87
13.7	5518	279+77.09 0.0	XG-2.5-08-25-15	21.87
13.8	5517	279+22.09 0.0	XG-2.5-08-25-15	21.87
13.8	5516	278+67.09 0.0	XG-2.5-08-25-15	21.87
13.9	5515	278+12.09 0.0	XG-2.5-08-25-15	21.87
14.3	5514	277+57.09 0.0	XG-2.5-08-25-15	21.87
14.5	5513	277+02.09 0.0	XG-2.5-08-25-15	21.79
13.9	5512	276+47.09 0.0	XG-2.5-08-25-15	21.67
13.6	5511	275+92.09 0.0	XG-2.5-08-25-15	21.54
13.6	5510	275+37.09 0.0	XG-2.5-08-25-15	21.42
13.5	5509	274+82.09 0.0	XG-2.5-08-25-15	21.34
13.6	5508	274+27.09 0.0	XG-2.5-08-25-15	21.34
13.6	5507	273+72.09 0.0	XG-2.5-08-25-15	21.34
13.5	5506	273+17.09 0.0	XG-2.5-08-25-15	21.34
13.7	5505	272+62.09 0.0	XG-2.5-08-25-15	21.34
14.0	5504	272+07.09 0.0	XG-2.5-08-25-15	21.34
14.2	5503	271+52.09 0.0	XG-2.5-08-25-15	21.34
13.2	5502	271+07.09 0.0	XG-2.5-08-25-15	21.34
13.8	5501	270+52.09 0.0	XG-2.5-08-25-15	21.34
13.8	5500	270+07.09 0.0	XG-2.5-08-25-15	21.34
13.8	5499	269+52.09 0.0	XG-2.5-08-25-15	21.34
13.6	5498	269+07.09 0.0	XG-2.5-08-25-15	21.34

REFERENCE DRAWINGS	DESCRIPTION
USPT-WP-YDSM-060001	PROJECT NOTES, ABBREVIATIONS AND LEGEND
USPT-WP-YDPAL-060001	SITE PLAN
USPT-WP-YDOET-060001	TYPICAL EXPANSION LOOP DETAIL
USPT-WP-YDOET-060010	GUIDED AND ANCHORED SUPPORT DETAILS
USPT-WP-YDOET-060011	SLIDING SUPPORT DETAILS
USPT-WP-YDWN-060001	WIND-INDUCED VIBRATION MITIGATION PLAN




REV	DATE	DESCRIPTION	BY	CHK	APPD	PROJ
10	12/28/11	ISSUED FOR CONSTRUCTION	RFH	JAG	PAC	GMP

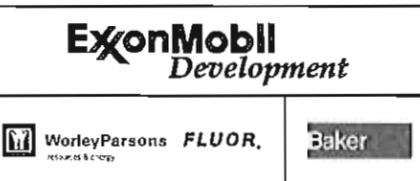

EXPORT PIPELINE - PIPELINE PIPELINE ALIGNMENT SHEET PLAN & PROFILE STA 269+00 TO STA 301+00			
MODULE	DATE	SCALE	CHK
R. HOBBS	12/11	AS SHOWN	JAG
DRAWING NO.	SHEET	REV	REV
USPT-WP-YDPAL-060011-001	1 of 1	10	

T:\122883 - Point Thomson EPC03 - CADD01 - Export\USPT-WP-YDPAL-06

FILENAME: USPT-WP-YDPAL-060011-001

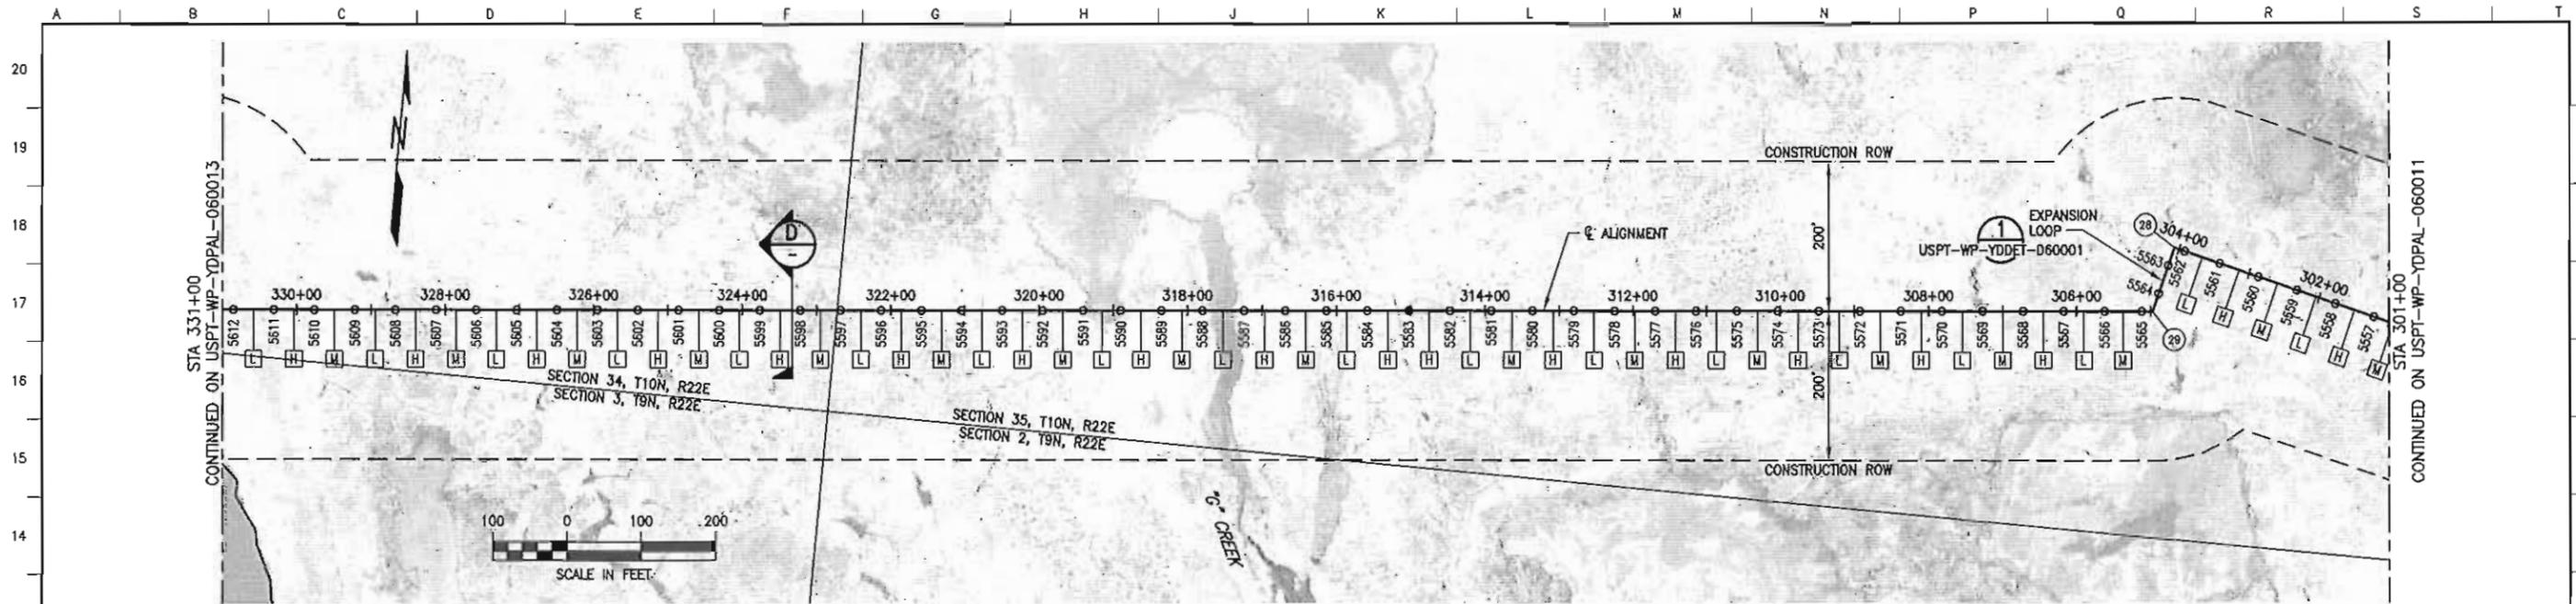

LOCATION	MATERIAL	WALL THK (IN)	FBE COATING (MIL)	INSULATION (IN)
301+00 TO 331+00	12.75" OIA API 5L X65	0.406	SHOP: 20 MIN, 32 MAX FIELD: 25 MIN, 39 MAX	3.0

POINT	DESCRIPTION	STATION	NORTHING	EASTING	ANGLE
28	PI	304+07.09	5912321.26	1579602.28	90.0°
29	PI	304+97.09	5912233.94	1579580.51	71.09°

PIPE SUPPORT IDENTIFICATION

VS-06-704-XXXX
 VERTICAL SUPPORT
 LOCATION CODE
 UNIT/MODULE
 SEQUENTIAL NUMBER
 (SHOWN ON PLAN & PROFILE)

SUPPORT TYPE NOMENCLATURE



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 GUIDE = "G"
 SLOPE = "S"
 ANCHOR = "A"
 HSM LENGTH (FT)
 NOMINAL VSM DIAMETER (IN)
 VSM LENGTH (FT)
 MINIMUM EMBEDMENT (FT)

NOTES

- CENTERLINE OF ALIGNMENT = CENTERLINE OF 12"-LN-644-0049-ME8EV-3"H.
- STATIONING ALONG ALIGNMENT REFLECTS HORIZONTAL DISTANCE.
- HORIZONTAL DATUM IS NAD83, ALASKA STATE PLANE ZONE 3, US FOOT.
- VERTICAL DATUM IS POINT THOMSON UNIT MEAN LOWER LOW WATER (PTU MLLW).
- FOR GUIDED AND ANCHORED SUPPORT DETAILS, SEE USPT-WP-YDDET-060010.
- FOR SLIDING SUPPORT DETAILS, SEE USPT-WP-YDDET-060011.
- FOR WIND-INDUCED VIBRATION MITIGATION PLAN AND TUNED VIBRATION ABSORBER (TVA) INSTALLATION, SEE USPT-WP-YDHW-060001.

LEGEND

- GUIDED OR SLOPING SUPPORT
- ANCHORED SUPPORT
- ⊙ PI OR VPI LOCATION
- ⊠ HIGH FREQUENCY TVA
- ⊡ LOW FREQUENCY TVA
- ⊞ MEDIUM FREQUENCY TVA

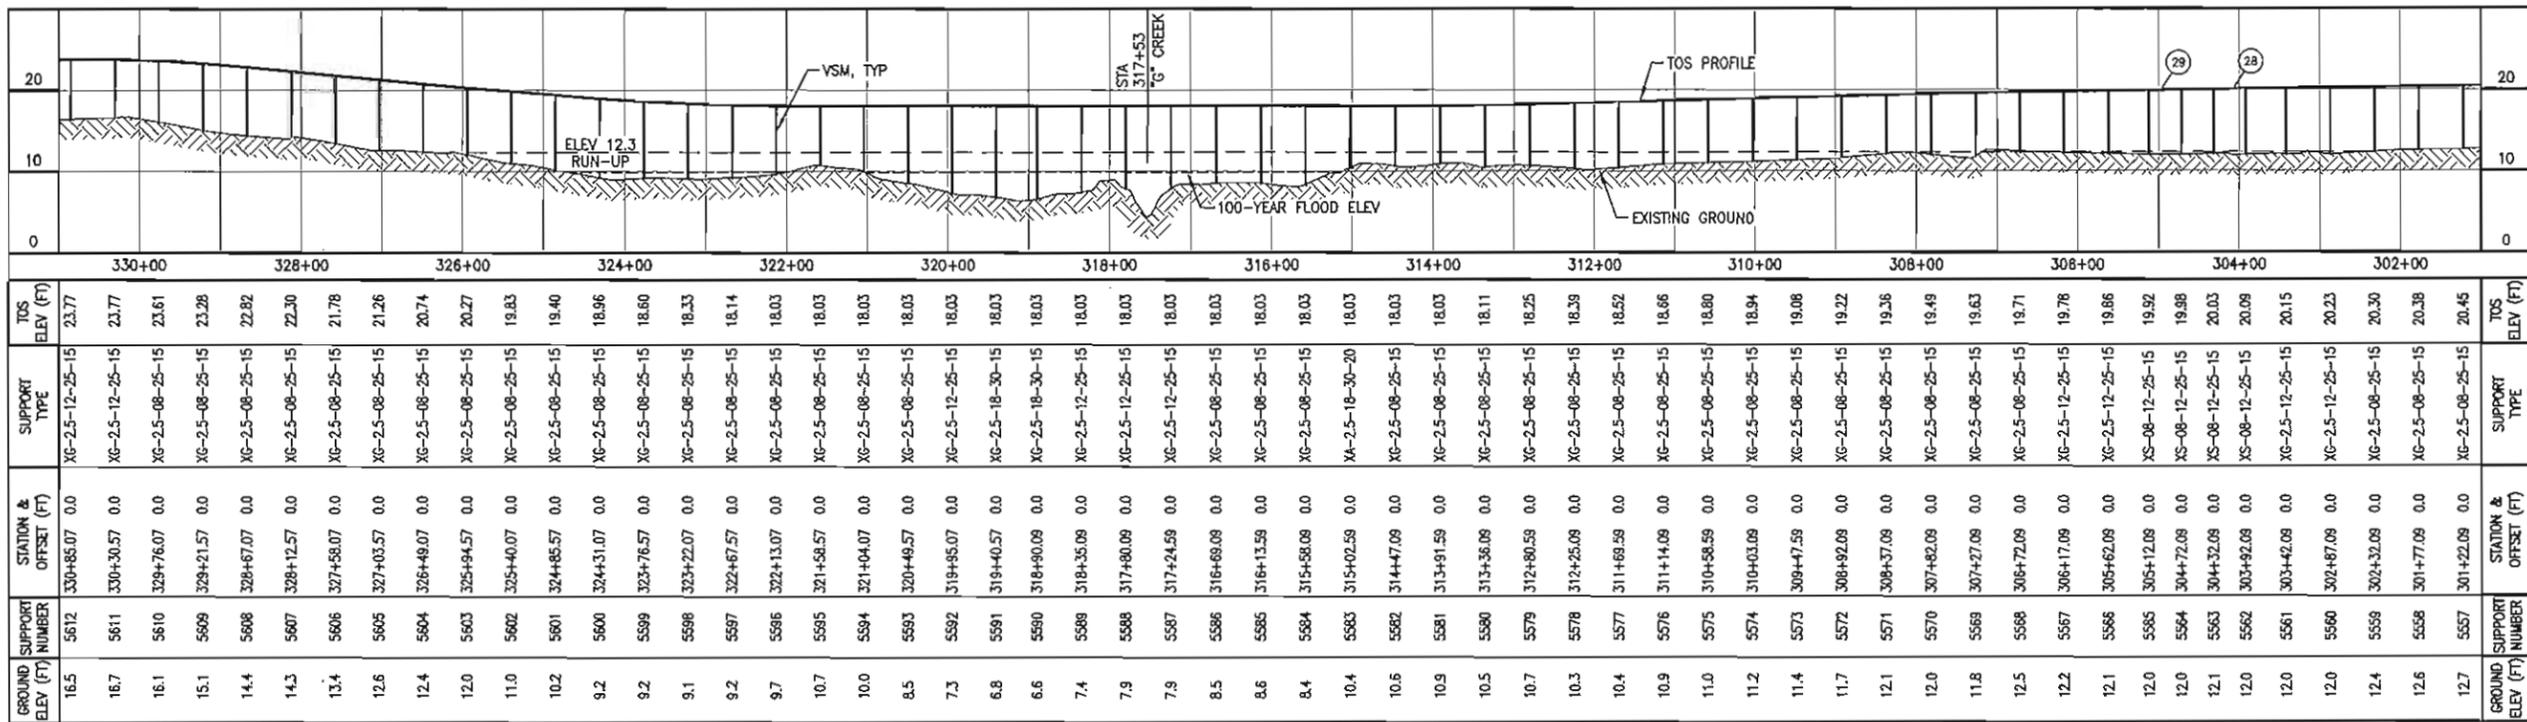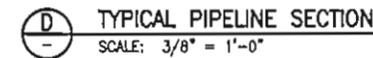

GROUND ELEV (FT)	SUPPORT NUMBER	STATION & OFFSET (FT)	SUPPORT TYPE	TOS ELEV (FT)
16.5	5612	330+85.07 0.0	XG-2.5-12-25-15	23.77
16.7	5611	330+30.57 0.0	XG-2.5-12-25-15	23.77
16.1	5610	329+76.07 0.0	XG-2.5-08-25-15	23.61
15.1	5609	329+21.57 0.0	XG-2.5-08-25-15	23.28
14.4	5608	328+67.07 0.0	XG-2.5-08-25-15	22.82
14.3	5607	328+12.57 0.0	XG-2.5-08-25-15	22.30
13.4	5606	327+58.07 0.0	XG-2.5-08-25-15	21.78
12.6	5605	327+03.57 0.0	XG-2.5-08-25-15	21.26
12.4	5604	326+49.07 0.0	XG-2.5-08-25-15	20.74
12.0	5603	325+94.57 0.0	XG-2.5-08-25-15	20.27
11.0	5602	325+40.07 0.0	XG-2.5-08-25-15	19.83
10.2	5601	324+85.57 0.0	XG-2.5-08-25-15	19.40
9.2	5600	324+31.07 0.0	XG-2.5-08-25-15	18.96
9.2	5599	323+76.57 0.0	XG-2.5-08-25-15	18.60
9.1	5598	323+22.07 0.0	XG-2.5-08-25-15	18.33
9.2	5597	322+67.57 0.0	XG-2.5-08-25-15	18.14
9.7	5596	322+13.07 0.0	XG-2.5-08-25-15	18.03
10.7	5595	321+58.57 0.0	XG-2.5-08-25-15	18.03
10.0	5594	321+04.07 0.0	XG-2.5-08-25-15	18.03
8.5	5593	320+49.57 0.0	XG-2.5-08-25-15	18.03
7.3	5592	319+95.07 0.0	XG-2.5-12-25-15	18.03
6.8	5591	319+40.57 0.0	XG-2.5-18-30-15	18.03
6.6	5590	318+90.09 0.0	XG-2.5-18-30-15	18.03
7.4	5589	318+35.09 0.0	XG-2.5-12-25-15	18.03
7.9	5588	317+80.09 0.0	XG-2.5-12-25-15	18.03
7.9	5587	317+24.59 0.0	XG-2.5-12-25-15	18.03
8.5	5586	316+69.09 0.0	XG-2.5-08-25-15	18.03
8.6	5585	316+13.59 0.0	XG-2.5-08-25-15	18.03
8.4	5584	315+58.09 0.0	XG-2.5-08-25-15	18.03
10.4	5583	315+02.59 0.0	XA-2.5-18-30-20	18.03
10.6	5582	314+47.09 0.0	XG-2.5-08-25-15	18.03
10.9	5581	313+91.59 0.0	XG-2.5-08-25-15	18.03
10.5	5580	313+36.09 0.0	XG-2.5-08-25-15	18.11
10.7	5579	312+80.59 0.0	XG-2.5-08-25-15	18.25
10.3	5578	312+25.09 0.0	XG-2.5-08-25-15	18.39
10.4	5577	311+69.59 0.0	XG-2.5-08-25-15	18.52
10.9	5576	311+14.09 0.0	XG-2.5-08-25-15	18.66
11.0	5575	310+58.59 0.0	XG-2.5-08-25-15	18.80
11.2	5574	310+03.09 0.0	XG-2.5-08-25-15	18.94
11.4	5573	309+47.59 0.0	XG-2.5-08-25-15	19.08
11.7	5572	308+92.09 0.0	XG-2.5-08-25-15	19.22
12.1	5571	308+37.09 0.0	XG-2.5-08-25-15	19.36
12.0	5570	307+82.09 0.0	XG-2.5-08-25-15	19.49
11.8	5569	307+27.09 0.0	XG-2.5-08-25-15	19.63
12.5	5568	306+72.09 0.0	XG-2.5-08-25-15	19.71
12.2	5567	306+17.09 0.0	XG-2.5-12-25-15	19.78
12.1	5566	305+62.09 0.0	XG-2.5-12-25-15	19.86
12.0	5565	305+07.09 0.0	XS-08-12-25-15	19.92
12.0	5564	304+52.09 0.0	XS-08-12-25-15	19.98
12.1	5563	304+07.09 0.0	XS-08-12-25-15	20.03
12.0	5562	303+52.09 0.0	XS-08-12-25-15	20.09
12.0	5561	303+07.09 0.0	XG-2.5-12-25-15	20.15
12.0	5560	302+52.09 0.0	XG-2.5-12-25-15	20.23
12.4	5559	302+07.09 0.0	XG-2.5-08-25-15	20.30
12.6	5558	301+52.09 0.0	XG-2.5-08-25-15	20.38
12.7	5557	301+07.09 0.0	XG-2.5-08-25-15	20.45


REFERENCE DRAWINGS	DESCRIPTION
USPT-WP-YDSYM-060001	PROJECT NOTES, ABBREVIATIONS AND LEGEND
USPT-WP-YDPAL-060001	SITE PLAN
USPT-WP-YDDET-060001	TYPICAL EXPANSION LOOP DETAIL
USPT-WP-YDDET-060010	GUIDED AND ANCHORED SUPPORT DETAILS
USPT-WP-YDDET-060011	SLIDING SUPPORT DETAILS
USPT-WP-YDHW-060001	WIND-INDUCED VIBRATION MITIGATION PLAN



REV	DATE	DESCRIPTION	BY	CHK	APP	PRO
10	12/28/11	ISSUED FOR CONSTRUCTION				



EXPORT PIPELINE - PIPELINE ALIGNMENT SHEET PLAN & PROFILE STA 301+00 TO STA 331+00			
POINT THOMSON	DATE	SCALE	CHK APPR
MOORE	12/11	AS SHOWN	HOBBES
DRAWING NO.	USPT-WP-YDPAL-060012-001	SHEET	REV
		1 of 1	10

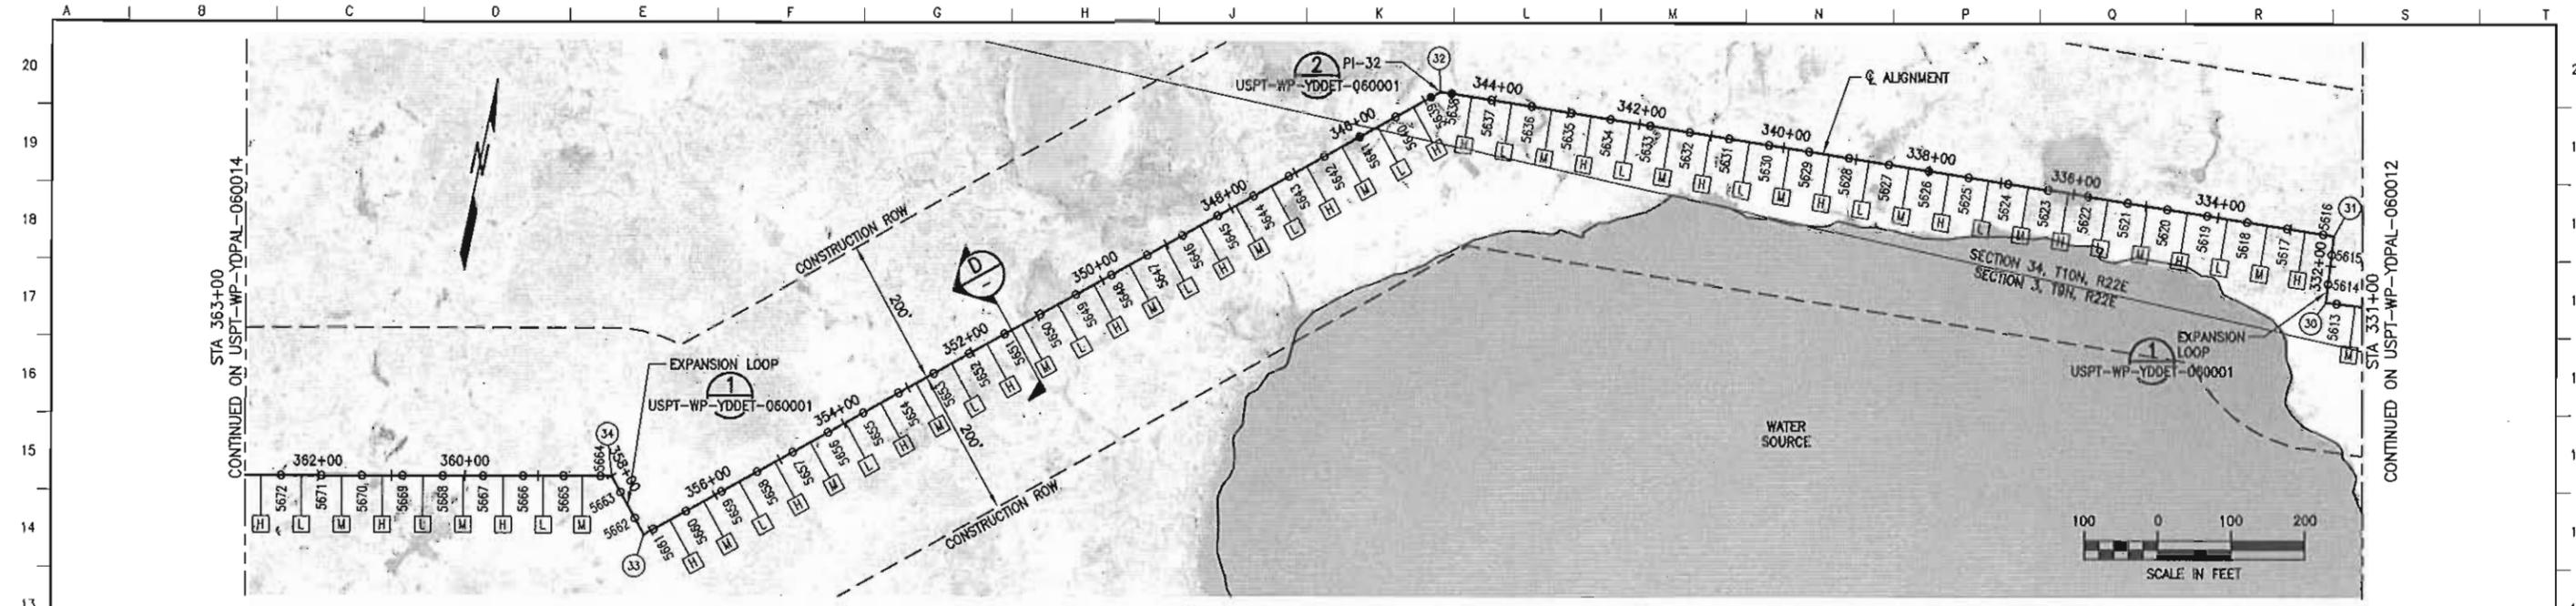

LOCATION	MATERIAL	WALL THK (IN)	FBE COATING (MIL)	INSULATION (IN)
J31+00 TO J63+00	12.75" DIA API 5L X65	0.406	SHOP: 20 MIN, 32 MAX FIELD: 25 MIN, 39 MAX	3.0

POINT #	DESCRIPTION	STATION	NORTHING	EASTING	ANGLE
30	PI	331+50.07	5912006.82	1576937.27	90.0°
31	PI	332+40.07	5912098.48	1576929.56	88.09°
32	PI	344+75.07	5912031.84	1575696.26	38.0°
33	PI	357+10.07	5911221.59	1574764.20	90.0°
34	PI	358+00.07	5911289.52	1574705.15	61.0°

PIPE SUPPORT IDENTIFICATION

VS-06-704-XXXX

VERTICAL SUPPORT
LOCATION CODE
UNIT/MODULE
SEQUENTIAL NUMBER
(SHOWN ON PLAN & PROFILE)

SUPPORT TYPE NOMENCLATURE

XX-XX-XX-XX-XX

EXPORT = "X"
GUIDE = "G"
SLIDE = "S"
ANCHOR = "A"



HSM LENGTH (FT)
NOMINAL VSM DIAMETER (IN)
VSM LENGTH (FT)
MINIMUM EMBEDMENT (FT)

NOTES

- CENTERLINE OF ALIGNMENT = CENTERLINE OF 12"-LN-644-0049-MEBEV-3TH.
- STATIONING ALONG ALIGNMENT REFLECTS HORIZONTAL DISTANCE.
- HORIZONTAL DATUM IS NAD83, ALASKA STATE PLANE ZONE 3, US FOOT.
- VERTICAL DATUM IS POINT THOMSON UNIT MEAN LOWER LOW WATER (PTU MLLW).
- FOR GUIDED AND ANCHORED SUPPORT DETAILS, SEE USPT-WP-YDDET-060010.
- FOR SLIDING SUPPORT DETAILS, SEE USPT-WP-YDDET-060011.
- FOR WIND-INDUCED VIBRATION MITIGATION PLAN AND TUNED VIBRATION ABSORBER (TVA) INSTALLATION, SEE USPT-WP-YDWPV-060001.

LEGEND

- GUIDED OR SLIDING SUPPORT
- ANCHORED SUPPORT
- ⊙ PI OR VPI LOCATION
- ⊠ HIGH FREQUENCY TVA
- ⊡ LOW FREQUENCY TVA
- ⊞ MEDIUM FREQUENCY TVA

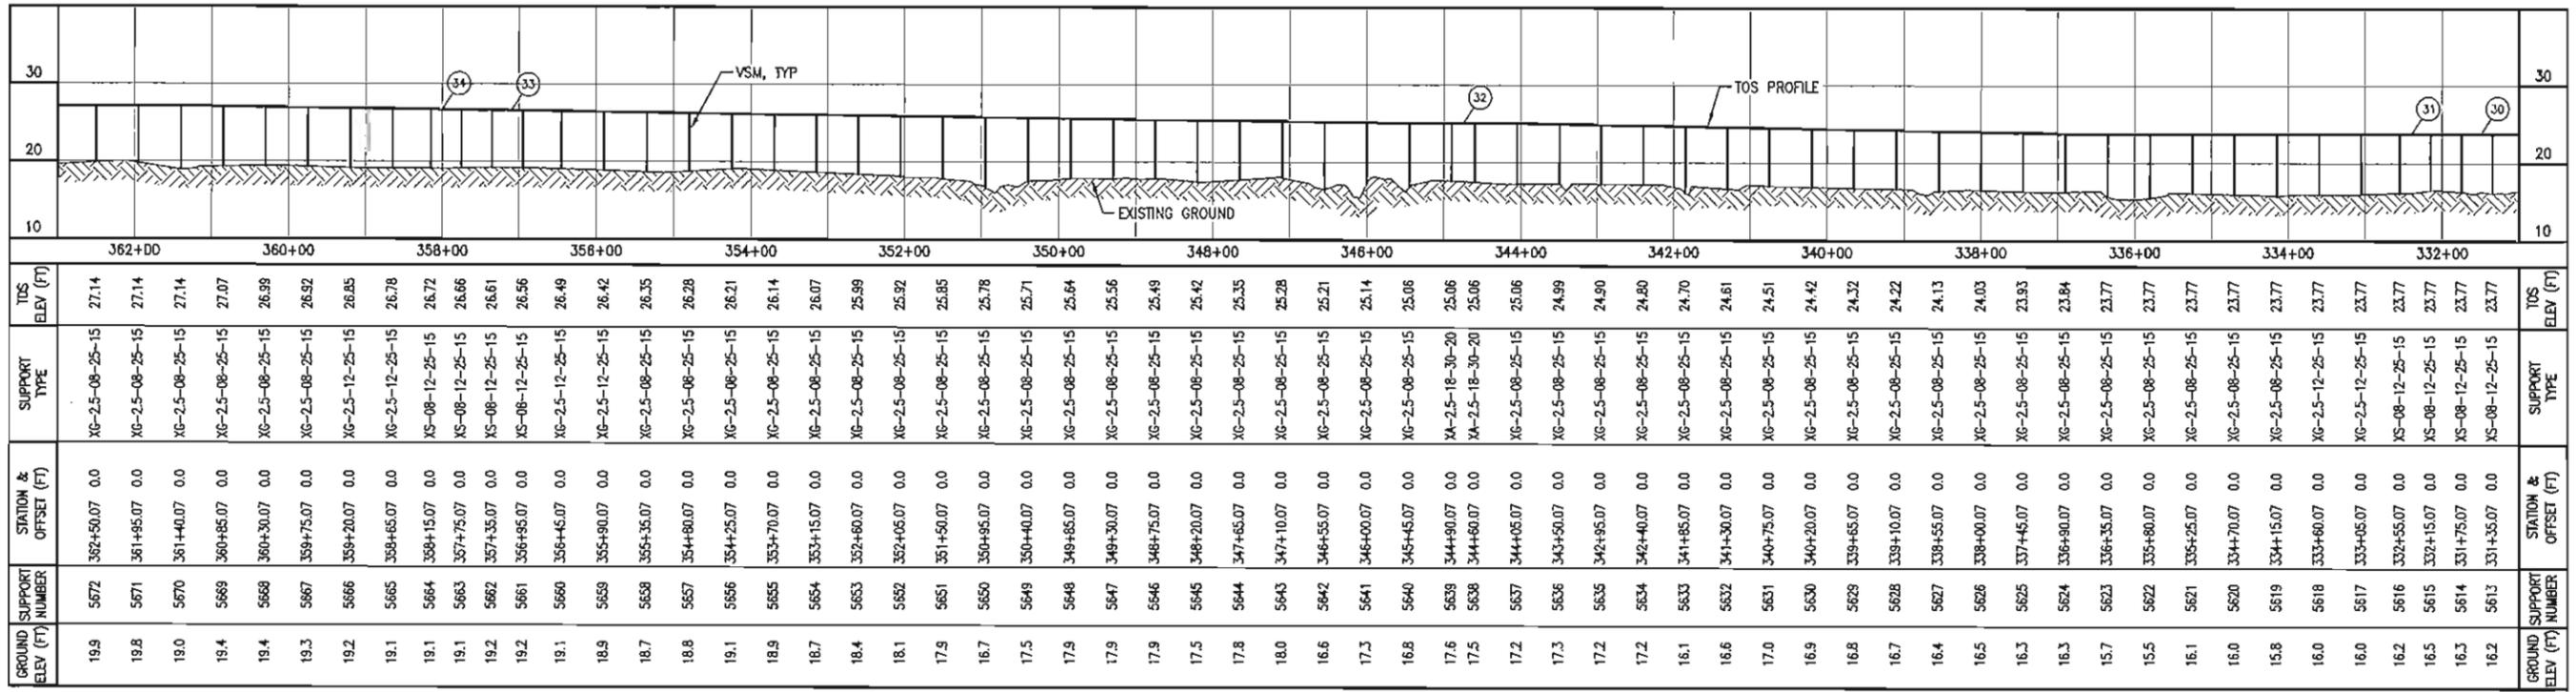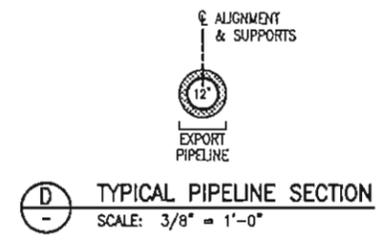

REFERENCE DRAWINGS	DESCRIPTION
USPT-WP-YDSTL-060001	PROJECT NOTES, ABBREVIATIONS AND LEGEND
USPT-WP-YDPAL-060001	SITE PLAN
USPT-WP-YDDET-060001	TYPICAL EXPANSION LOOP DETAIL
USPT-WP-YDDET-060010	GUIDED AND ANCHORED SUPPORT DETAILS
USPT-WP-YDDET-060011	SLIDING SUPPORT DETAILS
USPT-WP-YDWPV-060001	WIND-INDUCED VIBRATION MITIGATION PLAN




REV	DATE	DESCRIPTION	BY	CHK	APPD	PROJ
10	12/28/11	ISSUED FOR CONSTRUCTION	JWG	PAD	GUP	



POINT THOMSON				ALASKA	
MODULE	DRAWN	DATE	SCALE	CHK	APPD
	R. HOBBS	12/11	AS SHOWN	JWG	PAD
DRAWING NO. USPT-WP-YDPAL-060013-001				SHEET	REV
				1 of 1	T

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FILENAME: USPT-WP-YDPAL-060013-001

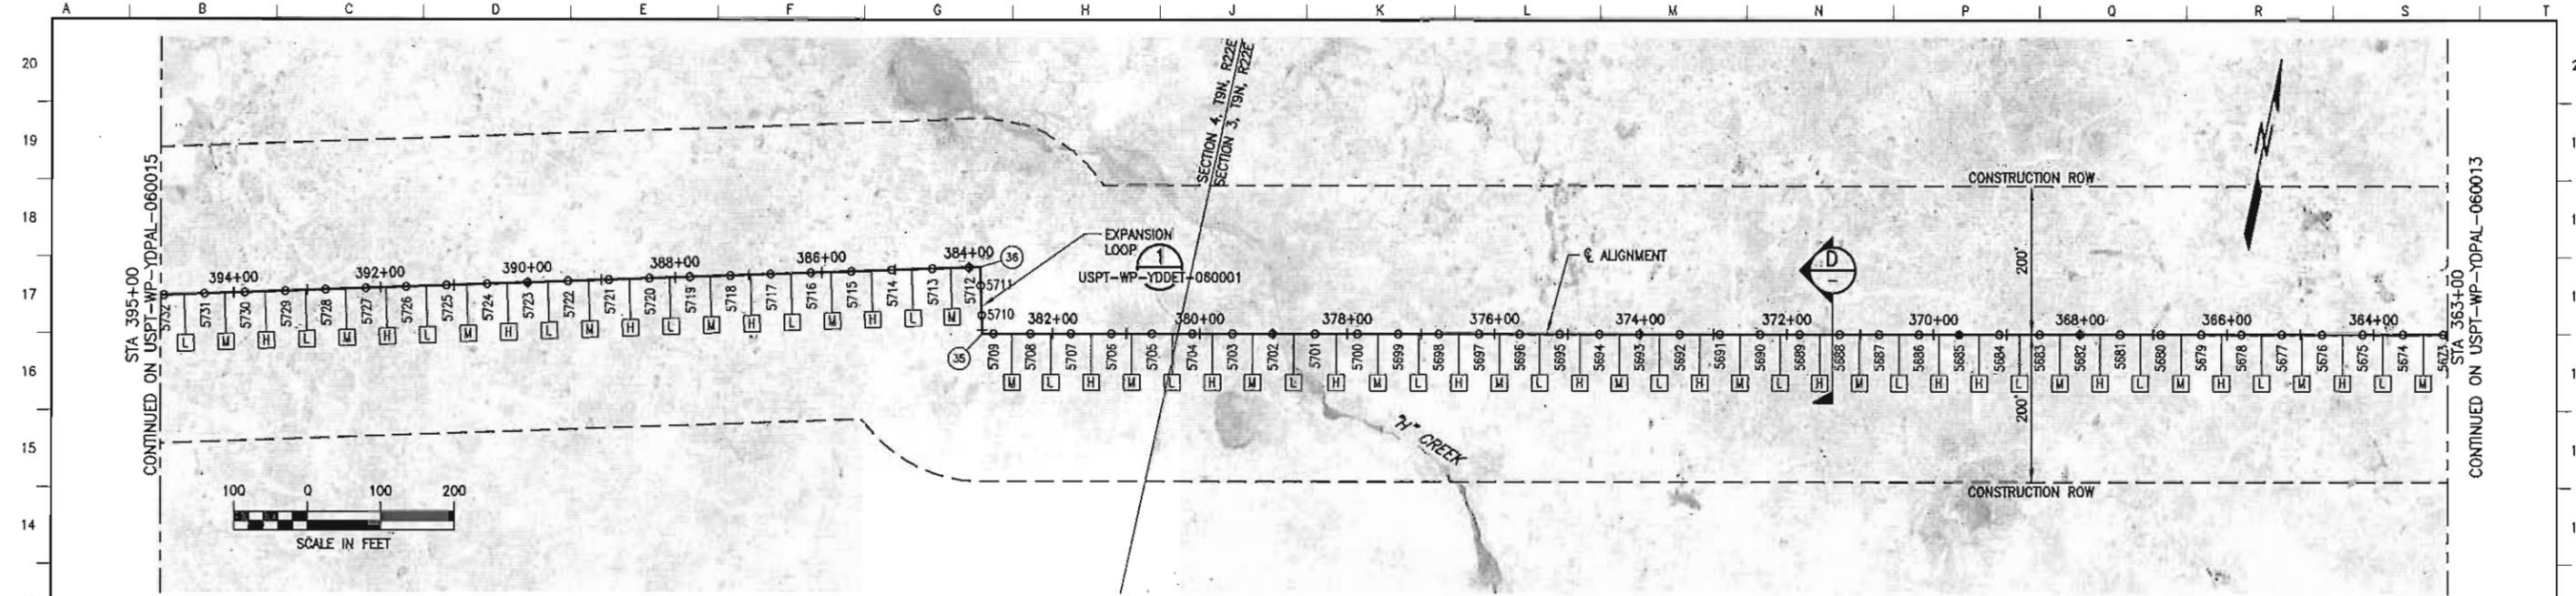

LOCATION	MATERIAL	WALL THK (IN)	FBE COATING (MIL)	INSULATION (IN)
363+00 TO 395+00	12.75" DIA API 5L X65	0.406	SHOP: 20 MIN, 32 MAX FIELD: 25 MIN, 39 MAX	3.0

POINT #	DESCRIPTION	STATION	NORTHING	EASTING	ANGLE
35	PI	382+95.07	5910770.75	1572264.68	88.0°
36	PI	383+85.07	5910858.08	1572242.91	90.0°

PIPE SUPPORT IDENTIFICATION
VS-06-704-XXXX

VERTICAL SUPPORT
LOCATION CODE
UNIT/MODULE
SEQUENTIAL NUMBER
(SHOWN ON PLAN & PROFILE)

SUPPORT TYPE NOMENCLATURE
XX-XX-XX-XX-XX



EXPORT = "X"
GUIDE = "G"
SLIDE = "S"
ANCHOR = "A"
HSM LENGTH (FT)
NOMINAL VSM DIAMETER (IN)
VSM LENGTH (FT)
MINIMUM EMBEDMENT (FT)

NOTES

- CENTERLINE OF ALIGNMENT = CENTERLINE OF 12"-LN-644-0049-ME8EV-37H.
- STATIONING ALONG ALIGNMENT REFLECTS HORIZONTAL DISTANCE.
- HORIZONTAL DATUM IS NAD83, ALASKA STATE PLANE ZONE 3, US FOOT.
- VERTICAL DATUM IS POINT THOMSON UNIT MEAN LOWER LOW WATER (PTU MLW).
- FOR GUIDED AND ANCHORED SUPPORT DETAILS, SEE USPT-WP-YDDET-060010.
- FOR SLIDING SUPPORT DETAILS, SEE USPT-WP-YDDET-060011.
- FOR WIND-INDUCED VIBRATION MITIGATION PLAN AND TUNED VIBRATION ABSORBER (TVA) INSTALLATION, SEE USPT-WP-YDWIV-060001.

LEGEND

- GUIDED OR SLIDING SUPPORT
- ANCHORED SUPPORT
- ⊙ PI OR VPI LOCATION
- HIGH FREQUENCY TVA
- LOW FREQUENCY TVA
- MEDIUM FREQUENCY TVA

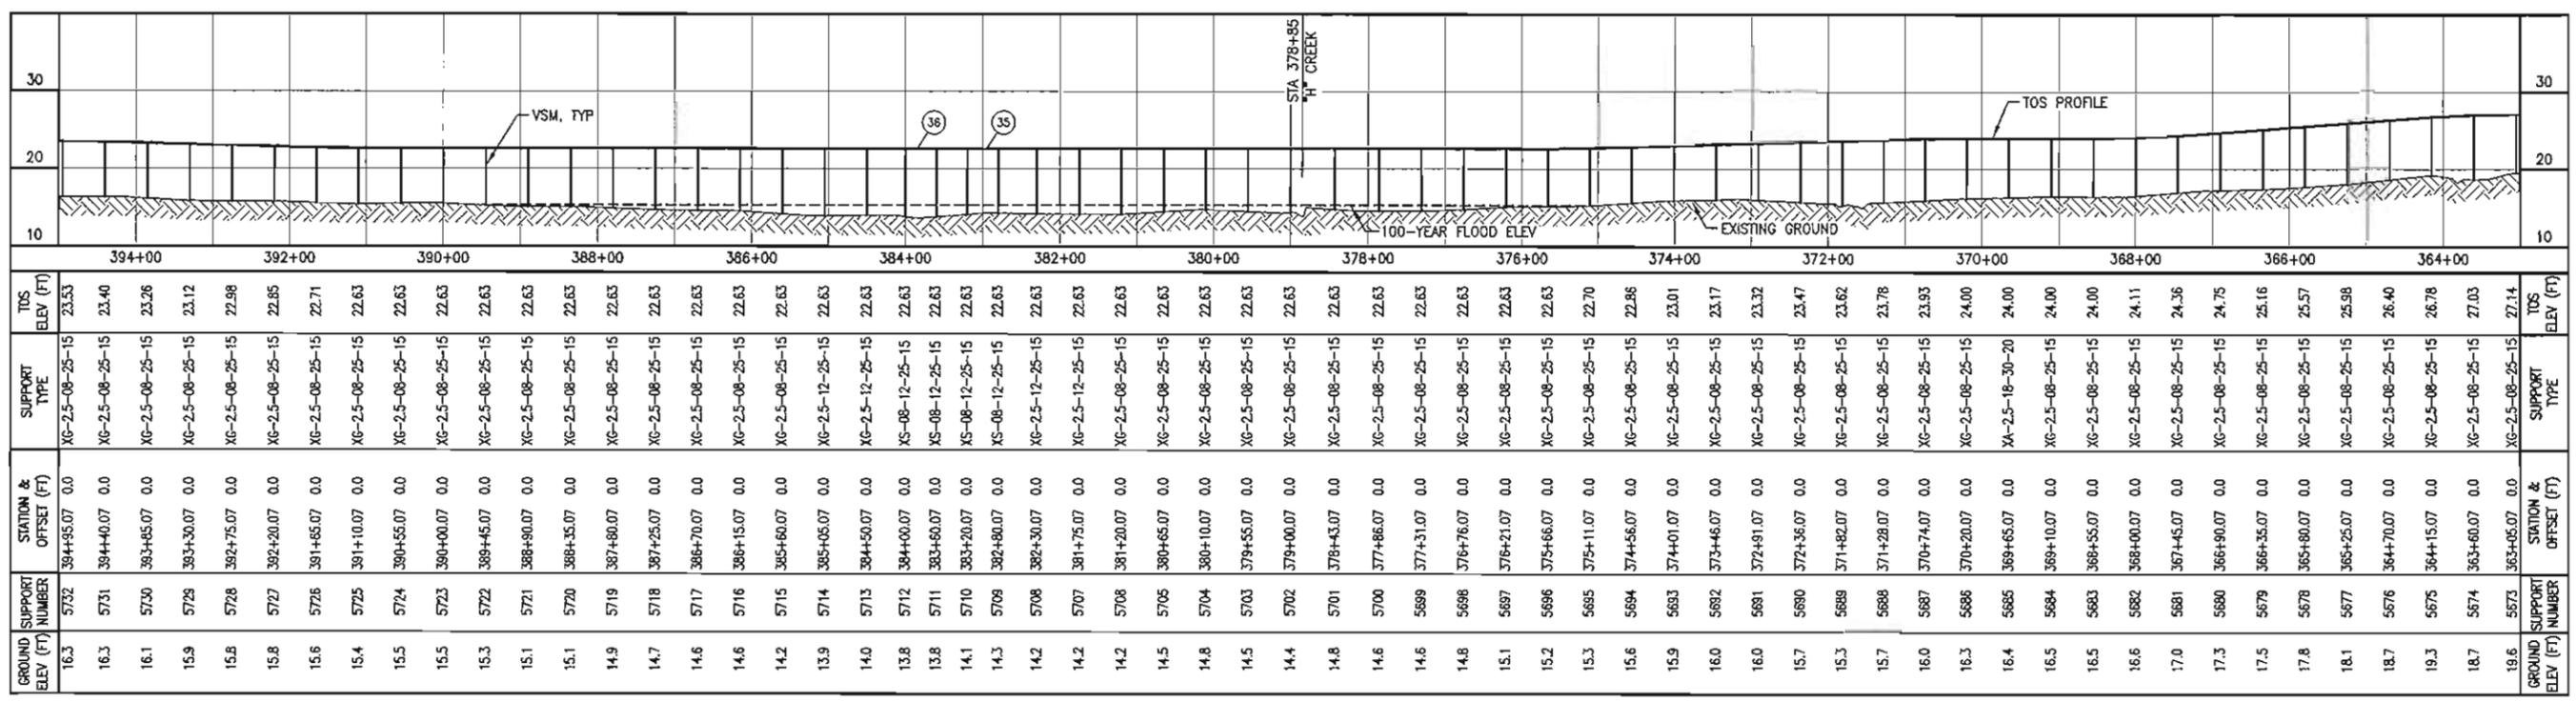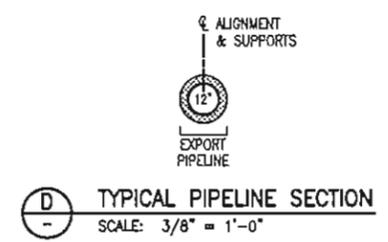

REFERENCE DRAWINGS	DESCRIPTION
USPT-WP-YDYM-060001	PROJECT NOTES, ABBREVIATIONS AND LEGEND
USPT-WP-YDPAL-060001	SITE PLAN
USPT-WP-YDDET-060001	TYPICAL EXPANSION LOOP DETAIL
USPT-WP-YDDET-060010	GUIDED AND ANCHORED SUPPORT DETAILS
USPT-WP-YDDET-060011	SLIDING SUPPORT DETAILS
USPT-WP-YDWMV-060001	WIND-INDUCED VIBRATION MITIGATION PLAN



REV	DATE	DESCRIPTION	BY	CHEK	APPO	PROJ
10	12/28/11	ISSUED FOR CONSTRUCTION				


ExxonMobil
Development

WorleyParsons **FLUOR**, Baker

EXPORT PIPELINE - PIPELINE ALIGNMENT SHEET PLAN & PROFILE STA 363+00 TO STA 395+00				ALASKA	
MODULE	DRAWN	DATE	SCALE	CHR	WB
	R. HOBBS	12/11	AS SHOWN	APPD	INC
DRAWING NO.	USPT-WP-YDPAL-060014-001		SHEET	REV	
			1 of 1	110	

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FILENAME: USPT-WP-YDPAL-060014-001

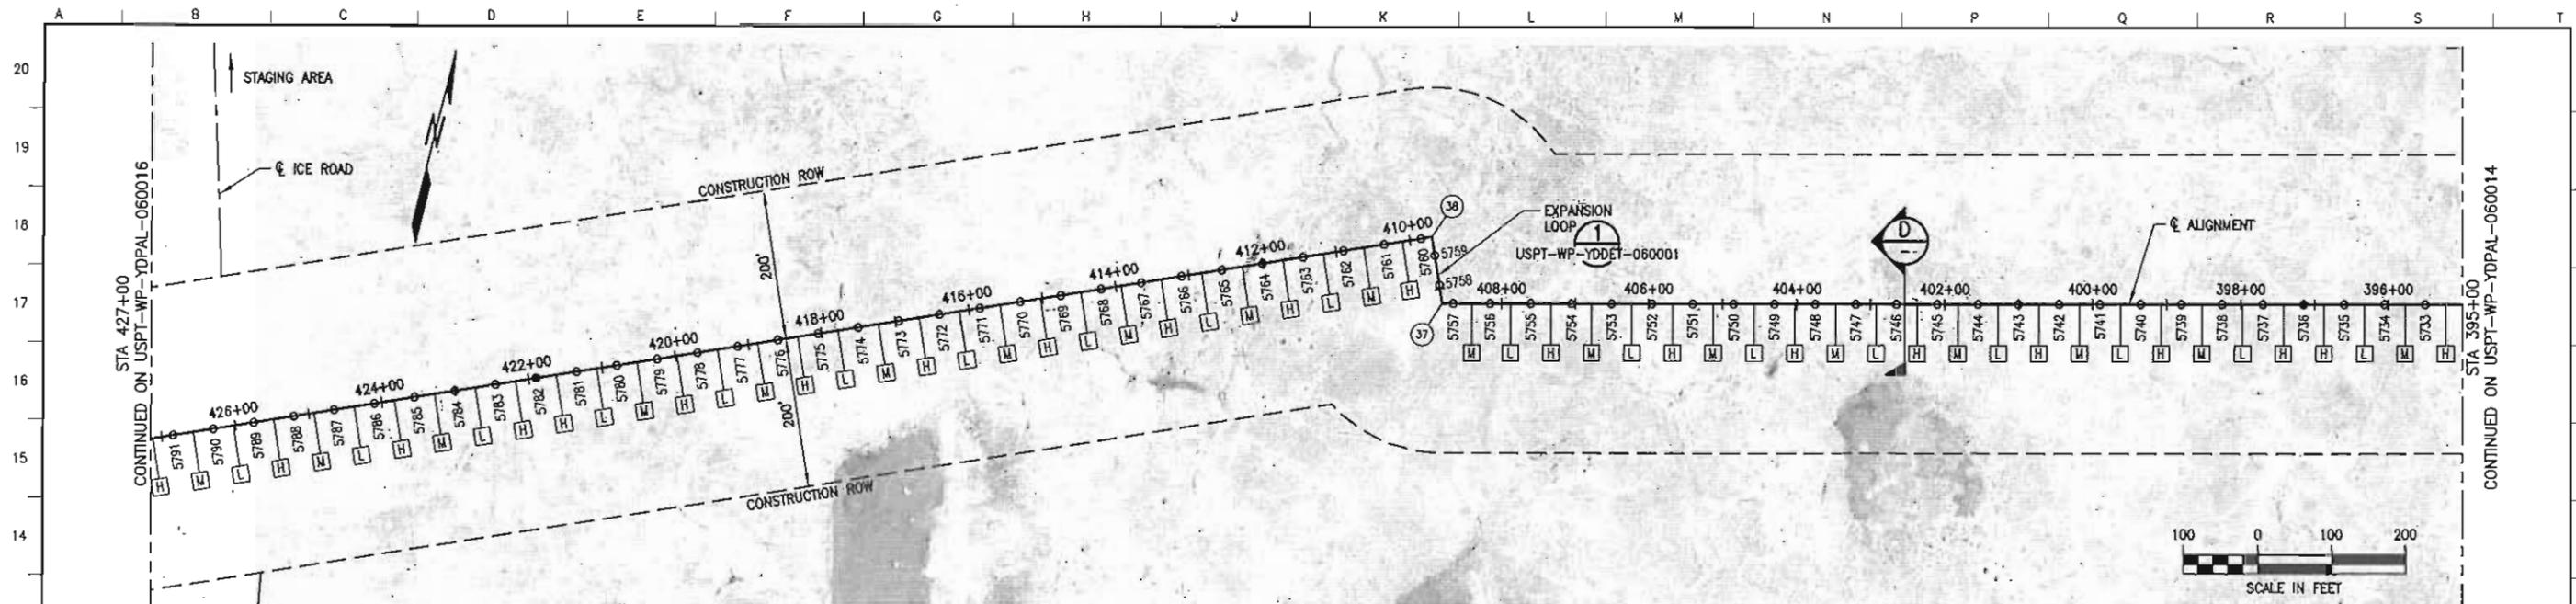

LOCATION	MATERIAL	WALL THK (IN)	FBE COATING (MIL)	INSULATION (IN)
395+00 TO 427+00	12.75" DIA API 5L X65	0.406	SHOP: 20 MIN, 32 MAX FIELD: 25 MIN, 39 MAX	3.0


POINT	DESCRIPTION	STATION	NORTHING	EASTING	ANGLE
37	PI	408+80.07	5910254.46	1569822.02	81.0°
38	PI	408+70.07	5910337.30	1569786.86	90.0°

PIPE SUPPORT IDENTIFICATION
 VS-08-704-XXXX
 VERTICAL SUPPORT
 LOCATION CODE
 UNIT/MODULE
 SEQUENTIAL NUMBER
 (SHOWN ON PLAN & PROFILE)

SUPPORT TYPE NOMENCLATURE
 XX-XX-XX-XX-XX
 EXPORT = "X"
 GUIDE = "G"
 SLIDE = "S"
 ANCHOR = "A"
 HSM LENGTH (FT)
 NOMINAL VSM DIAMETER (IN)
 VSM LENGTH (FT)
 MINIMUM EMBEDMENT (FT)

- NOTES**
- CENTERLINE OF ALIGNMENT = CENTERLINE OF 12"-LN-644-0048-ME8EV-37H.
 - STATIONING ALONG ALIGNMENT REFLECTS HORIZONTAL DISTANCE.
 - HORIZONTAL DATUM IS NAD83, ALASKA STATE PLANE ZONE 3, US FOOT.
 - VERTICAL DATUM IS POINT THOMSON UNIT MEAN LOWER LOW WATER (PTU MLLW).
 - FOR GUIDED AND ANCHORED SUPPORT DETAILS, SEE USPT-WP-YDDET-060010.
 - FOR SLIDING SUPPORT DETAILS, SEE USPT-WP-YDDET-060011.
 - FOR WIND-INDUCED VIBRATION MITIGATION PLAN AND TUNED VIBRATION ABSORBER (TVA) INSTALLATION, SEE USPT-WP-YDWINV-060001.

- LEGEND**
- GUIDED OR SLIDING SUPPORT
 - ANCHORED SUPPORT
 - ⊙ PI OR VPI LOCATION
 - H HIGH FREQUENCY TVA
 - L LOW FREQUENCY TVA
 - M MEDIUM FREQUENCY TVA

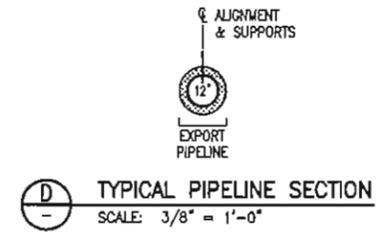

GROUND ELEV (FT)	SUPPORT NUMBER	STATION & OFFSET (FT)	SUPPORT TYPE	TOS ELEV (FT)
16.8	5791	426+85.07 0.0	XG-2.5-08-25-15	23.97
16.6	5790	424+30.07 0.0	XG-2.5-08-25-15	23.97
16.7	5789	425+75.07 0.0	XG-2.5-08-25-15	23.97
16.9	5788	425+20.07 0.0	XG-2.5-08-25-15	23.92
16.6	5787	424+65.07 0.0	XG-2.5-08-25-15	23.81
16.4	5786	424+10.07 0.0	XG-2.5-08-25-15	23.70
16.2	5785	423+55.07 0.0	XG-2.5-08-25-15	23.59
16.1	5784	423+00.07 0.0	XG-2.5-08-25-15	23.48
16.3	5783	422+45.07 0.0	XG-2.5-08-25-15	23.42
16.2	5782	421+90.07 0.0	XA-2.5-18-30-20	23.42
16.0	5781	421+35.07 0.0	XG-2.5-08-25-15	23.42
16.0	5780	420+80.07 0.0	XG-2.5-08-25-15	23.42
16.0	5779	420+25.07 0.0	XG-2.5-08-25-15	23.42
16.0	5778	419+70.07 0.0	XG-2.5-08-25-15	23.42
16.0	5777	419+15.07 0.0	XG-2.5-08-25-15	23.42
16.0	5776	418+60.07 0.0	XG-2.5-08-25-15	23.42
15.6	5775	418+05.07 0.0	XG-2.5-08-25-15	23.51
16.0	5774	417+50.07 0.0	XG-2.5-08-25-15	23.67
16.3	5773	416+95.07 0.0	XG-2.5-08-25-15	23.95
16.6	5772	416+40.07 0.0	XG-2.5-08-25-15	24.22
17.0	5771	415+85.07 0.0	XG-2.5-08-25-15	24.50
17.5	5770	415+30.07 0.0	XG-2.5-08-25-15	24.89
17.6	5769	414+75.07 0.0	XG-2.5-08-25-15	24.80
17.6	5768	414+20.07 0.0	XG-2.5-08-25-15	24.91
18.0	5767	413+65.07 0.0	XG-2.5-08-25-15	24.99
17.9	5766	413+10.07 0.0	XG-2.5-08-25-15	24.99
17.9	5765	412+55.07 0.0	XG-2.5-08-25-15	24.99
17.7	5764	412+00.07 0.0	XG-2.5-08-25-15	24.99
17.6	5763	411+45.07 0.0	XG-2.5-08-25-15	24.99
17.7	5762	410+90.07 0.0	XG-2.5-08-25-15	24.99
17.9	5761	410+35.07 0.0	XG-2.5-12-25-15	24.99
17.4	5760	409+85.07 0.0	XS-08-12-25-15	24.99
17.4	5759	409+45.07 0.0	XS-08-12-25-15	24.99
17.6	5758	408+95.07 0.0	XS-08-12-25-15	24.99
17.7	5757	408+55.07 0.0	XS-08-12-25-15	24.99
17.7	5756	408+15.07 0.0	XG-2.5-12-25-15	24.99
17.3	5755	407+60.07 0.0	XG-2.5-12-25-15	24.99
17.0	5754	407+05.07 0.0	XG-2.5-08-25-15	24.92
17.1	5753	406+50.07 0.0	XG-2.5-08-25-15	24.85
17.0	5752	405+95.07 0.0	XG-2.5-08-25-15	24.79
16.9	5751	405+40.07 0.0	XG-2.5-08-25-15	24.72
17.0	5750	404+85.07 0.0	XG-2.5-08-25-15	24.65
17.2	5749	404+30.07 0.0	XG-2.5-08-25-15	24.58
17.0	5748	403+75.07 0.0	XG-2.5-08-25-15	24.51
16.7	5747	403+20.07 0.0	XG-2.5-08-25-15	24.44
16.8	5746	402+65.07 0.0	XG-2.5-08-25-15	24.37
16.9	5745	402+10.07 0.0	XG-2.5-08-25-15	24.30
16.7	5744	401+55.07 0.0	XG-2.5-08-25-15	24.24
16.6	5743	401+00.07 0.0	XG-2.5-08-25-15	24.17
16.7	5742	400+45.07 0.0	XG-2.5-08-25-15	24.10
16.7	5741	399+90.07 0.0	XG-2.5-08-25-15	24.03
16.6	5740	399+35.07 0.0	XG-2.5-08-25-15	23.96
16.6	5739	398+80.07 0.0	XG-2.5-08-25-15	23.89
16.7	5738	398+25.07 0.0	XG-2.5-08-25-15	23.82
16.7	5737	397+70.07 0.0	XG-2.5-08-25-15	23.75
16.7	5736	397+15.07 0.0	XA-2.5-18-30-20	23.75
16.5	5735	396+60.07 0.0	XG-2.5-08-25-15	23.75
16.4	5734	396+05.07 0.0	XG-2.5-08-25-15	23.75
16.4	5733	395+50.07 0.0	XG-2.5-08-25-15	23.67

REFERENCE DRAWINGS	DESCRIPTION
USPT-WP-YOSYM-060001	PROJECT NOTES, ABBREVIATIONS AND LEGEND
USPT-WP-YDPAL-060001	SITE PLAN
USPT-WP-YDDET-060001	TYPICAL EXPANSION LOOP DETAIL
USPT-WP-YDDET-060010	GUIDED AND ANCHORED SUPPORT DETAILS
USPT-WP-YDDET-060011	SLIDING SUPPORT DETAILS
USPT-WP-YDWINV-060001	WIND-INDUCED VIBRATION MITIGATION PLAN



REV	DATE	DESCRIPTION	BY	CHK	APPD	PROJ
10	12/28/11	ISSUED FOR CONSTRUCTION				


ExxonMobil
Development

WorleyParsons **FLUOR** Baker

POINT THOMSON			
MODULE	DRAWN	DATE	SCALE
	R. HOBBS	12/11	AS SHOWN
DRAWING NO.	USPT-WP-YDPAL-060015-001	SHEET	1 of 1
ALASKA	CHK APPD	NO	REV

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FILENAME: USPT-WP-YDPAL-060015-001

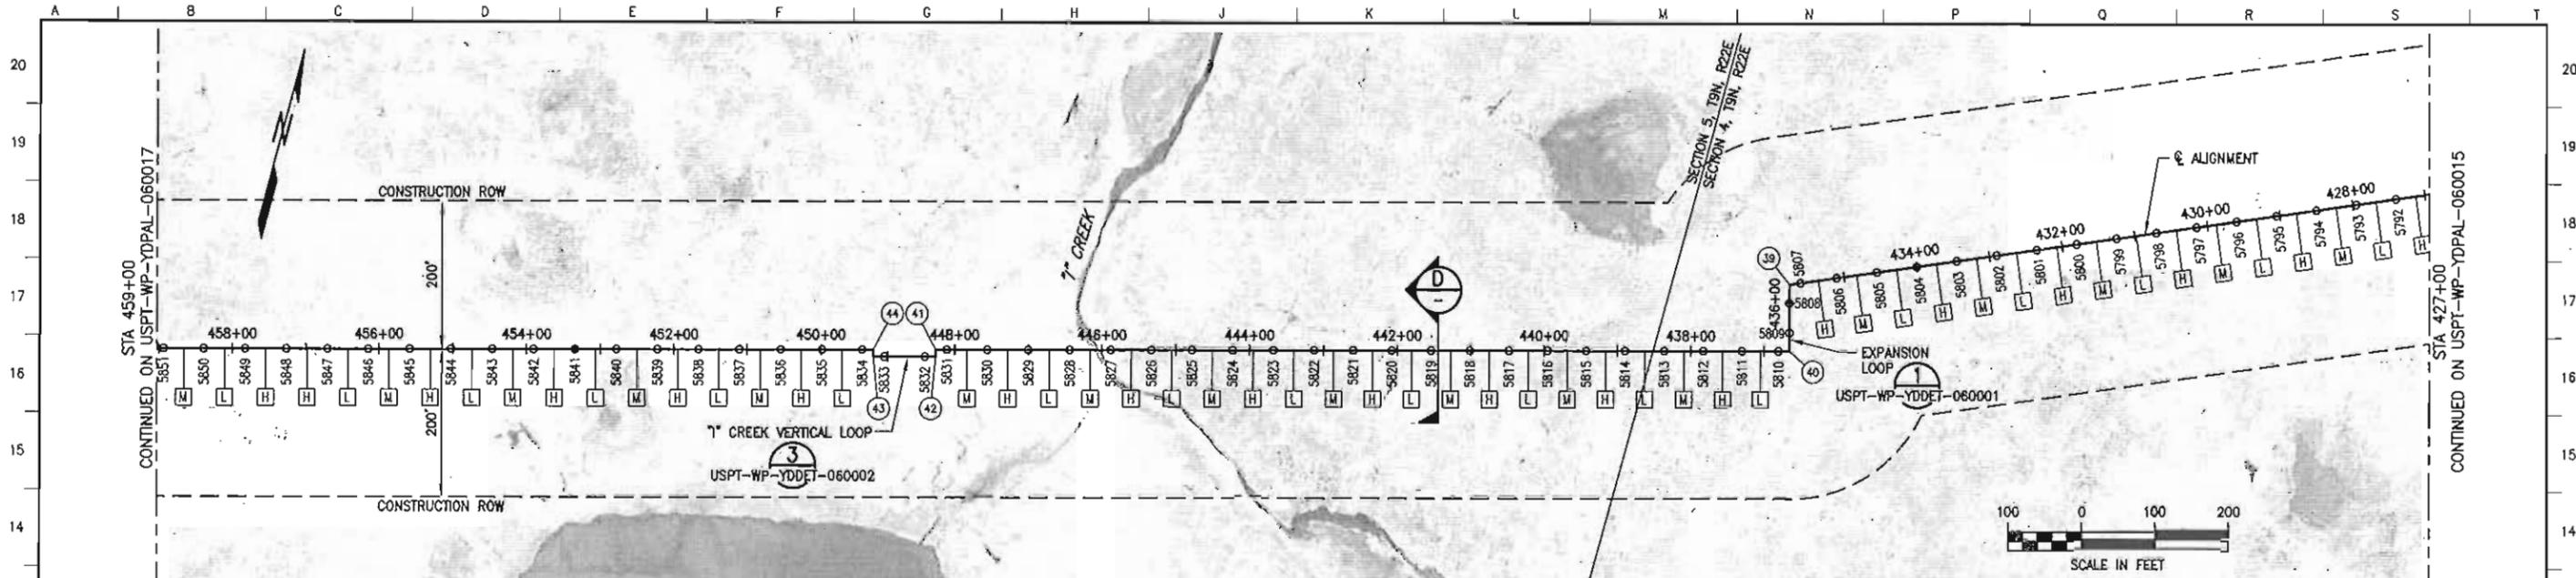

LOCATION	MATERIAL	WALL THK (IN)	FBE COATING (MIL)	INSULATION (IN)
427+00 TO 459+00	12.75" DIA API 5L X65	0.406	SHOP: 20 MIN, 32 MAX FIELD: 25 MIN, 39 MAX	3.0

POINT #	DESCRIPTION	STATION	NORTHING	EASTING	ANGLE
39	PI	435+75.07	5909319.42	1567388.95	82.0°
40	PI	436+65.07	5909232.49	1567412.25	90.0°
41	PI/VPI	448+25.57	5908932.12	1566291.29	90.0° (R)
42	PI/VPI	448+34.82	5908923.18	1566293.69	90.0°
43	PI/VPI	449+19.82	5908901.18	1566211.58	90.0° (R)
44	PI/VPI	449+29.07	5908910.12	1566209.19	90.0° (R)

(R) ANGLE = ROLLED

PIPE SUPPORT IDENTIFICATION

VS-06-704-XXXX

VERTICAL SUPPORT
LOCATION CODE
UNIT/MODULE
SEQUENTIAL NUMBER
(SHOWN ON PLAN & PROFILE)

SUPPORT TYPE NOMENCLATURE



XX-XX-XX-XX-XX

EXPORT = "X"
GUIDE = "G"
SLIDE = "S"
ANCHOR = "A"

HSM LENGTH (FT)
NOMINAL VSM DIAMETER (IN)
VSM LENGTH (FT)
MINIMUM EMBEDMENT (FT)

- NOTES**
- CENTERLINE OF ALIGNMENT = CENTERLINE OF 12"-LN-644-0049-ME8EV-3"H.
 - STATIONING ALONG ALIGNMENT REFLECTS HORIZONTAL DISTANCE.
 - HORIZONTAL DATUM IS NAD83, ALASKA STATE PLANE ZONE 3, US FOOT.
 - VERTICAL DATUM IS POINT THOMSON UNIT MEAN LOWER LOW WATER (PTU MLLW).
 - FOR GUIDED AND ANCHORED SUPPORT DETAILS, SEE USPT-WP-YDDET-060010.
 - FOR SLIDING SUPPORT DETAILS, SEE USPT-WP-YDDET-060011.
 - FOR WIND-INDUCED VIBRATION MITIGATION PLAN AND TUNED VIBRATION ABSORBER (TVA) INSTALLATION, SEE USPT-WP-YDWN-060001.


- LEGEND**
- GUIDED OR SLIDING SUPPORT
 - ANCHORED SUPPORT
 - ⊙ PI OR VPI LOCATION
 - H HIGH FREQUENCY TVA
 - L LOW FREQUENCY TVA
 - M MEDIUM FREQUENCY TVA

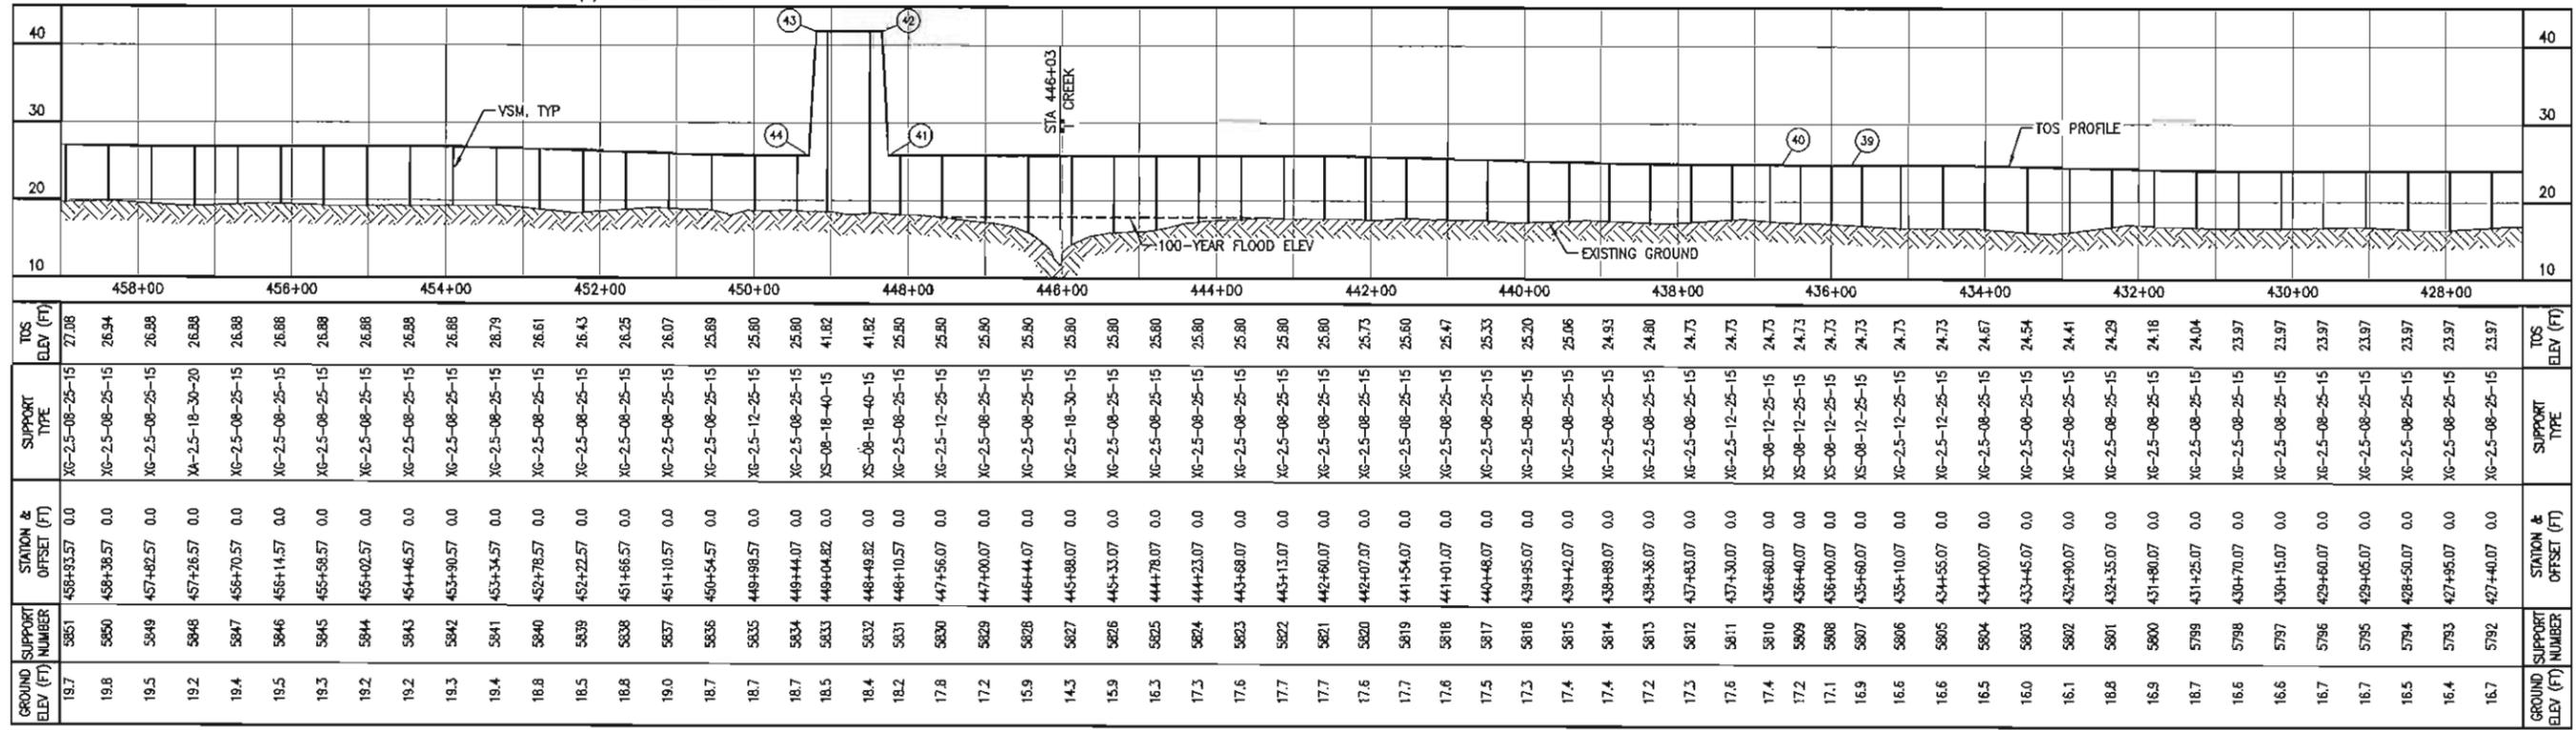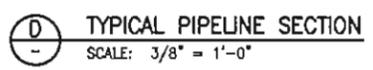

REFERENCE DRAWINGS	DESCRIPTION
USPT-WP-YDSM-060001	PROJECT NOTES, ABBREVIATIONS AND LEGEND
USPT-WP-YDPA-060001	SITE PLAN
USPT-WP-YDDET-060001	TYPICAL EXPANSION LOOP DETAIL
USPT-WP-YDDET-060010	GUIDED AND ANCHORED SUPPORT DETAILS
USPT-WP-YDDET-060011	SLIDING SUPPORT DETAILS
USPT-WP-YDWN-060001	WIND-INDUCED VIBRATION MITIGATION PLAN




REV	DATE	DESCRIPTION	BY	CHK	APPO	PROJ
10	12/28/11	ISSUED FOR CONSTRUCTION	RF-11	JAG	PAC	GMP

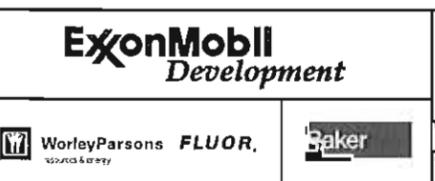

EXPORT PIPELINE - PIPELINE PIPELINE ALIGNMENT SHEET PLAN & PROFILE STA 427+00 TO STA 459+00			
POINT THOMSON	DATE	SCALE	CHK
MODULE	12/11	AS SHOWN	JAG
DRAWING NO.	USPT-WP-YDPA-060016-001	SHEET	1 of 1

T:\122263 - Point Thomson EPC\03 - CADD\01 - Export\USPT-WP-YDPA-060012 - 060020.dwg, 18, 12/22/2011 11:48:20 AM, JLabrum


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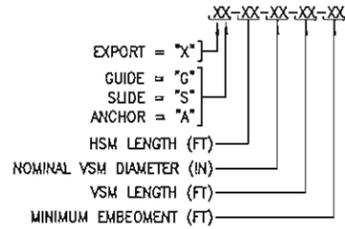
LOCATION	MATERIAL	WALL THK (IN)	FBE COATING (MIL)	INSULATION (IN)
459+00 TO 491+00	12.75" DIA API 5L X65	0.406	SHOP: 20 MIN, 32 MAX FIELD: 25 MIN, 39 MAX	3.0

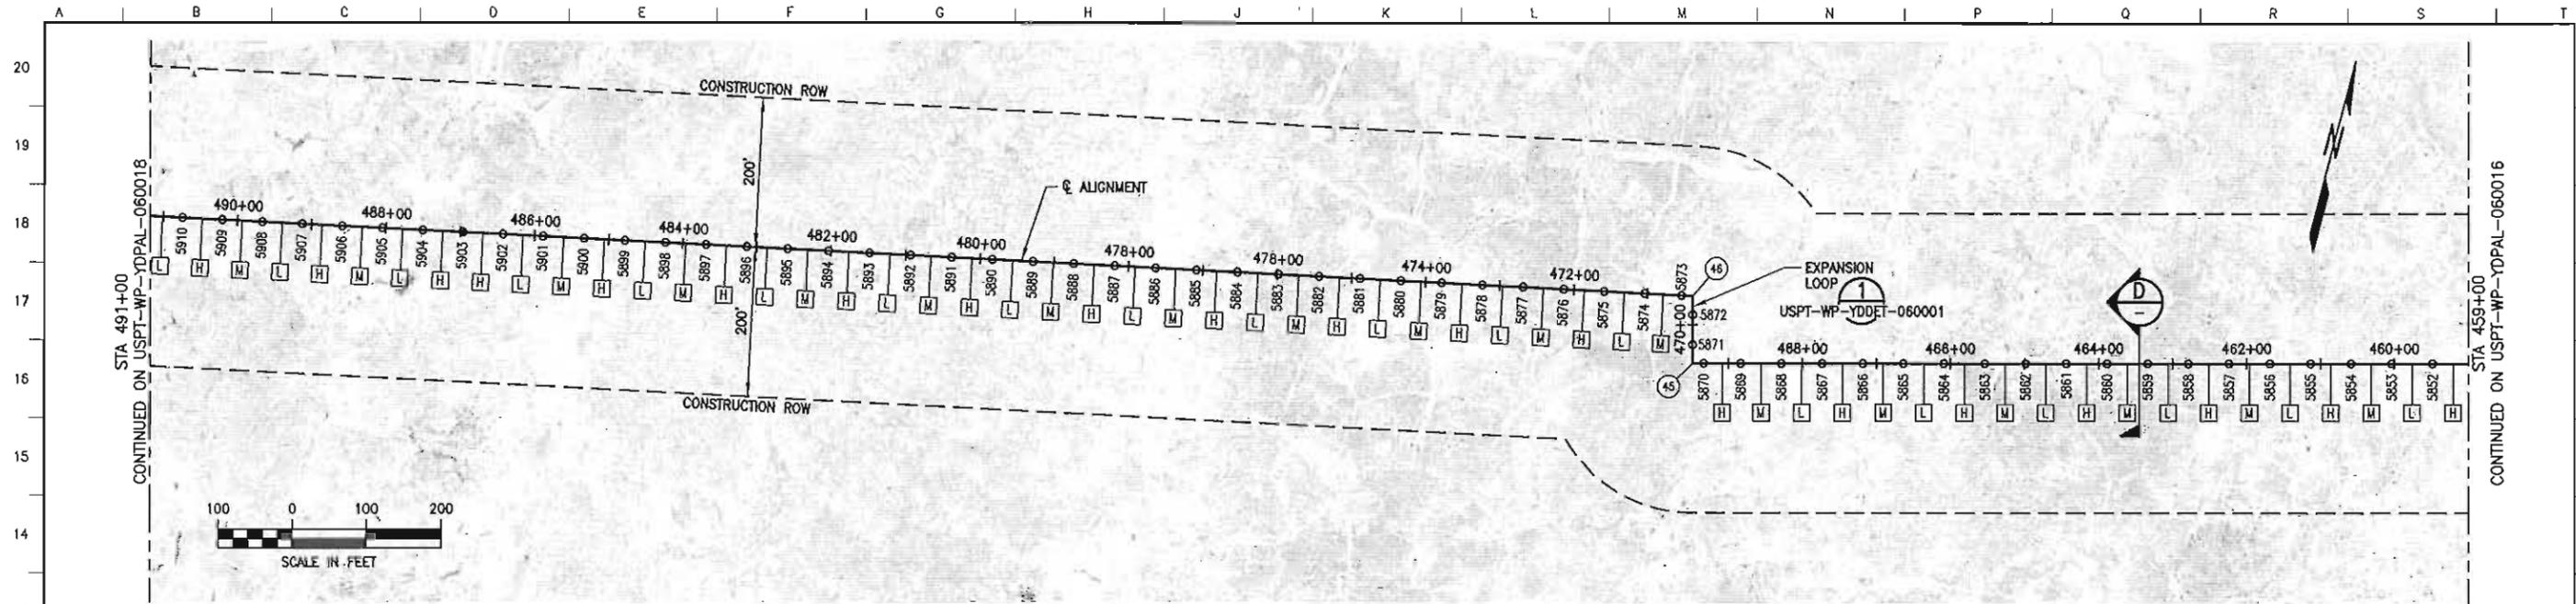POINT #	DESCRIPTION	STATION	NORTHING	EASTING	ANGLE
45	PI	469+48.57	5908387.41	1564258.51	90.0°
46	PI	470+38.57	5908474.35	1564235.21	87.09°

PIPE SUPPORT IDENTIFICATION



SUPPORT TYPE NOMENCLATURE


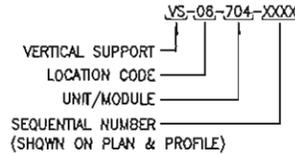


NOTES

- CENTERLINE OF ALIGNMENT = CENTERLINE OF 12"-LN-644-0049-ME8EV-37H.
- STATIONING ALONG ALIGNMENT REFLECTS HORIZONTAL DISTANCE.
- HORIZONTAL DATUM IS NAD83, ALASKA STATE PLANE ZONE 3, US FOOT.
- VERTICAL DATUM IS POINT THOMSON UNIT MEAN LOWER LOW WATER (PTU MLLW).
- FOR GUIDED AND ANCHORED SUPPORT DETAILS, SEE USPT-WP-YDOET-060010.
- FOR SLIDING SUPPORT DETAILS, SEE USPT-WP-YDOET-060011.
- FOR WIND-INDUCED VIBRATION MITIGATION PLAN AND TUNED VIBRATION ABSORBER (TVA) INSTALLATION, SEE USPT-WP-YDWV-060001.


LEGEND

- GUIDED OR SLIDING SUPPORT
- ANCHORED SUPPORT
- ⊙ PI OR VPI LOCATION
- ⊠ HIGH FREQUENCY TVA
- ⊡ LOW FREQUENCY TVA
- ⊞ MEDIUM FREQUENCY TVA

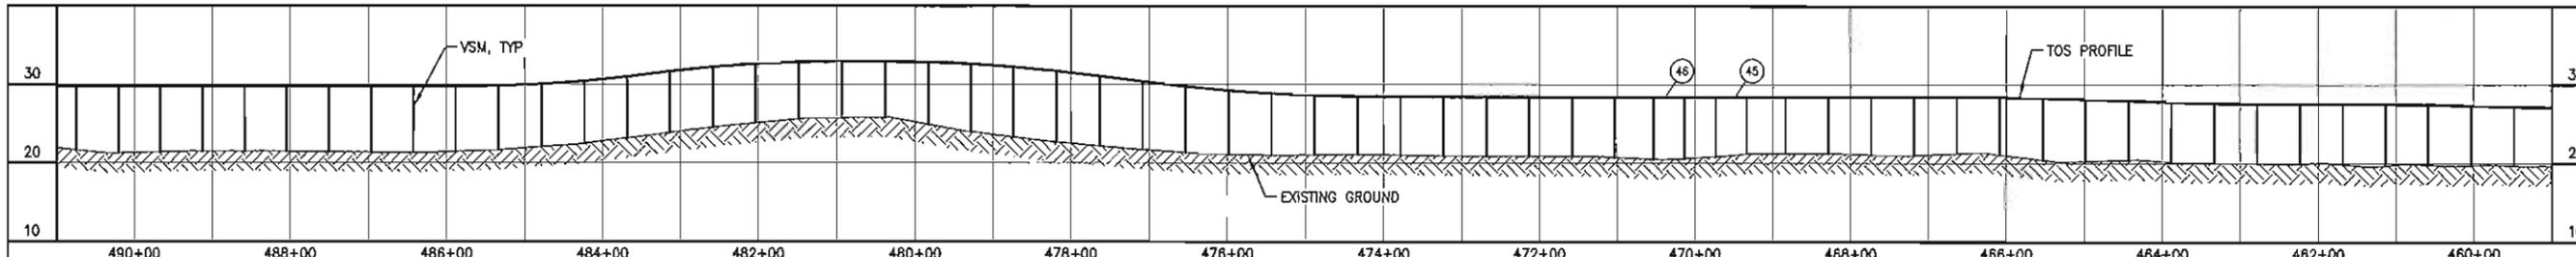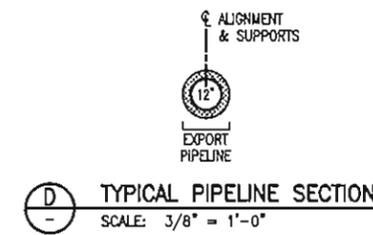

GROUND SUPPORT ELEV (FT)	GROUND SUPPORT NUMBER	STATION & OFFSET (FT)	SUPPORT TYPE	TDS ELEV (FT)
21.7	5910	490+74.57 0.0	XG-2.5-08-25-15	29.75
21.3	5909	490+20.57 0.0	XG-2.5-08-25-15	29.75
21.4	5908	489+66.57 0.0	XG-2.5-08-25-15	29.75
21.5	5907	489+12.57 0.0	XG-2.5-08-25-15	29.75
21.5	5906	488+96.57 0.0	XG-2.5-08-25-15	29.75
21.5	5905	488+04.57 0.0	XG-2.5-08-25-15	29.75
21.4	5904	487+50.57 0.0	XG-2.5-08-25-15	29.75
21.4	5903	486+96.57 0.0	XA-2.5-18-30-20	29.75
21.3	5902	486+42.57 0.0	XG-2.5-08-25-15	29.75
21.5	5901	485+88.57 0.0	XG-2.5-08-25-15	29.75
21.7	5900	485+33.57 0.0	XG-2.5-08-25-15	29.82
22.1	5899	484+78.57 0.0	XG-2.5-08-25-15	30.04
22.5	5898	484+23.57 0.0	XG-2.5-08-25-15	30.43
23.2	5897	483+68.57 0.0	XG-2.5-08-25-15	30.98
23.9	5896	483+13.57 0.0	XG-2.5-08-25-15	31.86
24.5	5895	482+58.57 0.0	XG-2.5-08-25-15	32.21
25.1	5894	482+03.57 0.0	XG-2.5-08-25-15	32.60
25.6	5893	481+48.57 0.0	XG-2.5-08-25-15	32.82
25.8	5892	480+93.57 0.0	XG-2.5-08-25-15	32.89
25.8	5891	480+38.57 0.0	XG-2.5-08-25-15	32.89
24.9	5890	479+83.57 0.0	XG-2.5-08-25-15	32.84
24.0	5889	479+28.57 0.0	XG-2.5-08-25-15	32.82
23.3	5888	478+73.57 0.0	XG-2.5-08-25-15	32.23
22.7	5887	478+18.57 0.0	XG-2.5-08-25-15	31.88
22.2	5886	477+63.57 0.0	XG-2.5-08-25-15	31.04
21.7	5885	477+08.57 0.0	XG-2.5-08-25-15	30.39
21.3	5884	476+53.57 0.0	XG-2.5-08-25-15	29.75
21.1	5883	475+98.57 0.0	XG-2.5-08-25-15	29.20
21.0	5882	475+43.57 0.0	XG-2.5-08-25-15	28.82
21.0	5881	474+88.57 0.0	XG-2.5-08-25-15	28.80
21.1	5880	474+33.57 0.0	XG-2.5-08-25-15	28.46
21.0	5879	473+78.57 0.0	XG-2.5-08-25-15	28.40
20.9	5878	473+23.57 0.0	XG-2.5-08-25-15	28.40
20.9	5877	472+68.57 0.0	XG-2.5-08-25-15	28.40
20.9	5876	472+13.57 0.0	XG-2.5-08-25-15	28.40
20.9	5875	471+58.57 0.0	XG-2.5-12-25-15	28.40
20.7	5874	471+03.57 0.0	XG-2.5-12-25-15	28.40
20.5	5873	470+48.57 0.0	XS-08-12-25-15	28.40
20.6	5872	470+43.57 0.0	XS-08-12-25-15	28.40
20.9	5871	469+88.57 0.0	XS-08-12-25-15	28.40
21.2	5870	469+33.57 0.0	XS-08-12-25-15	28.40
21.2	5869	468+78.57 0.0	XG-2.5-12-25-15	28.40
21.3	5868	468+23.57 0.0	XG-2.5-08-25-15	28.40
21.1	5867	467+68.57 0.0	XG-2.5-08-25-15	28.40
21.0	5866	467+13.57 0.0	XG-2.5-08-25-15	28.40
21.3	5865	466+58.57 0.0	XG-2.5-08-25-15	28.40
21.1	5864	466+3.57 0.0	XG-2.5-08-25-15	28.40
20.4	5863	465+48.57 0.0	XG-2.5-08-25-15	28.32
20.3	5862	464+93.57 0.0	XG-2.5-08-25-15	28.15
20.4	5861	464+38.57 0.0	XG-2.5-08-25-15	27.98
20.2	5860	463+83.57 0.0	XG-2.5-08-25-15	27.80
20.1	5859	463+28.57 0.0	XG-2.5-08-25-15	27.63
20.0	5858	462+73.57 0.0	XG-2.5-08-25-15	27.55
19.9	5857	462+18.57 0.0	XG-2.5-08-25-15	27.55
19.9	5856	461+63.57 0.0	XG-2.5-08-25-15	27.55
19.7	5855	461+8.57 0.0	XG-2.5-08-25-15	27.55
19.8	5854	460+53.57 0.0	XG-2.5-08-25-15	27.48
19.8	5853	460+3.57 0.0	XG-2.5-08-25-15	27.35
19.7	5852	459+48.57 0.0	XG-2.5-08-25-15	27.21

REFERENCE DRAWINGS	DESCRIPTION
USPT-WP-YDYM-060001	PROJECT NOTES, ABBREVIATIONS AND LEGEND
USPT-WP-YDPAL-060001	SITE PLAN
USPT-WP-YDOET-060001	TYPICAL EXPANSION LOOP DETAIL
USPT-WP-YDOET-060010	GUIDED AND ANCHORED SUPPORT DETAILS
USPT-WP-YDOET-060011	SLIDING SUPPORT DETAILS
USPT-WP-YDWV-060001	WIND-INDUCED VIBRATION MITIGATION PLAN

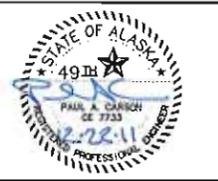

REV	DATE	DESCRIPTION	BY	CHK	APP	PROJ
10	12/28/11	ISSUED FOR CONSTRUCTION				


ExxonMobil
Development

WorleyParsons | FLUOR | Baker

EXPURT PIPELINE - PIPELINE ALIGNMENT SHEET PLAN & PROFILE		STA 459+00 TO STA 491+00	
POINT THOMSON	DATE	SCALE	CHK
R. HOBBS	12/11	AS SHOWN	JOB
DRAWING NO.	USPT-WP-YDPAL-060017-001	SHEET	REV
		1 of 1	10

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FILENAME: USPT-WP-YDPAL-060017-001

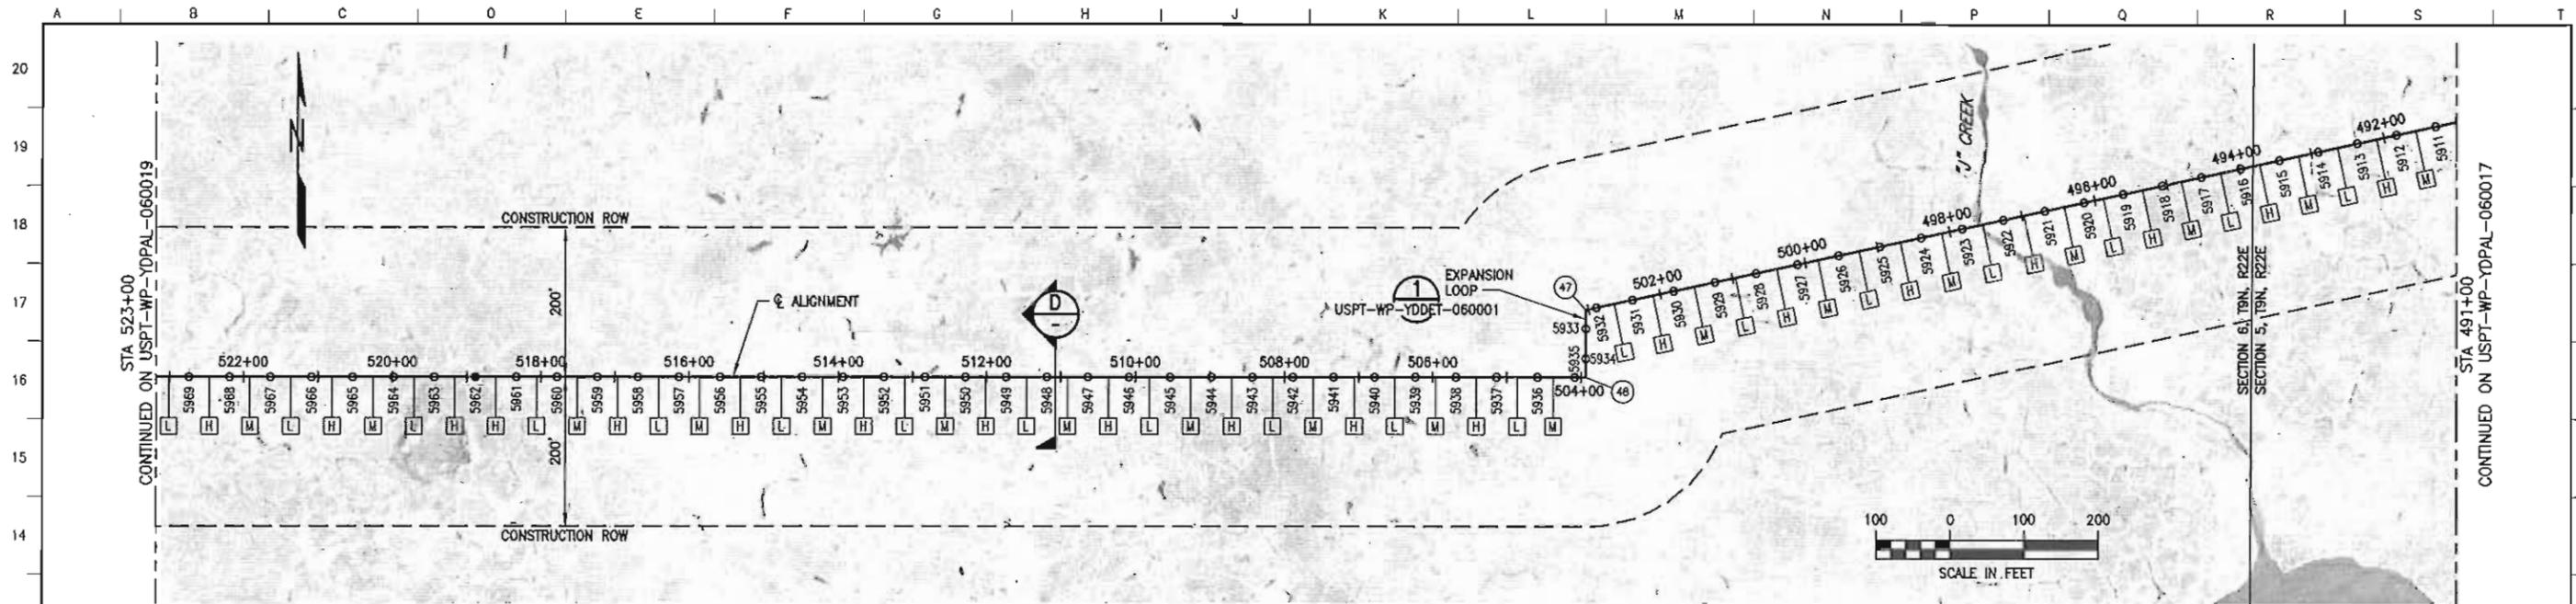

LOCATION	MATERIAL	WALL THK (IN)	FBE COATING (MIL)	INSULATION (IN)
491+00 TO 523+00	12.75" DIA API 5L X65	0.406	SHOP: 20 MIN, 32 MAX FIELD: 25 MIN, 39 MAX	3.0



POINT	DESCRIPTION	STATION	NORTHING	EASTING	ANGLE
47	PI	503+03.57	5907790.47	1561042.64	77.91°
48	PI	503+93.57	5907700.47	1561042.64	90.0°

PIPE SUPPORT IDENTIFICATION
 VS-06-704-XXXX
 VERTICAL SUPPORT
 LOCATION CODE
 UNIT/MODULE
 SEQUENTIAL NUMBER (SHOWN ON PLAN & PROFILE)

SUPPORT TYPE NOMENCLATURE
 XX-XX-XX-XX-XX
 EXPORT = "X"
 GUIDE = "G"
 SLIDE = "S"
 ANCHOR = "A"
 HSM LENGTH (FT)
 NOMINAL VSM DIAMETER (IN)
 VSM LENGTH (FT)
 MINIMUM EMBEDMENT (FT)

- NOTES**
- CENTERLINE OF ALIGNMENT = CENTERLINE OF 12"-LN-644-0049-MEBEV-3TH.
 - STATIONING ALONG ALIGNMENT REFLECTS HORIZONTAL DISTANCE.
 - HORIZONTAL DATUM IS NAD83, ALASKA STATE PLANE ZONE 3, US FOOT.
 - VERTICAL DATUM IS POINT THOMSON UNIT MEAN LOWER LOW WATER (PTU MLW).
 - FOR GUIDED AND ANCHORED SUPPORT DETAILS, SEE USPT-WP-YDDET-060010.
 - FOR SLIDING SUPPORT DETAILS, SEE USPT-WP-YDDET-060011.
 - FOR WIND-INDUCED VIBRATION MITIGATION PLAN AND TUNED VIBRATION ABSORBER (TVA) INSTALLATION, SEE USPT-WP-YDWM-060001.

- LEGEND**
- GUIDED OR SLIDING SUPPORT
 - ANCHORED SUPPORT
 - ① PI OR VPI LOCATION
 - HIGH FREQUENCY TVA
 - LOW FREQUENCY TVA
 - MEDIUM FREQUENCY TVA

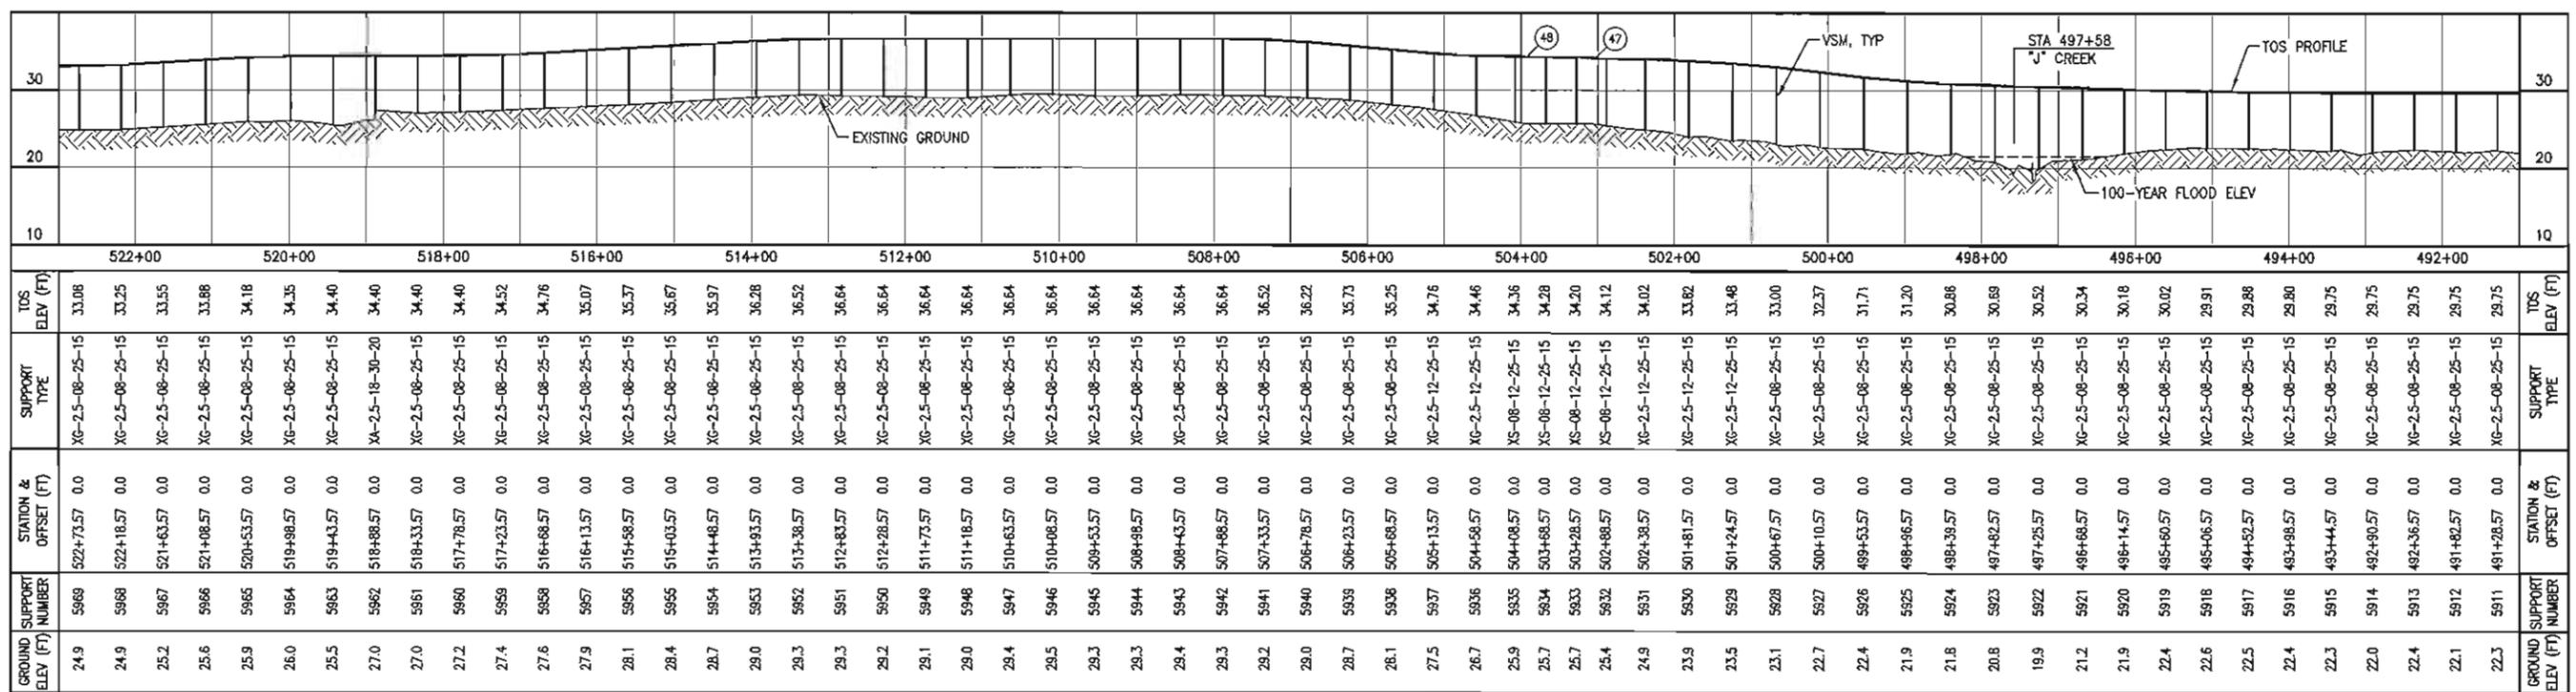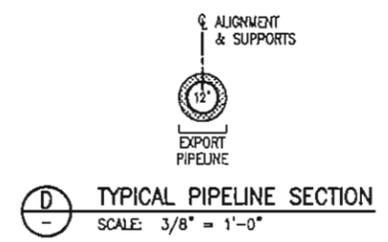

REFERENCE DRAWINGS	DESCRIPTION
USPT-WP-YDSM-060001	PROJECT NOTES, ABBREVIATIONS AND LEGEND
USPT-WP-YDPAL-060001	SITE PLAN
USPT-WP-YDDET-060001	TYPICAL EXPANSION LOOP DETAIL
USPT-WP-YDDET-060010	GUIDED AND ANCHORED SUPPORT DETAILS
USPT-WP-YDDET-060011	SLIDING SUPPORT DETAILS
USPT-WP-YDWM-060001	WIND-INDUCED VIBRATION MITIGATION PLAN



REV	DATE	DESCRIPTION	BY	CHK	APPD	PROJ
10	12/28/11	ISSUED FOR CONSTRUCTION	RH	AM	PKC	CLP


ExxonMobil
Development

WorleyParsons FLUOR Baker

EXPORT PIPELINE - PIPELINE ALIGNMENT SHEET PLAN & PROFILE				ALASKA			
STATION STA 491+00 TO STA 523+00				MODULE	DRAWN	DATE	SCALE
				R. HOBBS		12/11	AS SHOWN
				CHEK	APPD	PKC	PKC
DRAWING NO. USPT-WP-YDPAL-060018-001				SHEET 1 of 1			

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FILENAME: USPT-WP-YDPAL-060018-001

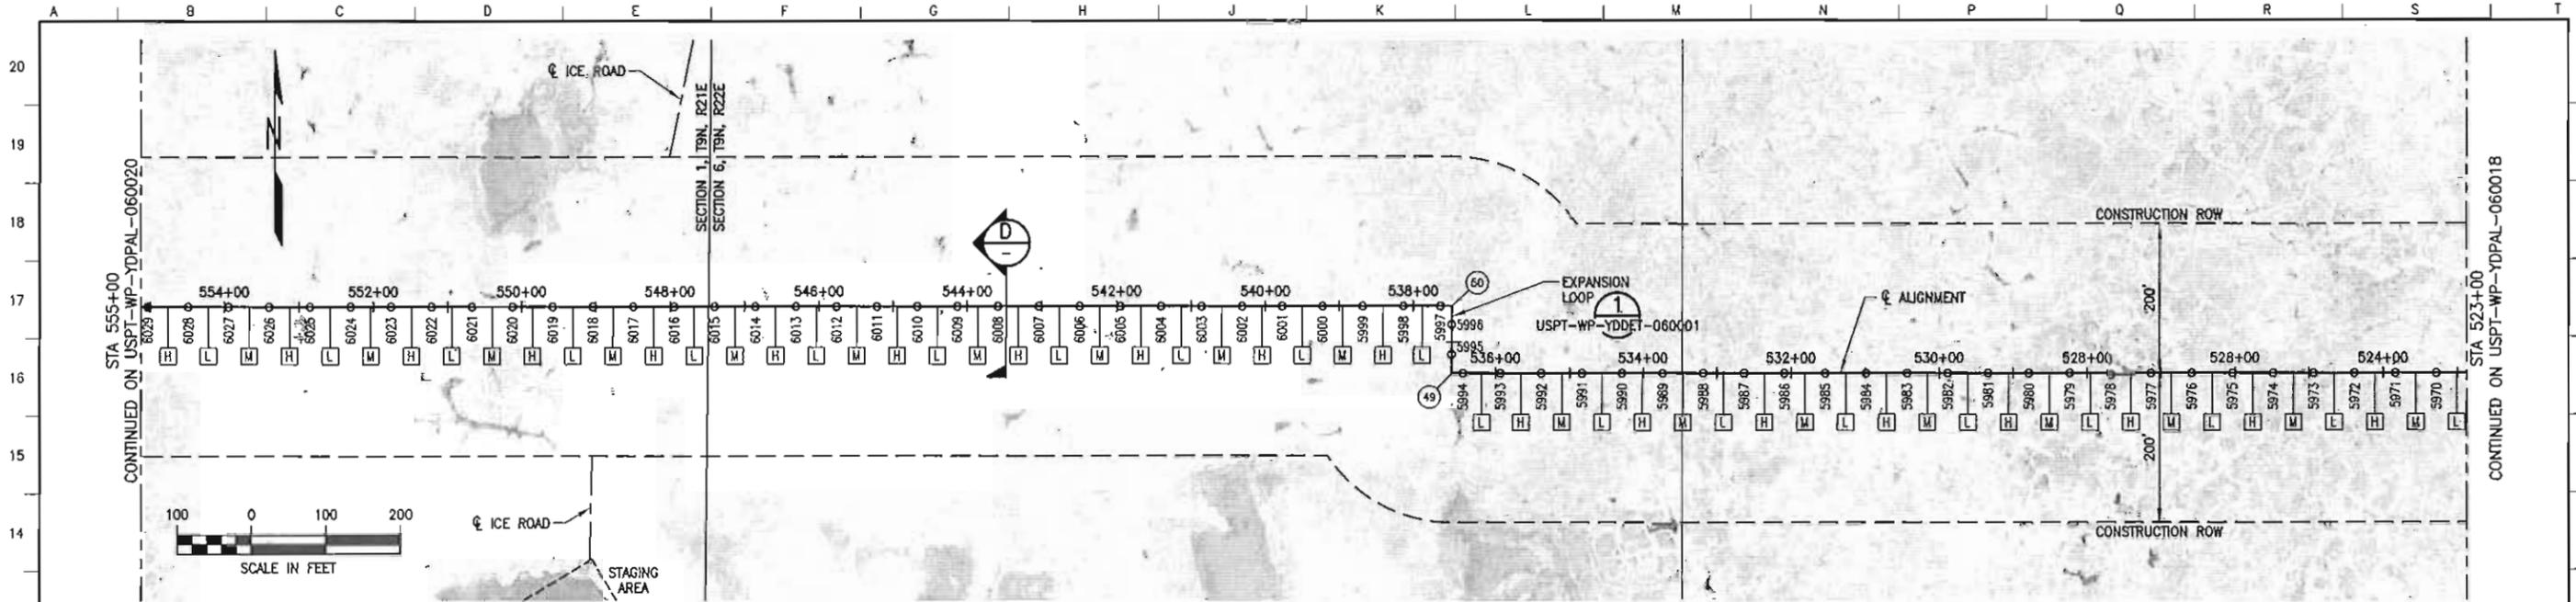

LOCATION	MATERIAL	WALL THK (IN)	FBE COATING (MIL)	INSULATION (IN)
523+00 TO 555+00	12.75" DIA API 5L X65	0.406	SHOP: 20 MIN, 32 MAX FIELD: 25 MIN, 39 MAX	3.0



POINT #	DESCRIPTION	STATION	NORTHING	EASTING	ANGLE
49	PI	536+58.57	5907700.43	1557777.64	90.0°
50	PI	537+48.57	5907790.43	1557777.64	90.0°

PIPE SUPPORT IDENTIFICATION
 VS-06-704-XXXX
 VERTICAL SUPPORT
 LOCATION CODE
 UNIT/MODULE
 SEQUENTIAL NUMBER
 (SHOWN ON PLAN & PROFILE)

SUPPORT TYPE NOMENCLATURE
 XX-XX-XX-XX-XX
 EXPORT = "X"
 GUIDE = "G"
 SLOPE = "S"
 ANCHOR = "A"
 HSM LENGTH (FT)
 NOMINAL VSM DIAMETER (IN)
 VSM LENGTH (FT)
 MINIMUM EMBEDMENT (FT)

NOTES
 1. CENTERLINE OF ALIGNMENT = CENTERLINE OF 12"-LN-644-0049-ME8EV-3"H.
 2. STATIONING ALONG ALIGNMENT REFLECTS HORIZONTAL DISTANCE.
 3. HORIZONTAL DATUM IS NAD83, ALASKA STATE PLANE ZONE 3, US FOOT.
 4. VERTICAL DATUM IS POINT THOMSON UNIT MEAN LOWER LOW WATER (PTU MLLW).
 5. FOR GUIDED AND ANCHORED SUPPORT DETAILS, SEE USPT-WP-YDDET-060010.
 6. FOR SLIDING SUPPORT DETAILS, SEE USPT-WP-YDDET-060011.
 7. FOR WIND-INDUCED VIBRATION MITIGATION PLAN AND TUNED VIBRATION ABSORBER (TVA) INSTALLATION, SEE USPT-WP-YDWN-060001.

LEGEND
 ○ GUIDED OR SLIDING SUPPORT □ HIGH FREQUENCY TVA
 ● ANCHORED SUPPORT □ LOW FREQUENCY TVA
 ⊙ PI OR VPI LOCATION □ MEDIUM FREQUENCY TVA

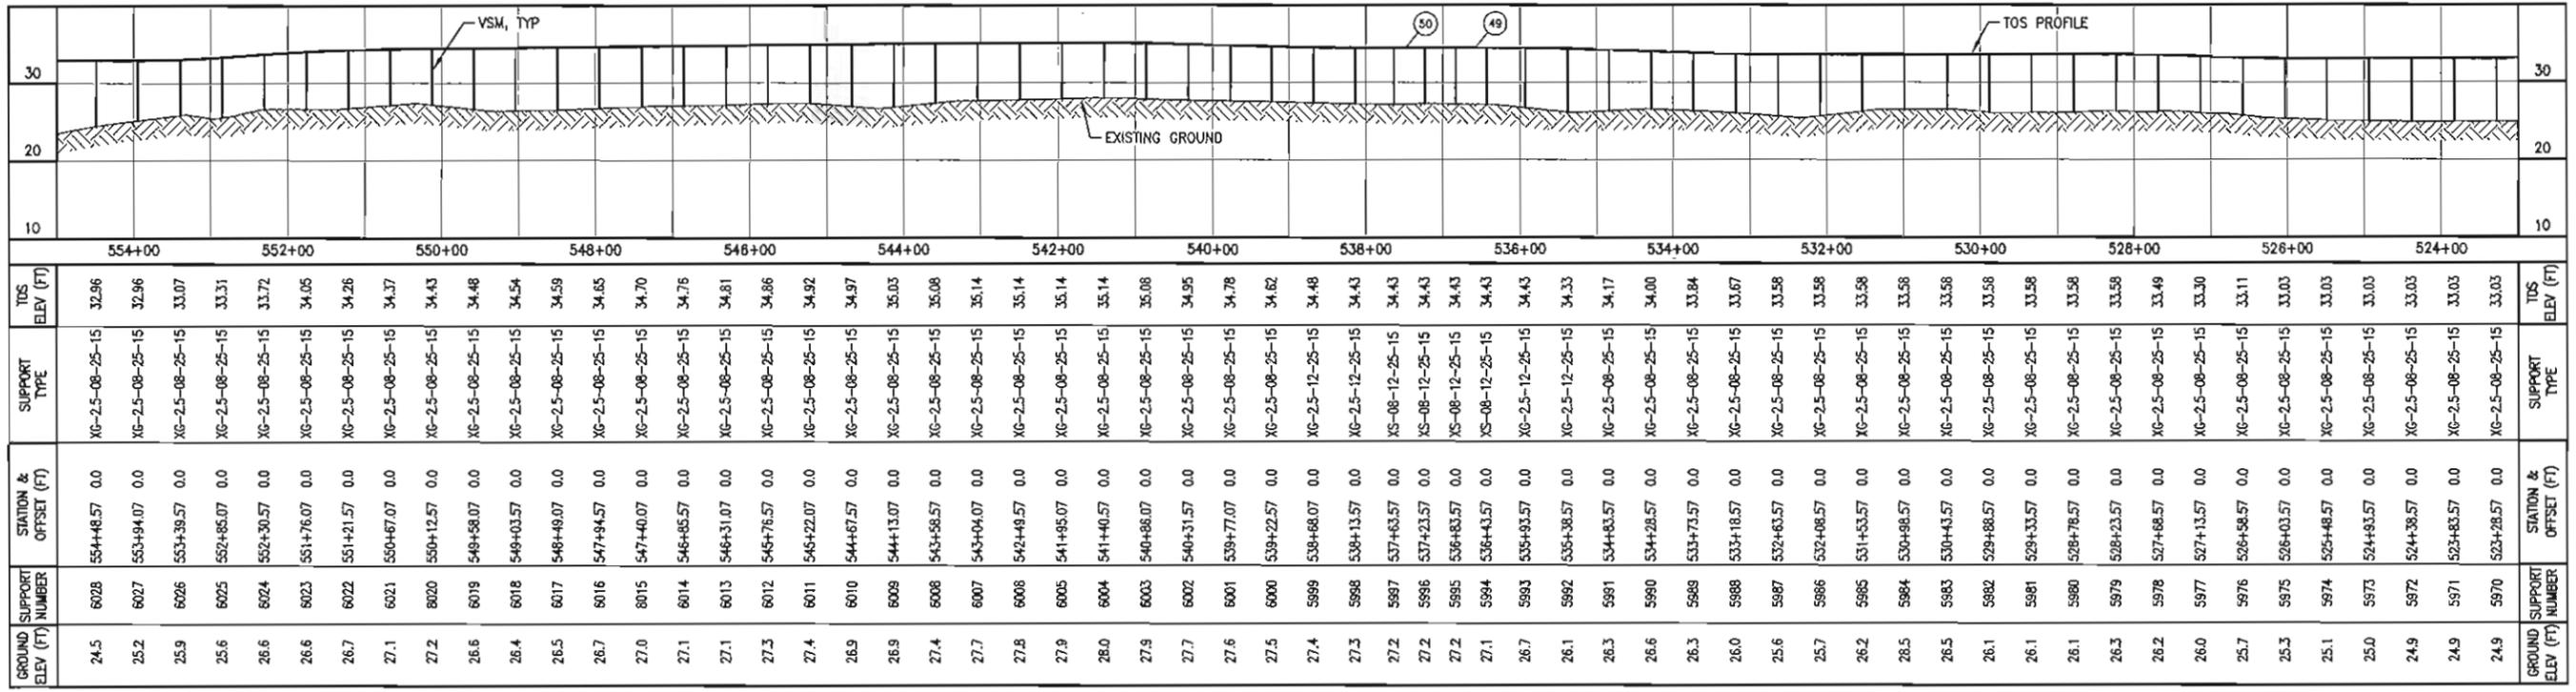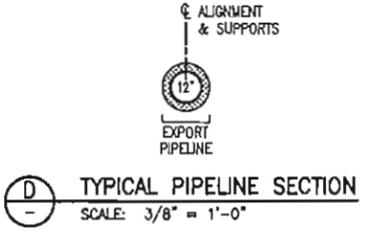

REFERENCE DRAWINGS	DESCRIPTION
USPT-WP-YDSTM-060001	PROJECT NOTES, ABBREVIATIONS AND LEGEND
USPT-WP-YDPAL-060001	SITE PLAN
USPT-WP-YDDET-060001	TYPICAL EXPANSION LOOP DETAIL
USPT-WP-YDDET-060010	GUIDED AND ANCHORED SUPPORT DETAILS
USPT-WP-YDDET-060011	SLIDING SUPPORT DETAILS
USPT-WP-YDWM-060001	WIND-INDUCED VIBRATION MITIGATION PLAN




REV	DATE	DESCRIPTION	BY	CHK	APPRO	PROJ
10	12/28/11	ISSUED FOR CONSTRUCTION	RH	JAG	PAC	CHP



EXPORT PIPELINE - PIPELINE ALIGNMENT SHEET PLAN & PROFILE STA 523+00 TO STA 555+00			
POINT THOMSON	DATE	SCALE	CHK
R. HOBBS	12/11	AS SHOWN	JAG
DRAWING NO.	SHEET	NO. OF SHEETS	REV
USPT-WP-YDPAL-060019-001	1 of 1	10	T

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FILENAME: USPT-WP-YDPAL-060019-001

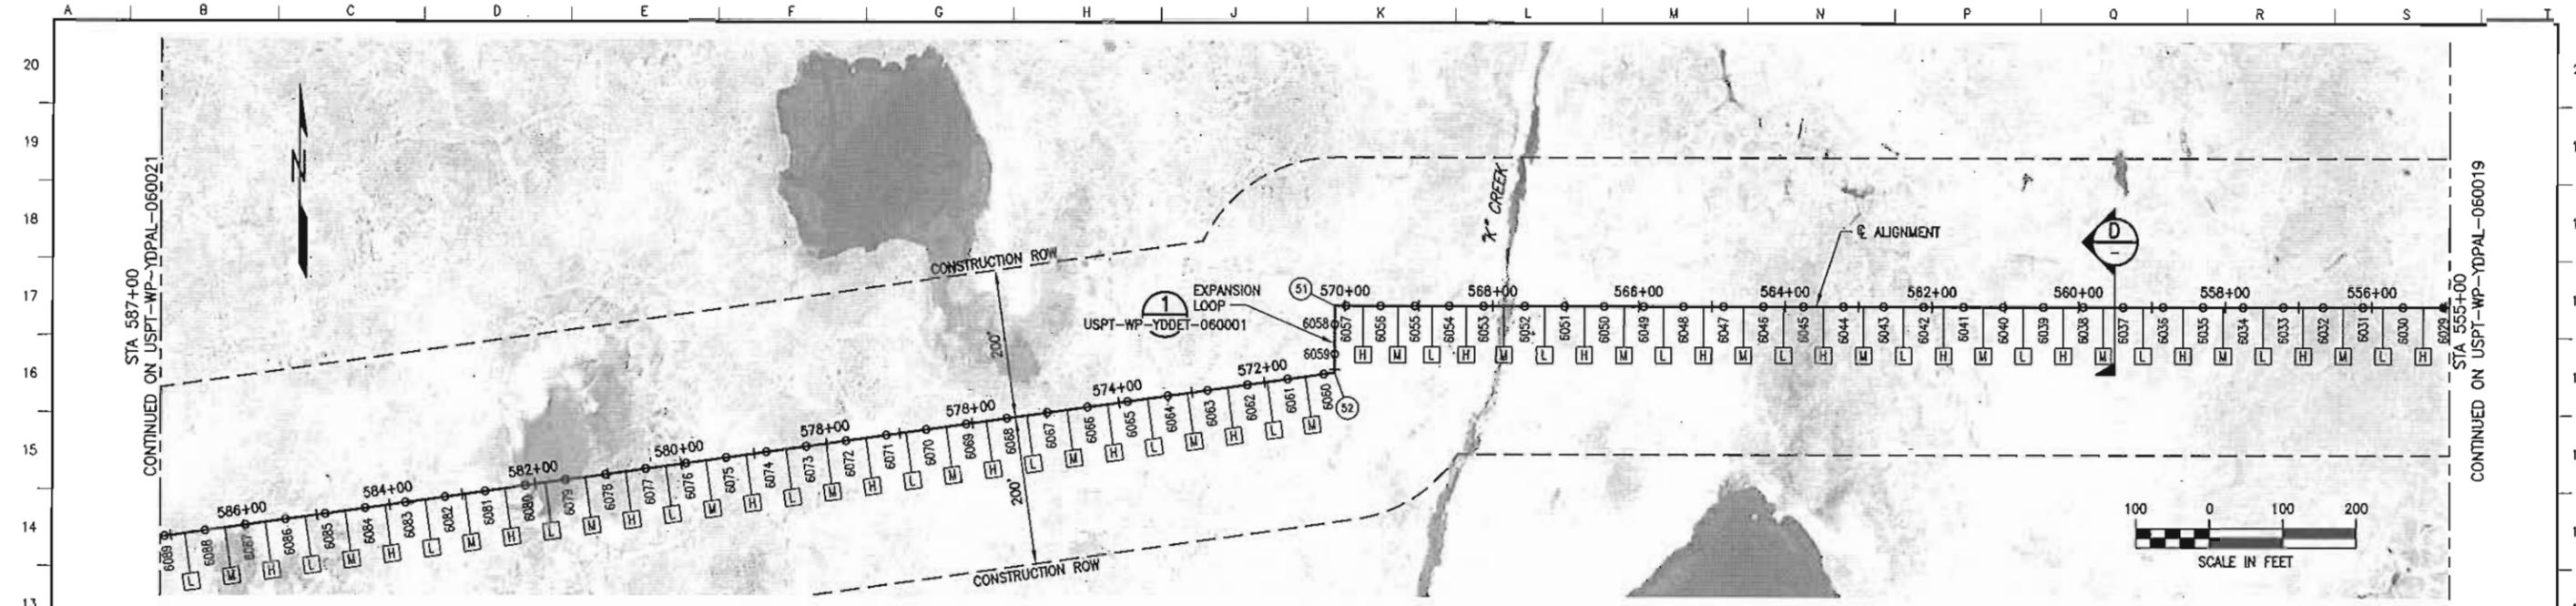

LOCATION	MATERIAL	WALL THK (IN)	FBE COATING (MIL)	INSULATION (IN)
555+00 TO 587+00	12.75" DIA API 5L X65	0.406	SHOP: 20 MIN, 32 MAX FIELD: 25 MIN, 39 MAX	3.0

POINT	DESCRIPTION	STATION	NORTHING	EASTING	ANGLE
51	PI	570+13.57	5907790.40	1554512.64	90.0'
52	PI	571+03.57	5907700.40	1554512.64	82.0'

PIPE SUPPORT IDENTIFICATION

VS-06-704-XXXX

VERTICAL SUPPORT
LOCATION CODE
UNIT/MODULE
SEQUENTIAL NUMBER
(SHOWN ON PLAN & PROFILE)

SUPPORT TYPE NOMENCLATURE



XX-XX-XX-XX-XX

EXPORT = "X"
GUIDE = "G"
SLIDE = "S"
ANCHOR = "A"

HSM LENGTH (FT)
NOMINAL VSM DIAMETER (IN)
VSM LENGTH (FT)
MINIMUM EMBEDMENT (FT)

- NOTES**
- CENTERLINE OF ALIGNMENT = CENTERLINE OF 12"-LN-644-0049-ME8EV-3TH.
 - STATIONING ALONG ALIGNMENT REFLECTS HORIZONTAL DISTANCE.
 - HORIZONTAL DATUM IS NAD83, ALASKA STATE PLANE, ZONE 3, US FOOT.
 - VERTICAL DATUM IS POINT THOMSON UNIT MEAN LOWER LOW WATER (PTU MLLW).
 - FOR GUIDED AND ANCHORED SUPPORT DETAILS, SEE USPT-WP-YDDET-060010.
 - FOR SLIDING SUPPORT DETAILS, SEE USPT-WP-YDDET-060011.
 - FOR WIND-INDUCED VIBRATION MITIGATION PLAN AND TUNED VIBRATION ABSORBER (TVA) INSTALLATION, SEE USPT-WP-YDHW-060001.

- LEGEND**
- GUIDED OR SLIDING SUPPORT
 - ANCHORED SUPPORT
 - ⊙ PI OR VPI LOCATION
 - H HIGH FREQUENCY TVA
 - L LOW FREQUENCY TVA
 - M MEDIUM FREQUENCY TVA

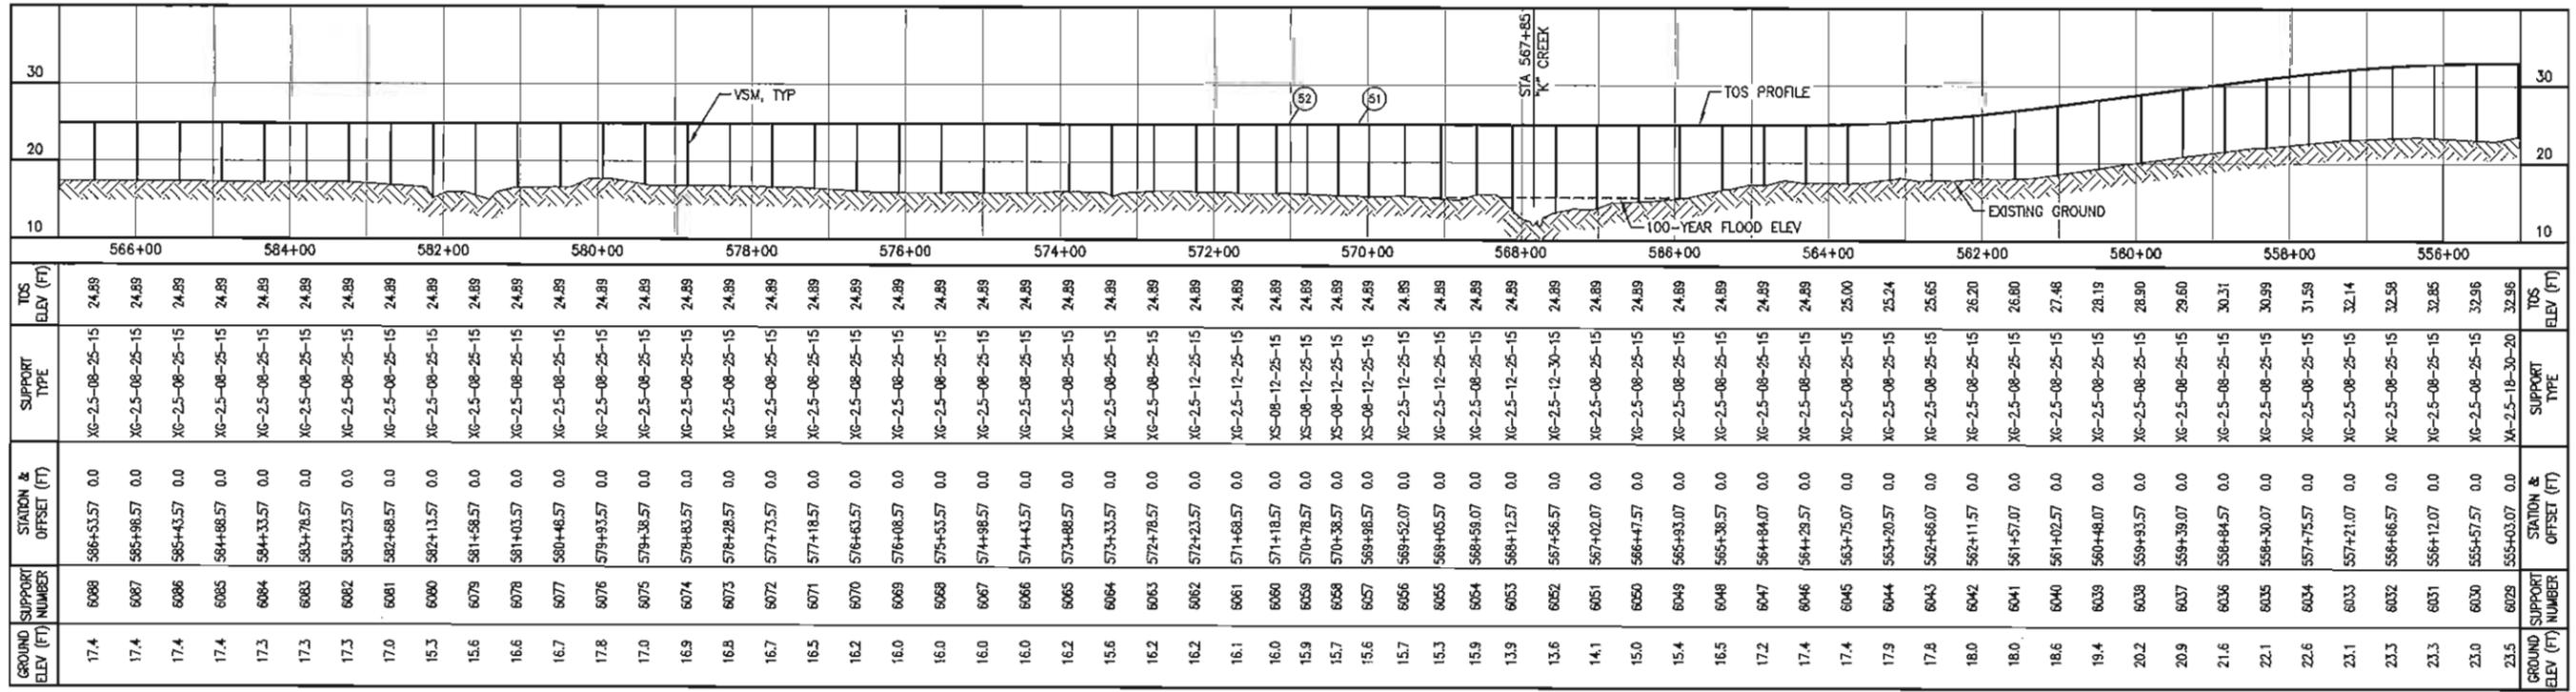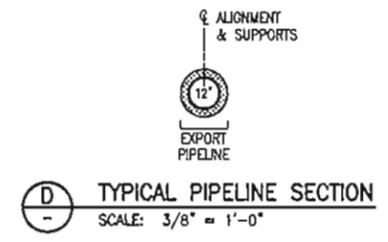

REFERENCE DRAWINGS	DESCRIPTION
USPT-WP-YDSM-060001	PROJECT NOTES, ABBREVIATIONS AND LEGEND
USPT-WP-YDPA-060001	SITE PLAN
USPT-WP-YDDET-060001	TYPICAL EXPANSION LOOP DETAIL
USPT-WP-YDDET-060010	GUIDED AND ANCHORED SUPPORT DETAILS
USPT-WP-YDDET-060011	SLIDING SUPPORT DETAILS
USPT-WP-YDHW-060001	WIND-INDUCED VIBRATION MITIGATION PLAN



REV	DATE	DESCRIPTION	BY	CHK	APPD	PROJ
10	12/28/11	ISSUED FOR CONSTRUCTION				

ExxonMobil
Development

WorleyParsons **FLUOR** Baker


POINT THOMSON				ALASKA			
MODULE	DRAWN	DATE	SCALE	CHK	APPD	SHEET	REV
	R. HOBBS	12/11	AS SHOWN			1 of 1	10

EXPORT PIPELINE - PIPELINE ALIGNMENT SHEET PLAN & PROFILE STA 555+00 TO STA 587+00

USPT-WP-YDPA-060020-001

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FILENAME: USPT-WP-YDPA-060020-001

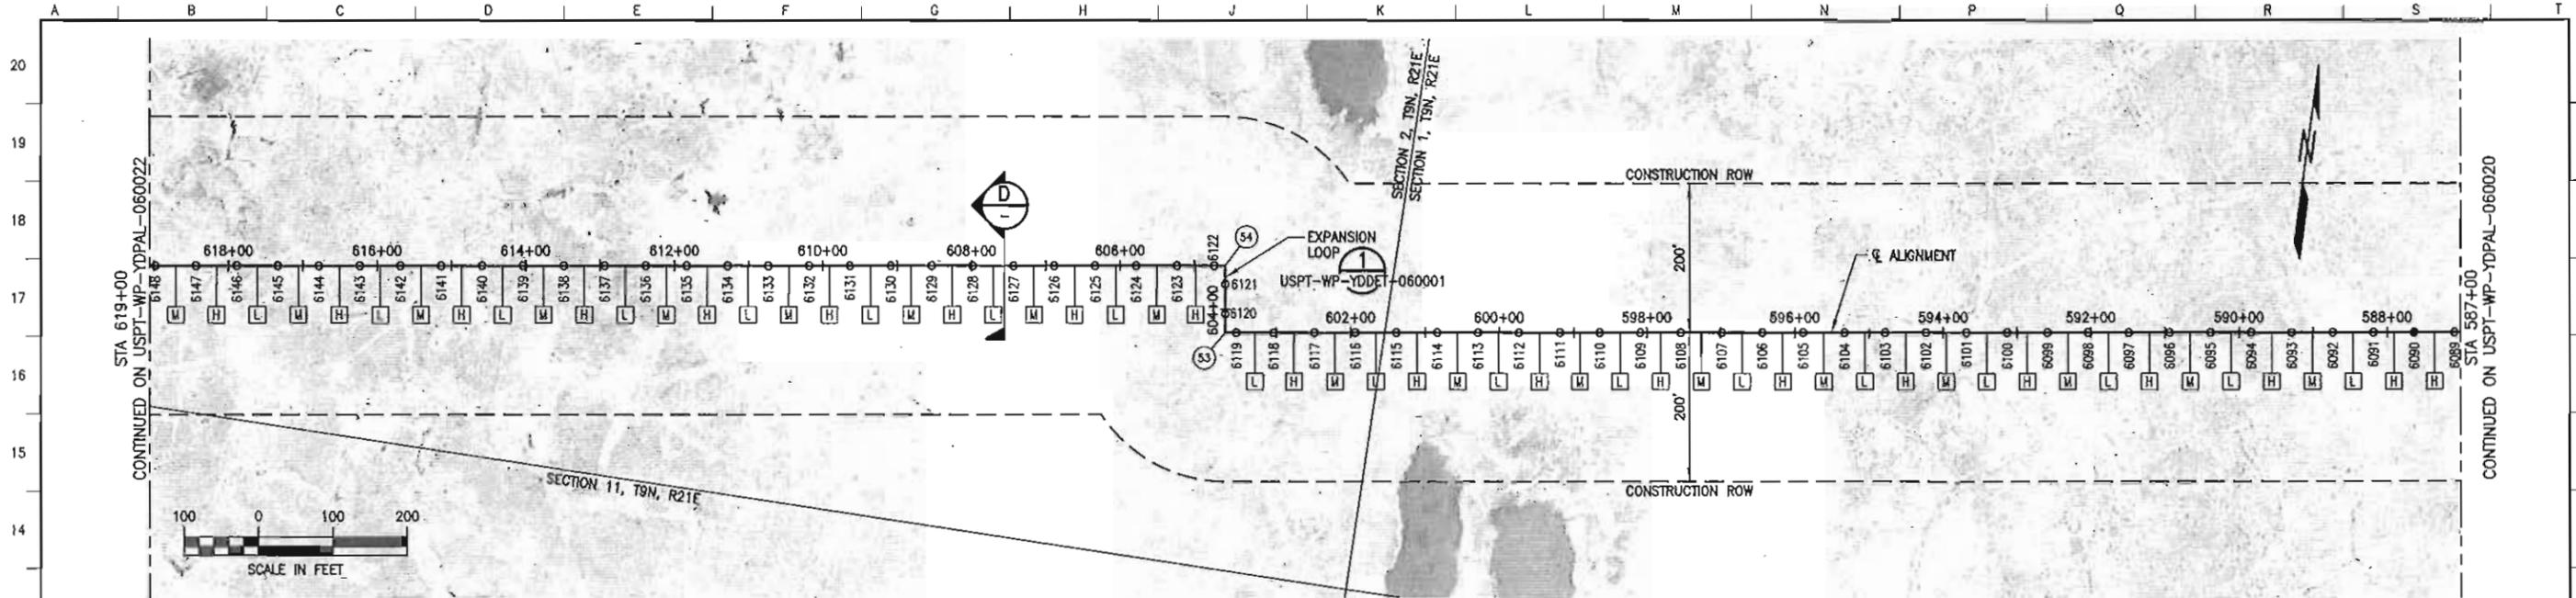

LOCATION	MATERIAL	WALL THK (IN)	FBE COATING (MIL)	INSULATION (IN)
587+00 TO 619+00	12.75" DIA API 5L X65	0.406	SHOP: 20 MIN, 32 MAX FIELD: 25 MIN, 39 MAX	3.0



POINT	DESCRIPTION	STATION	NORTHING	EASTING	ANGLE
53	PI	603+68.57	5907245.96	1551279.42	90.0'
54	PI	604+58.57	5907335.09	1551266.89	90.0'

PIPE SUPPORT IDENTIFICATION
 VERTICAL SUPPORT LOCATION CODE
 UNIT/MODULE
 SEQUENTIAL NUMBER (SHOWN ON PLAN & PROFILE)

SUPPORT TYPE NOMENCLATURE
 EXPORT = "X"
 GUIDE = "G"
 SLIDE = "S"
 ANCHOR = "A"
 HSM LENGTH (FT)
 NOMINAL VSM DIAMETER (IN)
 VSM LENGTH (FT)
 MINIMUM EMBEDMENT (FT)

- NOTES**
- CENTERLINE OF ALIGNMENT = CENTERLINE OF 12"-LN-644-0049-ME8EV-3"H.
 - STATIONING ALONG ALIGNMENT REFLECTS HORIZONTAL DISTANCE.
 - HORIZONTAL DATUM IS NAD83, ALASKA STATE PLANE ZONE 3, US FOOT.
 - VERTICAL DATUM IS POINT THOMSON UNIT MEAN LOWER LOW WATER (PTU MLLW).
 - FOR GUIDED AND ANCHORED SUPPORT DETAILS, SEE USPT-WP-YDDET-060010.
 - FOR SLIDING SUPPORT DETAILS, SEE USPT-WP-YDDET-060011.
 - FOR WIND-INDUCED VIBRATION MITIGATION PLAN AND TUNED VIBRATION ABSORBER (TVA) INSTALLATION, SEE USPT-WP-YDWHV-060001.

- LEGEND**
- GUIDED OR SLIDING SUPPORT
 - ANCHORED SUPPORT
 - ⊙ PI OR VPI LOCATION
 - HIGH FREQUENCY TVA
 - LOW FREQUENCY TVA
 - MEDIUM FREQUENCY TVA

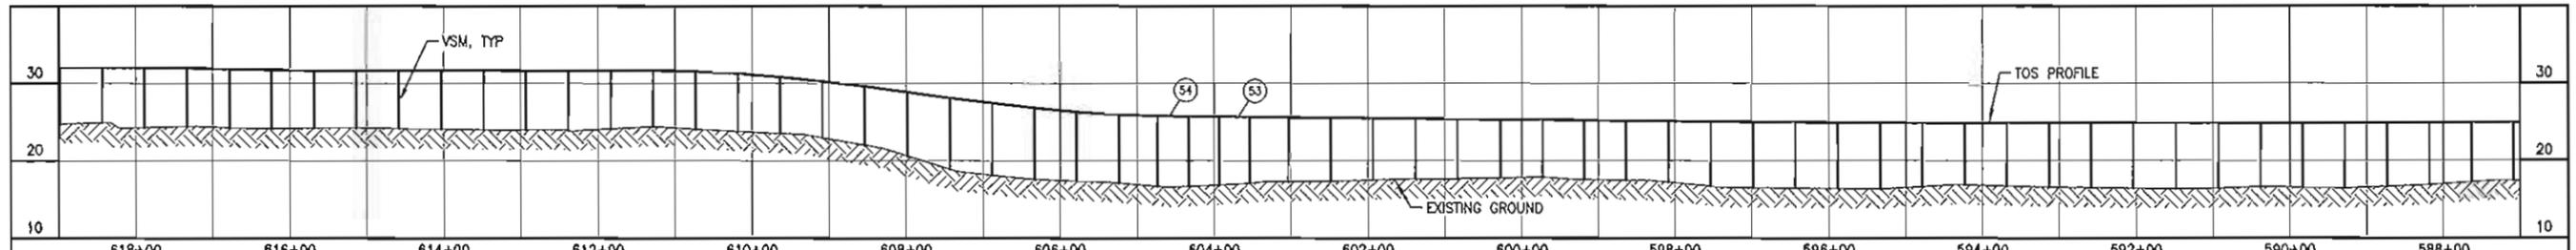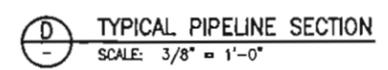

GROUND ELEV (FT)	SUPPORT NUMBER	STATION & OFFSET (FT)	SUPPORT TYPE	TOS ELEV (FT)
24.8	6148	618+68.57 0.0	XG-2.5-08-25-15	32.03
25.0	6147	618+43.57 0.0	XG-2.5-08-25-15	32.03
24.3	6146	617+88.57 0.0	XG-2.5-08-25-15	32.03
24.4	6145	617+33.57 0.0	XG-2.5-08-25-15	31.95
24.3	6144	616+78.57 0.0	XG-2.5-08-25-15	31.84
24.2	6143	616+23.57 0.0	XG-2.5-08-25-15	31.73
24.2	6142	615+68.57 0.0	XG-2.5-08-25-15	31.64
24.3	6141	615+13.57 0.0	XG-2.5-08-25-15	31.64
24.2	6140	614+58.57 0.0	XG-2.5-08-25-15	31.64
24.1	6139	614+3.57 0.0	XG-2.5-08-25-15	31.64
24.0	6138	613+48.57 0.0	XG-2.5-08-25-15	31.64
24.0	6137	612+93.57 0.0	XG-2.5-08-25-15	31.64
23.9	6136	612+38.57 0.0	XG-2.5-08-25-15	31.64
24.2	6135	611+83.57 0.0	XG-2.5-08-25-15	31.64
24.4	6134	611+28.57 0.0	XG-2.5-08-25-15	31.64
24.1	6133	610+73.57 0.0	XG-2.5-08-25-15	31.56
23.8	6132	610+18.57 0.0	XG-2.5-08-25-15	31.29
23.6	6131	609+63.57 0.0	XG-2.5-08-25-15	30.82
23.0	6130	609+8.57 0.0	XG-2.5-08-25-15	30.27
22.0	6129	608+53.57 0.0	XG-2.5-08-25-15	28.61
20.6	6128	607+98.57 0.0	XG-2.5-08-25-15	28.87
18.9	6127	607+43.57 0.0	XG-2.5-08-25-15	28.12
18.2	6126	606+88.57 0.0	XG-2.5-08-25-15	27.46
17.6	6125	606+33.57 0.0	XG-2.5-08-25-15	26.83
17.4	6124	606+78.57 0.0	XG-2.5-12-25-15	26.31
17.1	6123	605+23.57 0.0	XG-2.5-12-25-15	25.85
16.7	6122	604+73.57 0.0	XG-2.5-12-25-15	25.85
16.7	6121	604+33.57 0.0	XG-2.5-12-25-15	25.78
16.9	6120	603+83.57 0.0	XG-2.5-12-25-15	25.74
17.1	6119	603+43.57 0.0	XG-2.5-12-25-15	25.70
17.3	6118	603+3.57 0.0	XG-2.5-12-25-15	25.66
17.4	6117	602+48.57 0.0	XG-2.5-12-25-15	25.61
17.5	6116	601+93.57 0.0	XG-2.5-12-25-15	25.55
17.7	6115	601+38.57 0.0	XG-2.5-12-25-15	25.50
17.7	6114	600+83.57 0.0	XG-2.5-12-25-15	25.44
17.8	6113	600+28.57 0.0	XG-2.5-12-25-15	25.39
17.9	6112	599+73.57 0.0	XG-2.5-12-25-15	25.33
17.6	6111	599+18.57 0.0	XG-2.5-12-25-15	25.28
17.5	6110	598+63.57 0.0	XG-2.5-12-25-15	25.22
17.2	6109	598+8.57 0.0	XG-2.5-12-25-15	25.17
16.7	6108	597+53.57 0.0	XG-2.5-12-25-15	25.11
16.5	6107	596+98.57 0.0	XG-2.5-12-25-15	25.06
16.5	6106	596+43.57 0.0	XG-2.5-12-25-15	25.00
16.4	6105	595+88.57 0.0	XG-2.5-12-25-15	24.95
16.4	6104	595+33.57 0.0	XG-2.5-12-25-15	24.89
16.7	6103	594+78.57 0.0	XG-2.5-12-25-15	24.89
16.9	6102	594+23.57 0.0	XG-2.5-12-25-15	24.89
16.7	6101	593+68.57 0.0	XG-2.5-12-25-15	24.89
16.6	6100	593+13.57 0.0	XG-2.5-12-25-15	24.89
16.5	6099	592+58.57 0.0	XG-2.5-12-25-15	24.89
16.4	6098	592+3.57 0.0	XG-2.5-12-25-15	24.89
16.4	6097	591+48.57 0.0	XG-2.5-12-25-15	24.89
16.5	6096	590+93.57 0.0	XG-2.5-12-25-15	24.89
16.6	6095	590+38.57 0.0	XG-2.5-12-25-15	24.89
16.6	6094	589+83.57 0.0	XG-2.5-12-25-15	24.89
16.5	6093	589+28.57 0.0	XG-2.5-12-25-15	24.89
16.7	6092	588+73.57 0.0	XG-2.5-12-25-15	24.89
16.9	6091	588+18.57 0.0	XG-2.5-12-25-15	24.89
17.2	6090	587+63.57 0.0	XG-2.5-12-25-15	24.89
17.4	6089	587+8.57 0.0	XG-2.5-12-25-15	24.89

REFERENCE DRAWINGS	DESCRIPTION
USPT-WP-YDSYM-060001	PROJECT NOTES, ABBREVIATIONS AND LEGEND
USPT-WP-YDPAL-060001	SITE PLAN
USPT-WP-YDDET-060001	TYPICAL EXPANSION LOOP DETAIL
USPT-WP-YDDET-060010	GUIDED AND ANCHORED SUPPORT DETAILS
USPT-WP-YDDET-060011	SLIDING SUPPORT DETAILS
USPT-WP-YDWHV-060001	WIND-INDUCED VIBRATION MITIGATION PLAN



REV	DATE	DESCRIPTION	BY	CHK	APPRO	PROJ
10	12/28/11	ISSUED FOR CONSTRUCTION	RFL	JAG	PAC	GMP


ExxonMobil Development

WorleyParsons FLUOR. Baker

EXPORT PIPELINE - PIPELINE PIPELINE ALIGNMENT SHEET PLAN & PROFILE STA 587+00 TO STA 619+00			
POINT THOMSON	DATE	SCALE	ALASKA
MODULE	R. HOBBS	12/11	AS SHOWN
DRAWING NO.	USPT-WP-YDPAL-060021-001	CHECKED	DATE
		1 of 1	10

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FILENAME: USPT-WP-YDPAL-060021-001

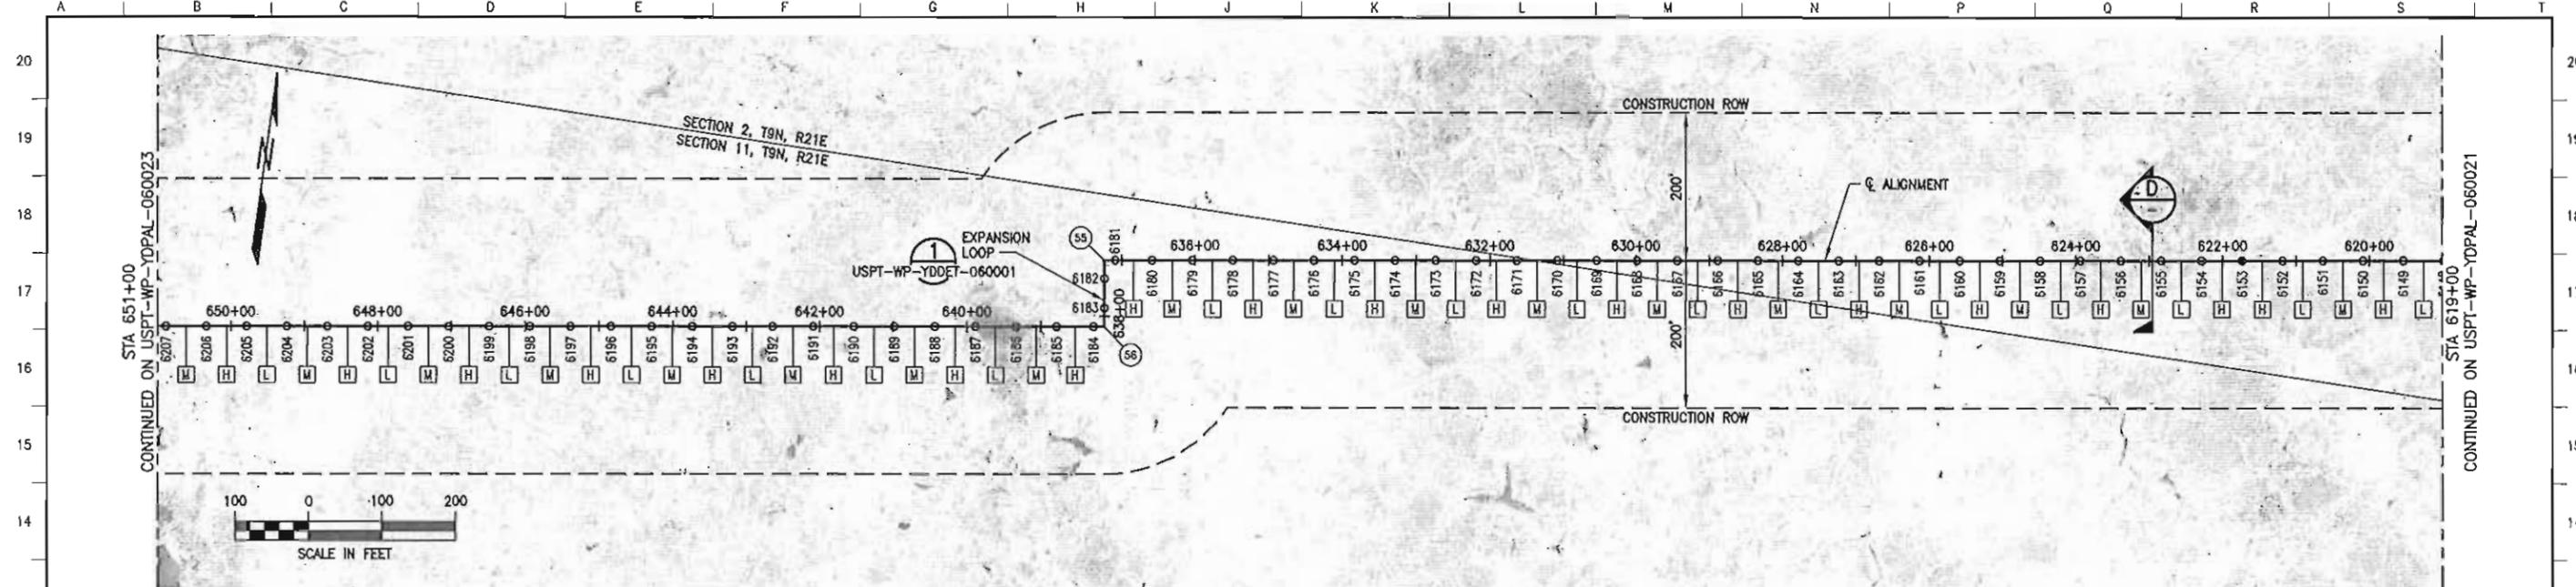

LOCATION	MATERIAL	WALL THK (IN)	FBE COATING (MIL)	INSULATION (IN)
619+00 TO 651+00	12.75" OIA API 5L X65	0.406	SHOP: 20 MIN, 32 MAX FIELD: 25 MIN, 39 MAX	3.0



POINT	DESCRIPTION	STATION	NORTHING	EASTING	ANGLE
55	PI	637+23.57	5906880.65	1548033.67	90.0°
56	PI	638+13.57	5906791.53	1548046.20	90.0°

PIPE SUPPORT IDENTIFICATION
 VS-06-704-XXXX
 VERTICAL SUPPORT
 LOCATION CODE
 UNIT/MODULE
 SEQUENTIAL NUMBER
 (SHOWN ON PLAN & PROFILE)

SUPPORT TYPE NOMENCLATURE
 XX-XX-XX-XX-XX
 EXPORT = "X"
 GUIDE = "G"
 SLIDE = "S"
 ANCHOR = "A"
 HSM LENGTH (FT)
 NOMINAL VSM DIAMETER (IN)
 VSM LENGTH (FT)
 MINIMUM EMBEDMENT (FT)

- NOTES**
- CENTERLINE OF ALIGNMENT = CENTERLINE OF 12"-LN-644-0049-ME8EV-3"H.
 - STATIONING ALONG ALIGNMENT REFLECTS HORIZONTAL DISTANCE.
 - HORIZONTAL DATUM IS NAD83, ALASKA STATE PLANE ZONE 3, US FOOT.
 - VERTICAL DATUM IS POINT THOMSON UNIT MEAN LOWER LOW WATER (PTU MLLW).
 - FOR GUIDED AND ANCHORED SUPPORT DETAILS, SEE USPT-WP-YDDET-060010.
 - FOR SLIDING SUPPORT DETAILS, SEE USPT-WP-YDDET-060011.
 - FOR WIND-INDUCED VIBRATION MITIGATION PLAN AND TUNED VIBRATION ABSORBER (TVA) INSTALLATION, SEE USPT-WP-YDHW-060001.

- LEGEND**
- GUIDED OR SLIDING SUPPORT
 - ANCHORED SUPPORT
 - ⊙ PI OR VPI LOCATION
 - H HIGH FREQUENCY TVA
 - L LOW FREQUENCY TVA
 - M MEDIUM FREQUENCY TVA

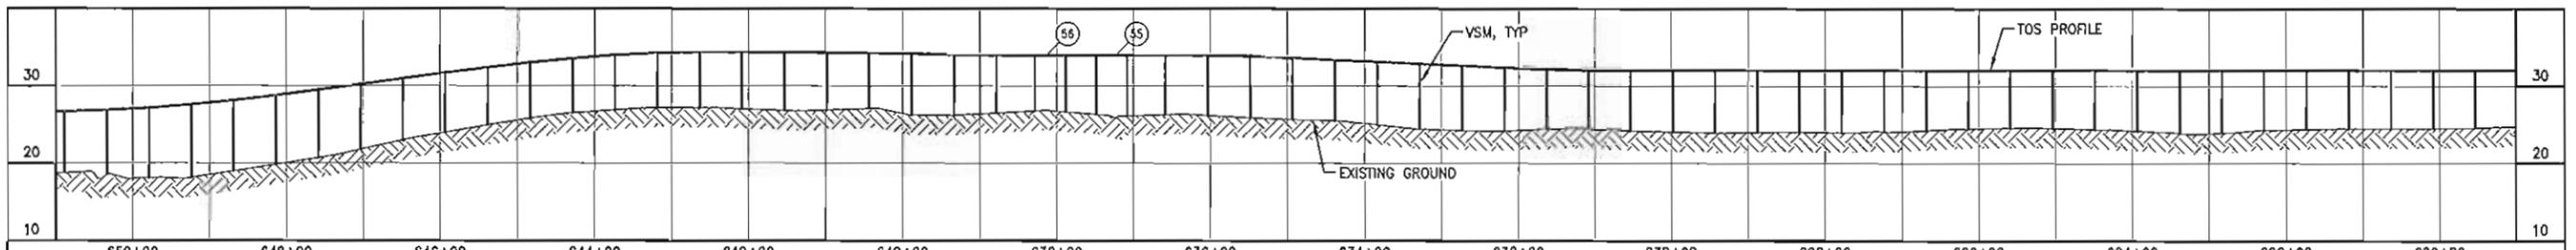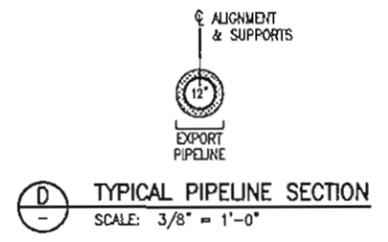


GROUND ELEV (FT)	SUPPORT NUMBER	STATION & OFFSET (FT)	SUPPORT TYPE	TDS ELEV (FT)
18.8	6207	650+88.57 0.0	XG-2.5-08-25-15	26.89
18.6	6206	650+33.57 0.0	XG-2.5-08-25-15	26.87
18.1	6205	649+78.57 0.0	XG-2.5-08-25-15	27.14
18.2	6204	649+23.57 0.0	XG-2.5-08-25-15	27.56
19.0	6203	648+68.57 0.0	XG-2.5-08-25-15	28.13
19.8	6202	648+13.57 0.0	XG-2.5-08-25-15	28.77
20.7	6201	647+58.57 0.0	XG-2.5-08-25-15	29.45
21.8	6200	647+03.57 0.0	XG-2.5-08-25-15	30.20
23.0	6199	646+48.57 0.0	XG-2.5-08-25-15	30.94
24.0	6198	646+93.57 0.0	XG-2.5-08-25-15	31.68
25.0	6197	646+38.57 0.0	XG-2.5-08-25-15	32.37
25.8	6196	644+83.57 0.0	XG-2.5-08-25-15	33.00
26.5	6195	644+28.57 0.0	XG-2.5-08-25-15	33.55
26.9	6194	643+73.57 0.0	XG-2.5-08-25-15	33.99
27.2	6193	643+18.57 0.0	XG-2.5-08-25-15	34.27
27.2	6192	642+63.57 0.0	XG-2.5-08-25-15	34.38
27.1	6191	642+08.57 0.0	XG-2.5-08-25-15	34.38
26.8	6190	641+53.57 0.0	XG-2.5-08-25-15	34.38
26.9	6189	640+98.57 0.0	XG-2.5-08-25-15	34.29
27.1	6188	640+43.57 0.0	XG-2.5-08-25-15	34.21
26.2	6187	639+88.57 0.0	XG-2.5-08-25-15	34.13
26.2	6186	639+33.57 0.0	XG-2.5-12-25-15	34.05
26.5	6185	638+78.57 0.0	XG-2.5-12-25-15	33.96
26.8	6184	638+23.57 0.0	XG-2.5-12-25-15	33.96
26.6	6183	637+68.57 0.0	XG-2.5-12-25-15	33.96
26.3	6182	637+13.57 0.0	XG-2.5-12-25-15	33.96
26.1	6181	637+08.57 0.0	XG-2.5-12-25-15	33.96
26.3	6180	636+53.57 0.0	XG-2.5-12-25-15	33.96
26.2	6179	636+03.57 0.0	XG-2.5-12-25-15	33.96
25.9	6178	635+48.57 0.0	XG-2.5-08-25-15	33.84
25.7	6177	634+93.57 0.0	XG-2.5-08-25-15	33.80
25.5	6176	634+38.57 0.0	XG-2.5-08-25-15	33.36
25.0	6175	633+83.57 0.0	XG-2.5-08-25-15	33.12
24.5	6174	633+28.57 0.0	XG-2.5-08-25-15	32.88
24.3	6173	632+73.57 0.0	XG-2.5-08-25-15	32.63
24.2	6172	632+18.57 0.0	XG-2.5-08-25-15	32.39
24.4	6171	631+63.57 0.0	XG-2.5-08-25-15	32.15
24.4	6170	631+08.57 0.0	XG-2.5-08-25-15	32.03
24.2	6169	630+53.57 0.0	XG-2.5-08-25-15	32.03
24.1	6168	629+98.57 0.0	XG-2.5-08-25-15	32.03
24.0	6167	629+43.57 0.0	XG-2.5-08-25-15	32.03
24.0	6166	628+88.57 0.0	XG-2.5-08-25-15	32.03
24.0	6165	628+33.57 0.0	XG-2.5-08-25-15	32.03
24.0	6164	627+78.57 0.0	XG-2.5-08-25-15	32.03
24.1	6163	627+23.57 0.0	XG-2.5-08-25-15	32.03
24.3	6162	626+68.57 0.0	XG-2.5-08-25-15	32.03
24.5	6161	626+13.57 0.0	XG-2.5-08-25-15	32.03
24.6	6160	625+58.57 0.0	XG-2.5-08-25-15	32.03
24.6	6159	625+03.57 0.0	XG-2.5-08-25-15	32.03
24.4	6158	624+48.57 0.0	XG-2.5-08-25-15	32.03
24.2	6157	623+93.57 0.0	XG-2.5-08-25-15	32.03
23.9	6156	623+38.57 0.0	XG-2.5-08-25-15	32.03
23.9	6155	622+83.57 0.0	XG-2.5-08-25-15	32.03
24.3	6154	622+28.57 0.0	XG-2.5-08-25-15	32.03
24.4	6153	621+73.57 0.0	XA-2.5-18-30-20	32.03
24.5	6152	621+18.57 0.0	XG-2.5-08-25-15	32.03
24.5	6151	620+63.57 0.0	XG-2.5-08-25-15	32.03
24.5	6150	620+08.57 0.0	XG-2.5-08-25-15	32.03
24.6	6149	619+53.57 0.0	XG-2.5-08-25-15	32.03

REFERENCE DRAWINGS	DESCRIPTION
USPT-WP-YDSM-060001	PROJECT NOTES, ABBREVIATIONS AND LEGEND
USPT-WP-YDPAL-060001	SITE PLAN
USPT-WP-YDDET-060001	TYPICAL EXPANSION LOOP DETAIL
USPT-WP-YDDET-060010	GUIDED AND ANCHORED SUPPORT DETAILS
USPT-WP-YDDET-060011	SLIDING SUPPORT DETAILS
USPT-WP-YDHW-060001	WIND-INDUCED VIBRATION MITIGATION PLAN




REV	DATE	DESCRIPTION	BY	CHK	APPD	PROJ
10	12/28/11	ISSUED FOR CONSTRUCTION	RPH	JMD	PAC	GMP

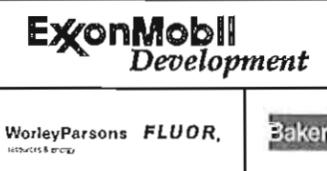

EXPORT PIPELINE - PIPELINE PIPELINE ALIGNMENT SHEET PLAN & PROFILE STA 619+00 TO STA 651+00			
POINT THOMSON	DATE	SCALE	ALASKA
MODULE	12/11	AS SHOWN	CHK JMD
DRAWN	R. HOBBS		APPD PAC
DRAWING NO.	USPT-WP-YDPAL-060022-001	SHEET	REV
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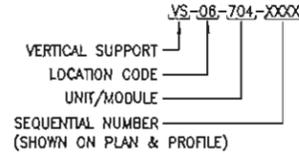
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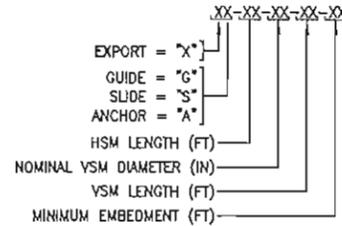
LOCATION	MATERIAL	WALL THK (IN)	FBE COATING (MIL)	INSULATION (IN)
651+00 TO 683+00	12.75" DIA API 5L X65	0.406	SHOP: 20 MIN, 32 MAX FIELD: 25 MIN, 39 MAX	3.0

POINT	DESCRIPTION	STATION	NORTHING	EASTING	ANGLE
57	PI	670+78.57	5906337.10	1544812.98	90.0'
58	PI	671+68.57	5906426.22	1544800.45	90.0'

PIPE SUPPORT IDENTIFICATION

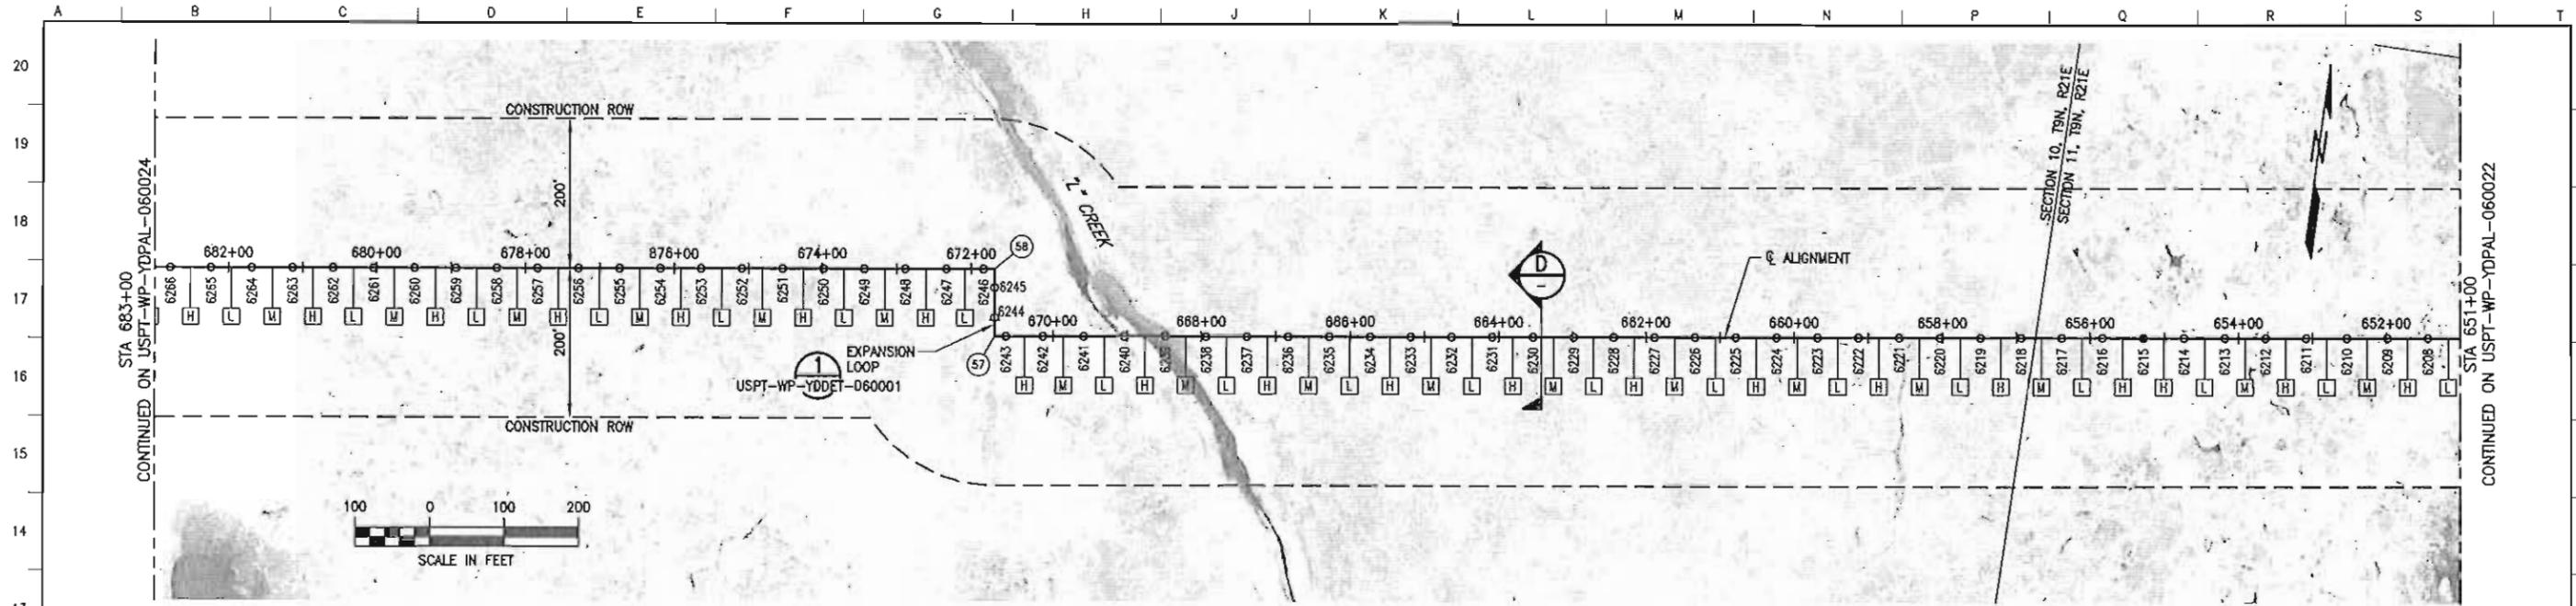

SUPPORT TYPE NOMENCLATURE





NOTES

- CENTERLINE OF ALIGNMENT = CENTERLINE OF 12"-LN-844-0049-ME8EV-3TH.
- STATIONING ALONG ALIGNMENT REFLECTS HORIZONTAL DISTANCE.
- HORIZONTAL DATUM IS NAD83, ALASKA STATE PLANE ZONE 3, US FOOT.
- VERTICAL DATUM IS POINT THOMSON UNIT MEAN LOWER LOW WATER (PTU MLLW).
- FOR GUIDED AND ANCHORED SUPPORT DETAILS, SEE USPT-WP-YDDET-060010.
- FOR SLIDING SUPPORT DETAILS, SEE USPT-WP-YDDET-060011.
- FOR WIND-INDUCED VIBRATION MITIGATION PLAN AND TUNED VIBRATION ABSORBER (TVA) INSTALLATION, SEE USPT-WP-YDHW-060001.

LEGEND

- GUIDED OR SLIDING SUPPORT
- ANCHORED SUPPORT
- ⊙ PI OR VPI LOCATION
- HIGH FREQUENCY TVA
- LOW FREQUENCY TVA
- MEDIUM FREQUENCY TVA

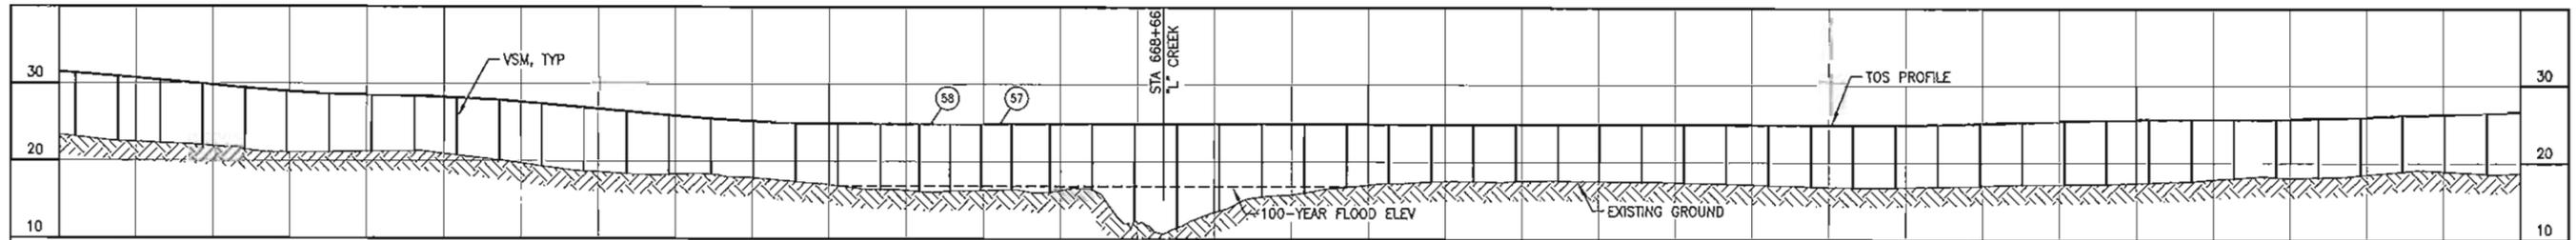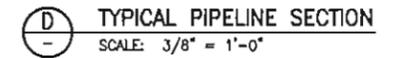

GROUND ELEV (FT)	SUPPORT NUMBER	STATION & OFFSET (FT)	SUPPORT TYPE	TOS ELEV (FT)	TOS ELEV (FT)
23.1	6266	682+78.57 0.0	XG-2.5-08-25-15	31.35	31.35
22.6	6265	682+23.57 0.0	XG-2.5-08-25-15	30.91	30.91
22.3	6264	681+68.57 0.0	XG-2.5-08-25-15	30.41	30.41
22.0	6263	681+13.57 0.0	XG-2.5-08-25-15	29.92	29.92
21.5	6262	680+58.57 0.0	XG-2.5-08-25-15	29.42	29.42
21.1	6261	680+03.57 0.0	XG-2.5-08-25-15	28.98	28.98
21.2	6260	679+48.57 0.0	XG-2.5-08-25-15	28.68	28.68
21.2	6259	678+93.57 0.0	XG-2.5-08-25-15	28.54	28.54
21.3	6258	678+38.57 0.0	XG-2.5-08-25-15	28.41	28.41
20.8	6257	677+83.57 0.0	XG-2.5-08-25-15	28.19	28.19
20.1	6256	677+28.57 0.0	XG-2.5-08-25-15	27.88	27.88
19.4	6255	676+73.57 0.0	XG-2.5-08-25-15	27.44	27.44
18.7	6254	676+18.57 0.0	XG-2.5-08-25-15	26.95	26.95
18.4	6253	675+63.57 0.0	XG-2.5-08-25-15	26.45	26.45
18.3	6252	675+08.57 0.0	XG-2.5-08-25-15	25.96	25.96
18.4	6251	674+53.57 0.0	XG-2.5-08-25-15	25.52	25.52
17.9	6250	673+98.57 0.0	XG-2.5-08-25-15	25.16	25.16
17.4	6249	673+43.57 0.0	XG-2.5-08-25-15	24.94	24.94
16.9	6248	672+88.57 0.0	XG-2.5-12-25-15	24.86	24.86
16.4	6247	672+33.57 0.0	XG-2.5-12-25-15	24.86	24.86
16.1	6246	671+83.57 0.0	XG-08-12-25-15	24.86	24.86
16.2	6245	671+43.57 0.0	XG-08-12-25-15	24.86	24.86
16.3	6244	671+03.57 0.0	XG-08-12-25-15	24.86	24.86
16.4	6243	670+63.57 0.0	XG-08-12-25-15	24.86	24.86
16.1	6242	670+13.57 0.0	XG-2.5-12-25-15	24.86	24.86
16.4	6241	669+58.57 0.0	XG-2.5-12-25-15	24.86	24.86
12.4	6240	669+03.57 0.0	XG-2.5-18-35-23	24.86	24.86
11.5	6239	668+48.57 0.0	XG-2.5-18-30-15	24.86	24.86
13.7	6238	667+93.57 0.0	XG-2.5-12-30-15	24.86	24.86
15.5	6237	667+38.57 0.0	XG-2.5-08-25-15	24.86	24.86
16.0	6236	666+83.57 0.0	XG-2.5-08-25-15	24.86	24.86
16.8	6235	666+28.57 0.0	XG-2.5-08-25-15	24.86	24.86
17.2	6234	665+73.57 0.0	XG-2.5-08-25-15	24.86	24.86
17.5	6233	665+18.57 0.0	XG-2.5-08-25-15	24.86	24.86
17.5	6232	664+63.57 0.0	XG-2.5-08-25-15	24.86	24.86
17.6	6231	664+8.57 0.0	XG-2.5-08-25-15	24.86	24.86
17.6	6230	663+53.57 0.0	XG-2.5-08-25-15	24.86	24.86
17.5	6229	662+98.57 0.0	XG-2.5-08-25-15	24.86	24.86
17.5	6228	662+43.57 0.0	XG-2.5-08-25-15	24.86	24.86
17.4	6227	661+88.57 0.0	XG-2.5-08-25-15	24.86	24.86
17.3	6226	661+33.57 0.0	XG-2.5-08-25-15	24.86	24.86
17.1	6225	660+78.57 0.0	XG-2.5-08-25-15	24.86	24.86
16.9	6224	660+23.57 0.0	XG-2.5-08-25-15	24.86	24.86
16.8	6223	659+68.57 0.0	XG-2.5-08-25-15	24.86	24.86
16.8	6222	659+13.57 0.0	XG-2.5-08-25-15	24.86	24.86
16.9	6221	658+58.57 0.0	XG-2.5-08-25-15	24.94	24.94
17.1	6220	658+03.57 0.0	XG-2.5-08-25-15	25.11	25.11
17.2	6219	657+48.57 0.0	XG-2.5-08-25-15	25.27	25.27
17.3	6218	656+93.57 0.0	XG-2.5-08-25-15	25.44	25.44
17.3	6217	656+38.57 0.0	XG-2.5-08-25-15	25.60	25.60
17.5	6216	655+83.57 0.0	XG-2.5-08-25-15	25.68	25.68
17.7	6215	655+28.57 0.0	XG-2.5-08-25-15	25.68	25.68
18.1	6214	654+73.57 0.0	XA-2.5-08-25-15	25.68	25.68
18.2	6213	654+18.57 0.0	XG-2.5-08-25-15	25.78	25.78
18.5	6212	653+63.57 0.0	XG-2.5-08-25-15	25.96	25.96
18.9	6211	653+08.57 0.0	XG-2.5-08-25-15	26.14	26.14
18.9	6210	652+53.57 0.0	XG-2.5-08-25-15	26.32	26.32
18.9	6209	651+98.57 0.0	XG-2.5-08-25-15	26.51	26.51
18.6	6208	651+43.57 0.0	XG-2.5-08-25-15	26.51	26.51

REFERENCE DRAWINGS	DESCRIPTION
USPT-WP-YDSYM-060001	PROJECT NOTES, ABBREVIATIONS AND LEGEND
USPT-WP-YDPAL-060001	SITE PLAN
USPT-WP-YDDET-060001	TYPICAL EXPANSION LOOP DETAIL
USPT-WP-YDDET-080010	GUIDED AND ANCHORED SUPPORT DETAILS
USPT-WP-YDDET-060011	SLIDING SUPPORT DETAILS
USPT-WP-YDHW-060001	WIND-INDUCED VIBRATION MITIGATION PLAN



REV	DATE	DESCRIPTION	BY	CHK	APPO	PROJ
10	12/28/11	ISSUED FOR CONSTRUCTION	RH	WG	PAC	GMP


ExxonMobil
Development

WorleyParsons **FLUOR**, Baker

EXPORT PIPELINE - PIPELINE PIPELINE ALIGNMENT SHEET PLAN & PROFILE STA 651+00 TO STA 683+00			
POINT THOMSON	MODULE	DRAWN	DATE
		R. HOBBS	12/11
SCALE	AS SHOWN	CHK	APPO
DRAWING NO.	USPT-WP-YDPAL-060023-001	SHEET	REV
		1 of 1	T

T:\122263 - Point Thomson EPC03 - CADD001 - Export\USPT-WP-YDPAL-060023-001 - 060023.dwg, 23, 12/21/2011 11:46:55 AM, J.Auburn

FILENAME: USPT-WP-YDPAL-060023-001

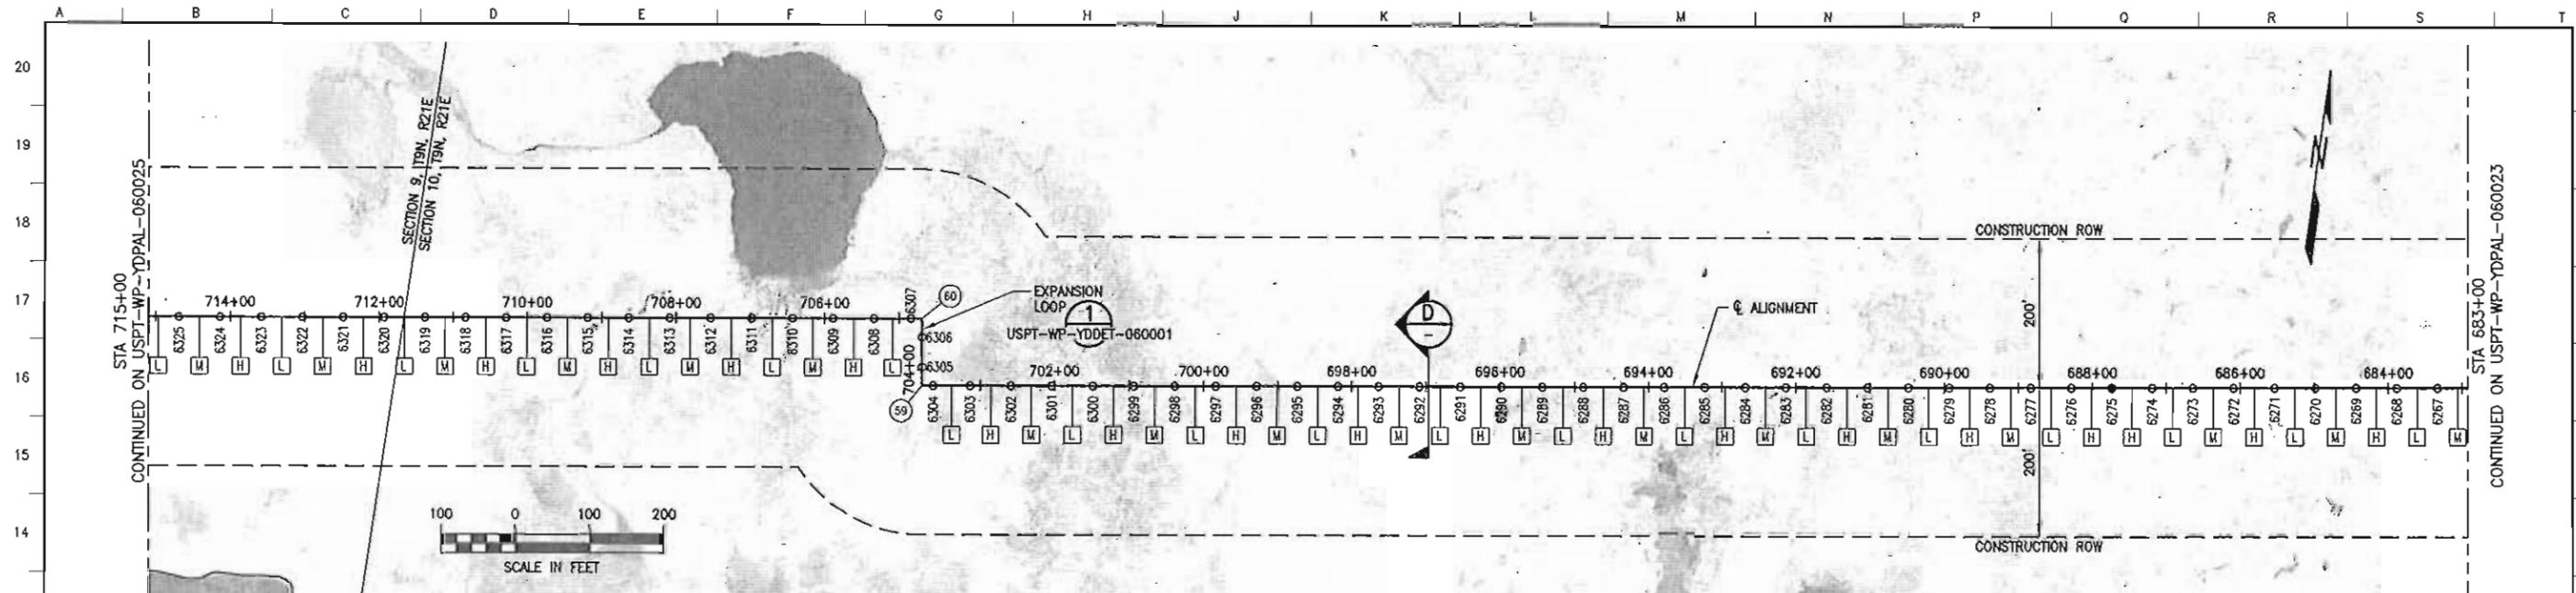



LOCATION	MATERIAL	WALL THK (IN)	FBE COATING (MIL)	INSULATION (IN)
683+00 TO 715+00	12.75" DIA API 5L X65	0.406	SHOP: 20 MIN, 32 MAX FIELD: 25 MIN, 39 MAX	3.0

POINT #	DESCRIPTION	STATION	NORTHING	EASTING	ANGLE
59	PI	703+78.57	5905979.44	1541621.70	90.0°
60	PI	704+68.57	5906068.56	1541609.17	90.0°

PIPE SUPPORT IDENTIFICATION
 YS-06-704-XXXX
 VERTICAL SUPPORT
 LOCATION CODE
 UNIT/MODULE
 SEQUENTIAL NUMBER (SHOWN ON PLAN & PROFILE)

SUPPORT TYPE NOMENCLATURE
 XX-XX-XX-XX-XX
 EXPORT = "X"
 GUIDE = "G"
 SLIDE = "S"
 ANCHOR = "A"
 HSM LENGTH (FT)
 NOMINAL VSM DIAMETER (IN)
 VSM LENGTH (FT)
 MINIMUM EMBEDMENT (FT)

- NOTES**
- CENTERLINE OF ALIGNMENT = CENTERLINE OF 12"-LN-644-0049-ME8EV-3"H.
 - STATIONING ALONG ALIGNMENT REFLECTS HORIZONTAL DISTANCE.
 - HORIZONTAL DATUM IS NAD83, ALASKA STATE PLANE ZONE 3, US FOOT.
 - VERTICAL DATUM IS POINT THOMSON UNIT MEAN LOWER LOW WATER (PTU MLLW).
 - FOR GUIDED AND ANCHORED SUPPORT DETAILS, SEE USPT-WP-YDDET-060010.
 - FOR SLIDING SUPPORT DETAILS, SEE USPT-WP-YDDET-060011.
 - FOR WIND-INDUCED VIBRATION MITIGATION PLAN AND TUNED VIBRATION ABSORBER (TVA) INSTALLATION, SEE USPT-WP-YDWN-060001.
- LEGEND**
- GUIDED OR SLIDING SUPPORT
 - ANCHORED SUPPORT
 - ⊙ PI OR VPI LOCATION
 - [H] HIGH FREQUENCY TVA
 - [L] LOW FREQUENCY TVA
 - [M] MEDIUM FREQUENCY TVA

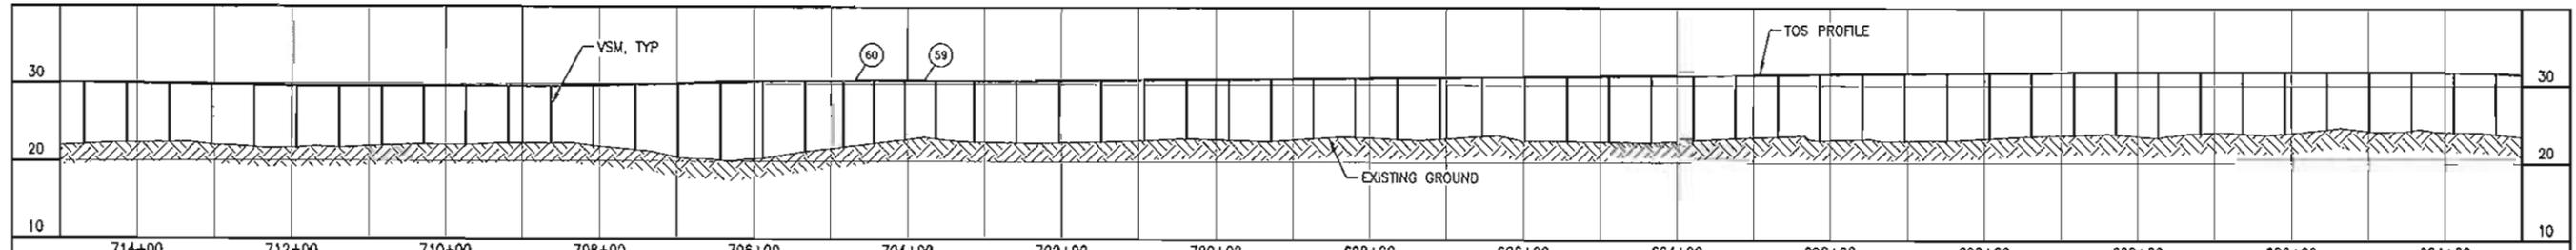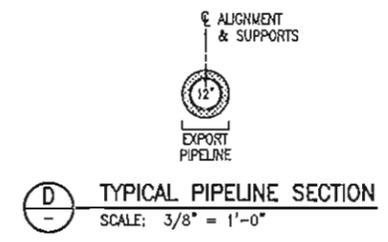

GROUND ELEV (FT)	SUPPORT NUMBER	STATION & OFFSET (FT)	SUPPORT TYPE	TOS ELEV (FT)	TOS ELEV (FT)
22.2	6325	714+68.57 0.0	XG-2.5-08-25-15	30.11	30.11
22.4	6324	714+13.57 0.0	XG-2.5-08-25-15	30.03	30.03
22.4	6323	713+58.57 0.0	XG-2.5-08-25-15	29.95	29.95
22.1	6322	713+03.57 0.0	XG-2.5-08-25-15	29.86	29.86
21.8	6321	712+48.57 0.0	XG-2.5-08-25-15	29.78	29.78
21.8	6320	711+93.57 0.0	XG-2.5-08-25-15	29.70	29.70
21.8	6319	711+38.57 0.0	XG-2.5-08-25-15	29.70	29.70
22.0	6318	710+83.57 0.0	XG-2.5-08-25-15	29.70	29.70
22.2	6317	710+28.57 0.0	XG-2.5-08-25-15	29.70	29.70
22.1	6316	709+73.57 0.0	XG-2.5-08-25-15	29.70	29.70
22.3	6315	709+18.57 0.0	XG-2.5-08-25-15	29.70	29.70
22.3	6314	708+63.57 0.0	XG-2.5-08-25-15	29.70	29.70
22.0	6313	708+8.57 0.0	XG-2.5-08-25-15	29.78	29.78
21.5	6312	707+53.57 0.0	XG-2.5-08-25-15	29.92	29.92
20.5	6311	706+98.57 0.0	XG-2.5-08-25-15	30.06	30.06
20.1	6310	706+43.57 0.0	XG-2.5-12-25-15	30.19	30.19
20.4	6309	705+88.57 0.0	XG-2.5-12-25-15	30.33	30.33
21.3	6308	705+33.57 0.0	XG-2.5-12-25-15	30.41	30.41
21.8	6307	704+83.57 0.0	XS-08-12-25-15	30.41	30.41
22.4	6306	704+43.57 0.0	XS-08-12-25-15	30.41	30.41
22.8	6305	704+03.57 0.0	XS-08-12-25-15	30.41	30.41
23.0	6304	703+63.57 0.0	XS-08-12-25-15	30.41	30.41
22.5	6303	703+13.57 0.0	XG-2.5-12-25-15	30.41	30.41
22.5	6302	702+68.57 0.0	XG-2.5-12-25-15	30.41	30.41
22.5	6301	702+28.57 0.0	XG-2.5-08-25-15	30.47	30.47
22.6	6300	701+83.57 0.0	XG-2.5-08-25-15	30.52	30.52
22.8	6299	700+33.57 0.0	XG-2.5-08-25-15	30.58	30.58
23.0	6298	700+38.57 0.0	XG-2.5-08-25-15	30.63	30.63
22.9	6297	699+83.57 0.0	XG-2.5-08-25-15	30.69	30.69
22.7	6296	699+28.57 0.0	XG-2.5-08-25-15	30.74	30.74
23.1	6295	698+73.57 0.0	XG-2.5-08-25-15	30.80	30.80
23.3	6294	698+18.57 0.0	XG-2.5-08-25-15	30.85	30.85
23.0	6293	697+63.57 0.0	XG-2.5-08-25-15	30.91	30.91
23.0	6292	697+8.57 0.0	XG-2.5-08-25-15	30.96	30.96
23.4	6291	696+53.57 0.0	XG-2.5-08-25-15	31.02	31.02
22.8	6290	695+98.57 0.0	XG-2.5-08-25-15	31.07	31.07
22.8	6289	695+43.57 0.0	XG-2.5-08-25-15	31.13	31.13
22.7	6288	694+88.57 0.0	XG-2.5-08-25-15	31.18	31.18
22.6	6287	694+33.57 0.0	XG-2.5-08-25-15	31.24	31.24
22.9	6286	693+78.57 0.0	XG-2.5-08-25-15	31.29	31.29
23.2	6285	693+23.57 0.0	XG-2.5-08-25-15	31.35	31.35
23.4	6284	692+68.57 0.0	XG-2.5-08-25-15	31.40	31.40
22.9	6283	692+13.57 0.0	XG-2.5-08-25-15	31.46	31.46
23.1	6282	691+58.57 0.0	XG-2.5-08-25-15	31.51	31.51
22.9	6281	691+03.57 0.0	XG-2.5-08-25-15	31.57	31.57
23.0	6280	690+48.57 0.0	XG-2.5-08-25-15	31.62	31.62
23.2	6279	689+93.57 0.0	XG-2.5-08-25-15	31.68	31.68
23.5	6278	689+38.57 0.0	XG-2.5-08-25-15	31.73	31.73
23.7	6277	688+83.57 0.0	XG-2.5-08-25-15	31.79	31.79
23.8	6276	688+28.57 0.0	XG-2.5-08-25-15	31.84	31.84
23.4	6275	687+73.57 0.0	XA-2.5-18-30-20	31.84	31.84
23.9	6274	687+18.57 0.0	XG-2.5-08-25-15	31.84	31.84
23.9	6273	686+63.57 0.0	XG-2.5-08-25-15	31.84	31.84
23.9	6272	686+8.57 0.0	XG-2.5-08-25-15	31.84	31.84
24.4	6271	685+53.57 0.0	XG-2.5-08-25-15	31.84	31.84
24.2	6270	684+98.57 0.0	XG-2.5-08-25-15	31.84	31.84
24.3	6269	684+43.57 0.0	XG-2.5-08-25-15	31.84	31.84
24.0	6268	683+88.57 0.0	XG-2.5-08-25-15	31.79	31.79
23.8	6267	683+33.57 0.0	XG-2.5-08-25-15	31.65	31.65

REFERENCE DRAWINGS	DESCRIPTION
USPT-WP-YDYM-060001	PROJECT NOTES, ABBREVIATIONS AND LEGEND
USPT-WP-YDPAL-060001	SITE PLAN
USPT-WP-YDDET-060001	TYPICAL EXPANSION LOOP DETAIL
USPT-WP-YDDET-060010	GUIDED AND ANCHORED SUPPORT DETAILS
USPT-WP-YDDET-060011	SLIDING SUPPORT DETAILS
USPT-WP-YDWN-060001	WIND-INDUCED VIBRATION MITIGATION PLAN



REV	DATE	DESCRIPTION	BY	CHK	APPRO	PROJ
10	12/28/11	ISSUED FOR CONSTRUCTION	RF	JAG	PAC	GWP


ExxonMobil Development

WorleyParsons FLUOR, Baker

EXPORT PIPELINE - PIPELINE PIPELINE ALIGNMENT SHEET PLAN & PROFILE STA 683+00 TO STA 715+00			
POINT THOMSON	SCALE	DATE	AS SHOWN
USPT-WP-YDDET-060010	R. HOBBS	12/11	
DRAWING NO.	USPT-WP-YDPAL-060024-001	SHEET	1 of 1

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FILENAME: USPT-WP-YDPAL-060024-001

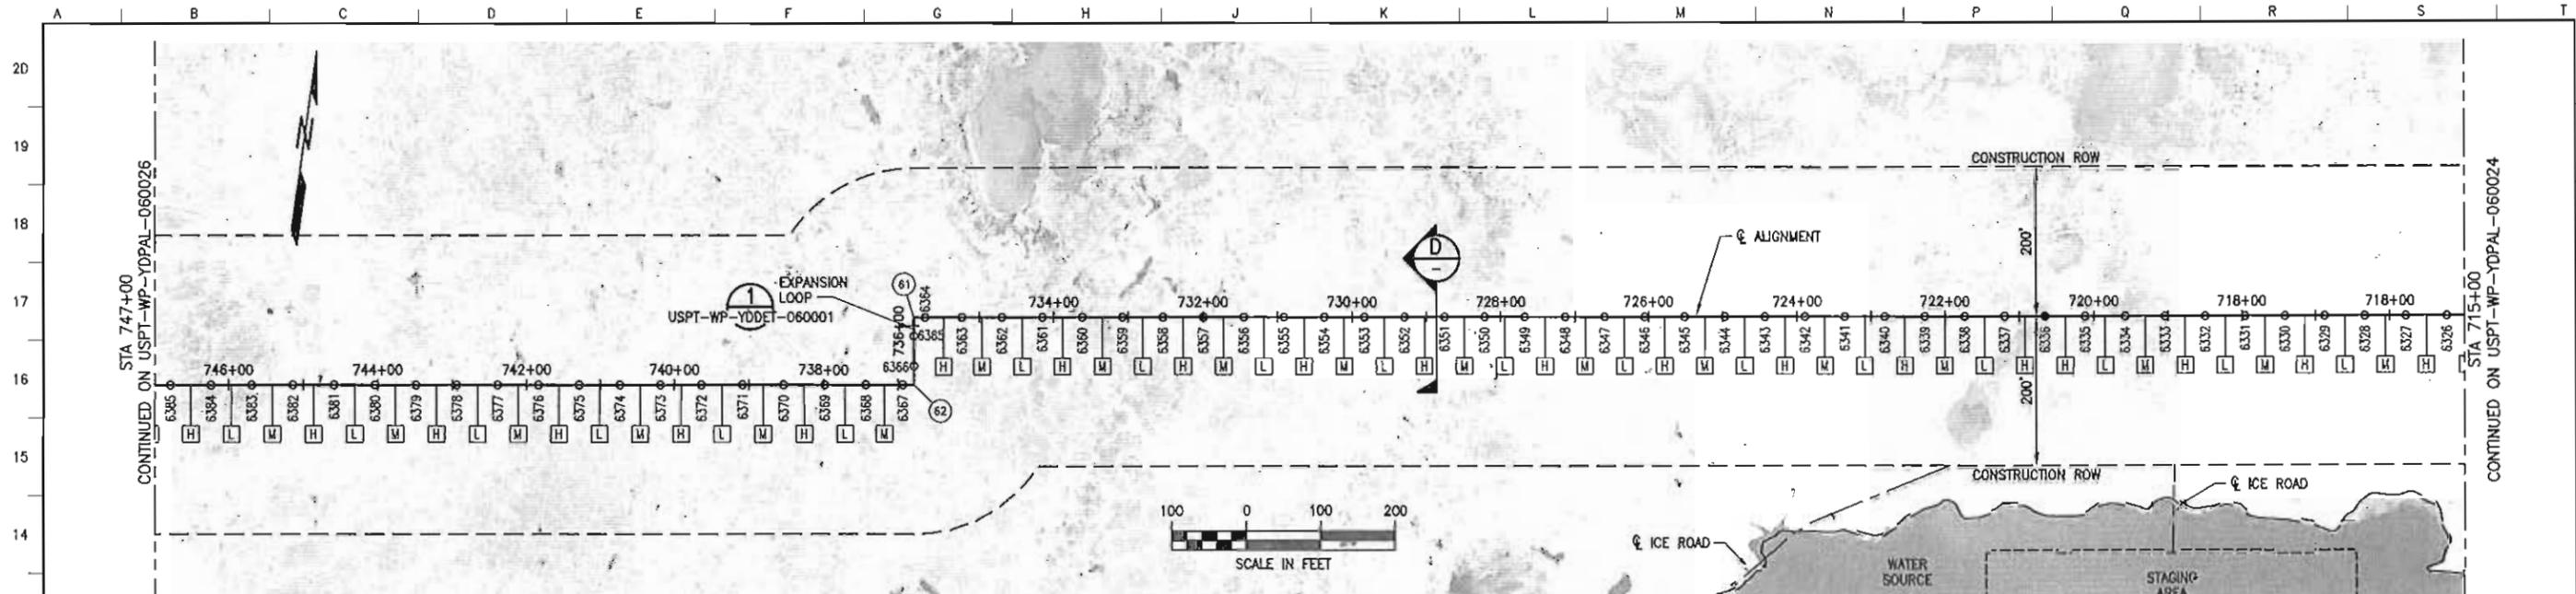

LOCATION	MATERIAL	WALL THK (IN)	FBE COATING (MIL)	INSULATION (IN)
715+00 TO 747+00	12.75" DIA API 5L X85	0.406	SHOP: 20 MIN, 32 MAX FIELD: 25 MIN, 39 MAX	3.0



POINT	DESCRIPTION	STATION	NORTHING	EASTING	ANGLE
61	PI	735+88.57	5905634.31	1538519.54	90.0°
62	PI	736+78.57	5905545.19	1538532.08	90.0°

PIPE SUPPORT IDENTIFICATION
 VERTICAL SUPPORT
 LOCATION CODE
 UNIT/MODULE
 SEQUENTIAL NUMBER
 (SHOWN ON PLAN & PROFILE)

SUPPORT TYPE NOMENCLATURE
 EXPORT = "X"
 GUIDE = "G"
 SLIDE = "S"
 ANCHOR = "A"
 HSM LENGTH (FT)
 NOMINAL VSM DIAMETER (IN)
 VSM LENGTH (FT)
 MINIMUM EMBEDMENT (FT)

NOTES
 1. CENTERLINE OF ALIGNMENT = CENTERLINE OF 12"-LN-644-0049-ME8EV-3"H.
 2. STATIONING ALONG ALIGNMENT REFLECTS HORIZONTAL DISTANCE.
 3. HORIZONTAL DATUM IS NAD83, ALASKA STATE PLANE ZONE 3, US FOOT.
 4. VERTICAL DATUM IS POINT THOMSON UNIT MEAN LOWER LOW WATER (PTU MLLW).
 5. FOR GUIDED AND ANCHORED SUPPORT DETAILS, SEE USPT-WP-YDDET-060010.
 6. FOR SLIDING SUPPORT DETAILS, SEE USPT-WP-YDDET-060011.
 7. FOR WIND-INDUCED VIBRATION MITIGATION PLAN AND TUNED VIBRATION ABSORBER (TVA) INSTALLATION, SEE USPT-WP-YDWV-060001.


LEGEND
 ○ GUIDED OR SLIDING SUPPORT □ HIGH FREQUENCY TVA
 ● ANCHORED SUPPORT □ LOW FREQUENCY TVA
 ⊙ PI OR VPI LOCATION □ MEDIUM FREQUENCY TVA

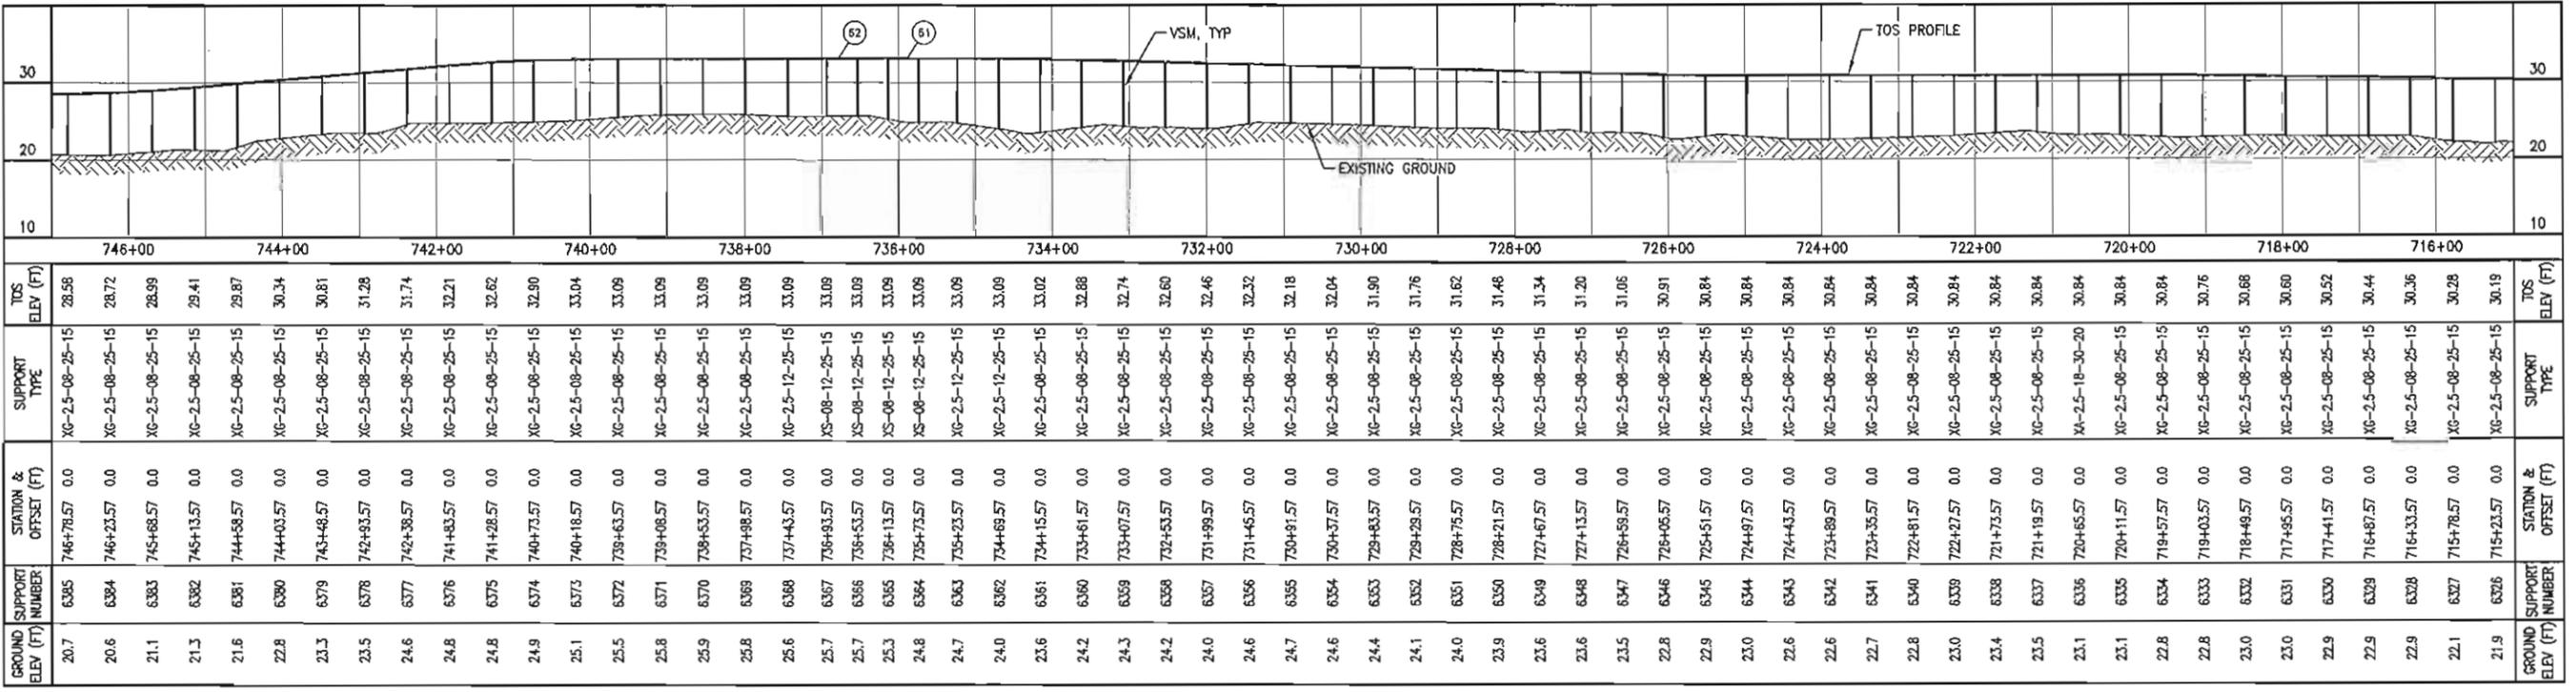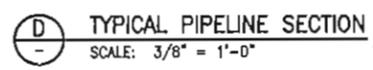

REFERENCE DRAWINGS	DESCRIPTION
USPT-WP-YDSYM-060001	PROJECT NOTES, ABBREVIATIONS AND LEGEND
USPT-WP-YDPAL-060001	SITE PLAN
USPT-WP-YDDET-060001	TYPICAL EXPANSION LOOP DETAIL
USPT-WP-YDDET-060010	GUIDED AND ANCHORED SUPPORT DETAILS
USPT-WP-YDDET-060011	SLIDING SUPPORT DETAILS
USPT-WP-YDWV-060001	WIND-INDUCED VIBRATION MITIGATION PLAN




REV	DATE	DESCRIPTION	BY	CHK	APPD	PROJ
10	12/28/11	ISSUED FOR CONSTRUCTION	RFH	JAG	PAC	GWP

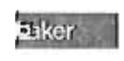

EXPORT PIPELINE - PIPELINE PIPELINE ALIGNMENT SHEET PLAN & PROFILE STA 715+00 TO STA 747+00					
POINT THOMSON			ALASKA		
DESIGNED	DRAWN	DATE	SCALE	AS SHOWN	CHK APPD
R. HOBBS		12/11			PAC
DRAWING NO.	SHEET		REV		
USPT-WP-YDPAL-060025-001	1 of 1		10		

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FILENAME: USPT-WP-YDPAL-060025-001

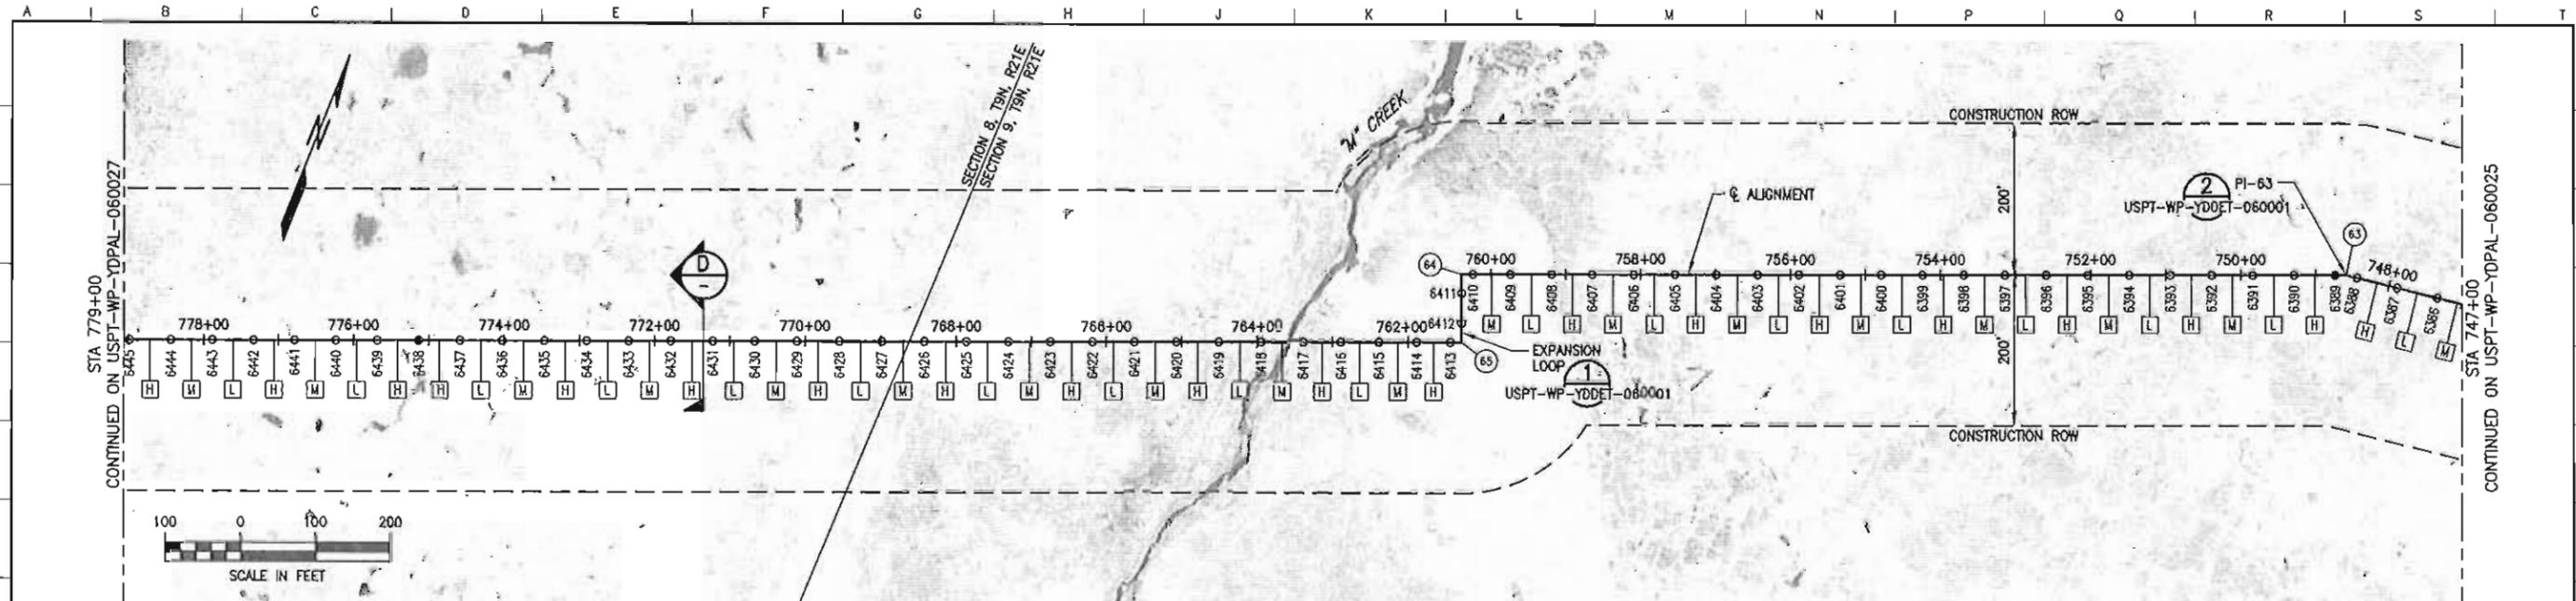

LOCATION	MATERIAL	WALL THK (IN)	FBE COATING (MIL)	INSULATION (IN)
747+00 TO 779+00	12.75" OIA API 5L X65	0.406	SHOP: 20 MIN, 32 MAX FIELD: 25 MIN, 39 MAX	3.0



POINT #	DESCRIPTION	STATION	NORTHING	EASTING	ANGLE
63	PI	748+58.57	5905380.95	1537363.55	14.0°
64	PI	760+38.57	5904938.90	1536269.48	90.0°
65	PI	781+28.57	5904855.46	1536303.19	90.0°

PIPE SUPPORT IDENTIFICATION
 VS-08-704-XXXX
 VERTICAL SUPPORT
 LOCATION CODE
 UNIT/MODULE
 SEQUENTIAL NUMBER
 (SHOWN ON PLAN & PROFILE)

SUPPORT TYPE NOMENCLATURE
 XX-XX-XX-XX-XX
 EXPORT = "X"
 GUIDE = "G"
 SLIDE = "S"
 ANCHOR = "A"
 HSM LENGTH (FT)
 NOMINAL VSM DIAMETER (IN)
 VSM LENGTH (FT)
 MINIMUM EMBEDEDMENT (FT)

- NOTES**
- CENTERLINE OF ALIGNMENT = CENTERLINE OF 12"-LN-644-0049-ME8EV-3"H.
 - STATIONING ALONG ALIGNMENT REFLECTS HORIZONTAL DISTANCE.
 - HORIZONTAL DATUM IS NAD83, ALASKA STATE PLANE ZONE 3, US FOOT.
 - VERTICAL DATUM IS POINT THOMSON UNIT MEAN LOWER LOW WATER (PTU MLLW).
 - FOR GUIDED AND ANCHORED SUPPORT DETAILS, SEE USPT-WP-YDDET-060010.
 - FOR SLIDING SUPPORT DETAILS, SEE USPT-WP-YDDET-060011.
 - FOR WIND-INDUCED VIBRATION MITIGATION PLAN AND TUNED VIBRATION ABSORBER (TVA) INSTALLATION, SEE USPT-WP-YDHW-060001.

- LEGEND**
- GUIDED OR SLIDING SUPPORT
 - ANCHORED SUPPORT
 - ⊙ PI OR VPI LOCATION
 - H HIGH FREQUENCY TVA
 - L LOW FREQUENCY TVA
 - M MEDIUM FREQUENCY TVA

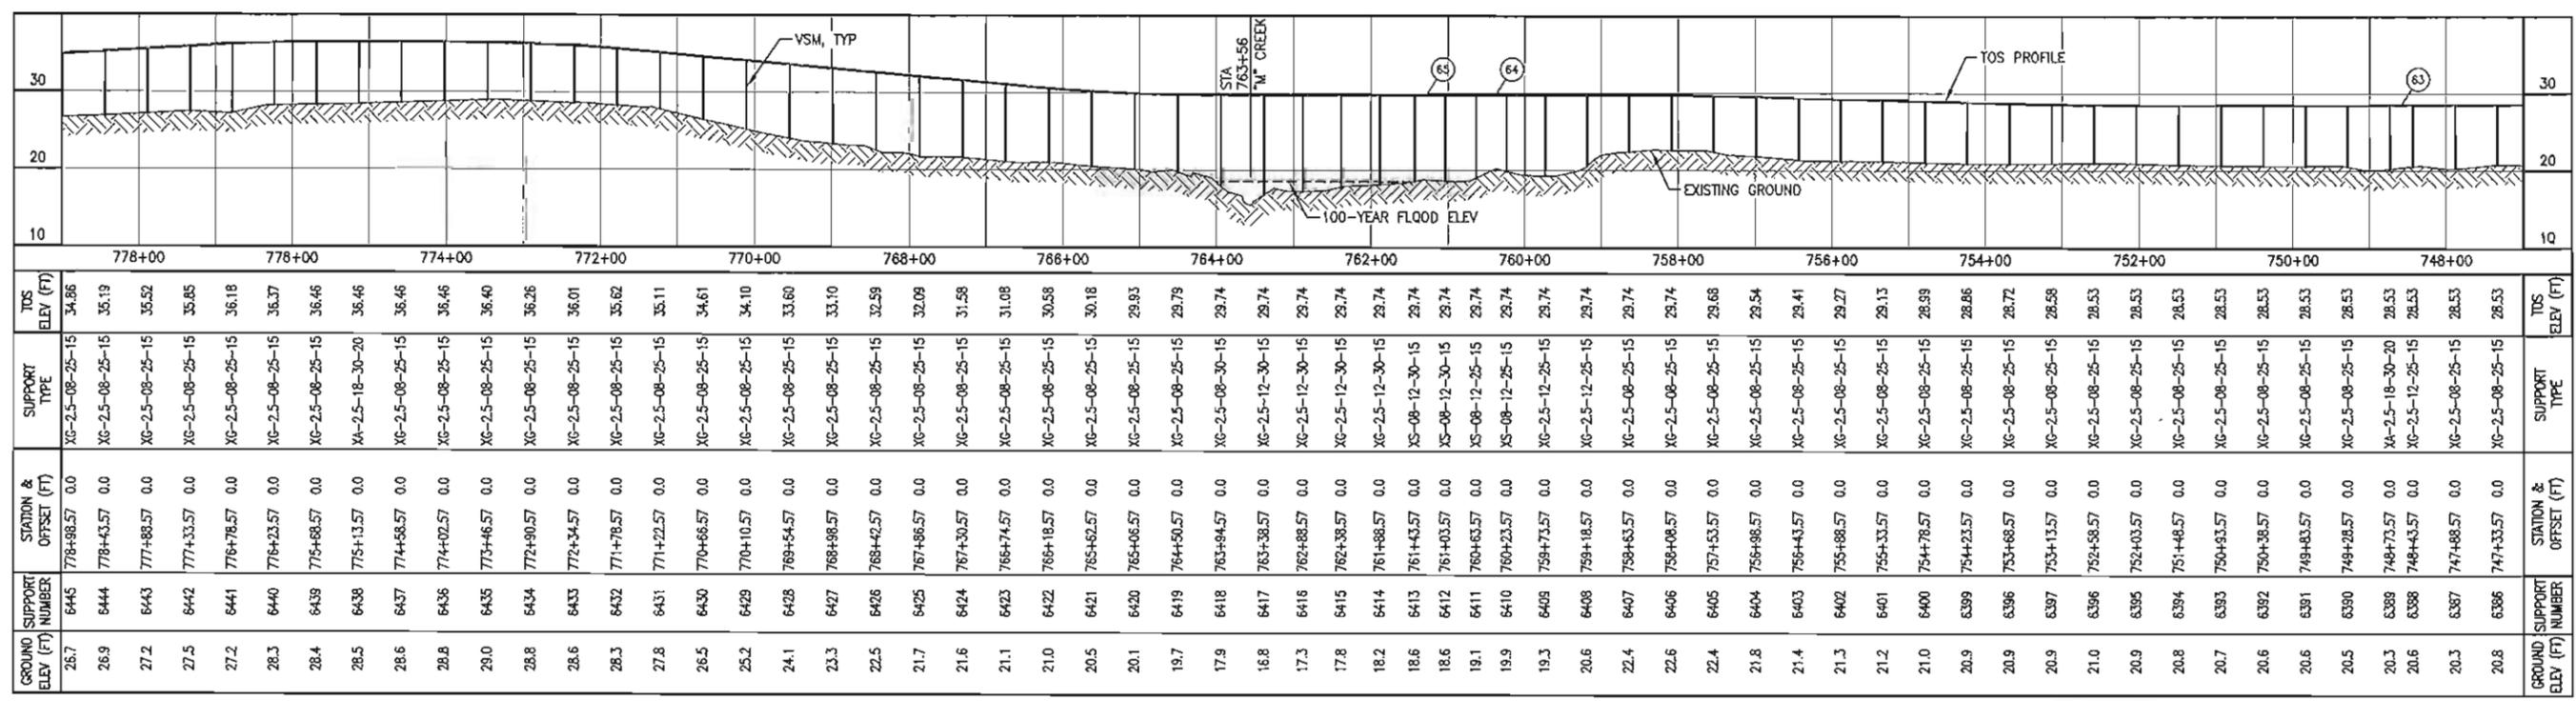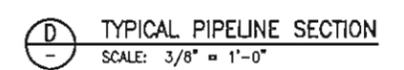

REFERENCE DRAWINGS	DESCRIPTION
USPT-WP-YDSYM-060001	PROJECT NOTES, ABBREVIATIONS AND LEGEND
USPT-WP-YDPAL-060001	SITE PLAN
USPT-WP-YDDET-060001	TYPICAL EXPANSION LOOP DETAIL
USPT-WP-YDDET-060010	GUIDED AND ANCHORED SUPPORT DETAILS
USPT-WP-YDDET-060011	SLIDING SUPPORT DETAILS
USPT-WP-YDHW-060001	WIND-INDUCED VIBRATION MITIGATION PLAN



REV	DATE	DESCRIPTION	BY	CHK	APPD	PROJ
10	12/28/11	ISSUED FOR CONSTRUCTION	RH	WJ	PAC	REP

ExxonMobil Development


WorleyParsons FLUOR, Baker

EXPORT PIPELINE - PIPELINE PIPELINE ALIGNMENT SHEET			
PLAN & PROFILE			
STA 747+00 TO STA 779+00			
POINT THOMSON	DATE	SCALE	ALASKA
MODULE	12/11	AS SHOWN	CHK APPD PAC
DRAWN	R. HOBBS	AS SHOWN	CHK APPD PAC
DRAWING NO.	USPT-WP-YDPAL-060026-001	SHEET	REV
		1 of 1	10

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FILENAME: USPT-WP-YDPAL-060026-001

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LOCATION	MATERIAL	WALL THK (IN)	FBE COATING (MIL)	INSULATION (IN)
779+00 TO 811+00	12.75" DIA API 5L X65	0.406	SHOP: 20 MIN, 32 MAX FIELD: 25 MIN, 39 MAX	3.0



POINT	DESCRIPTION	STATION	NORTHING	EASTING	ANGLE
68	PI	789+53.57	5903797.17	1533683.91	90.0°
67	PI	790+43.57	5903880.61	1533650.19	90.0°

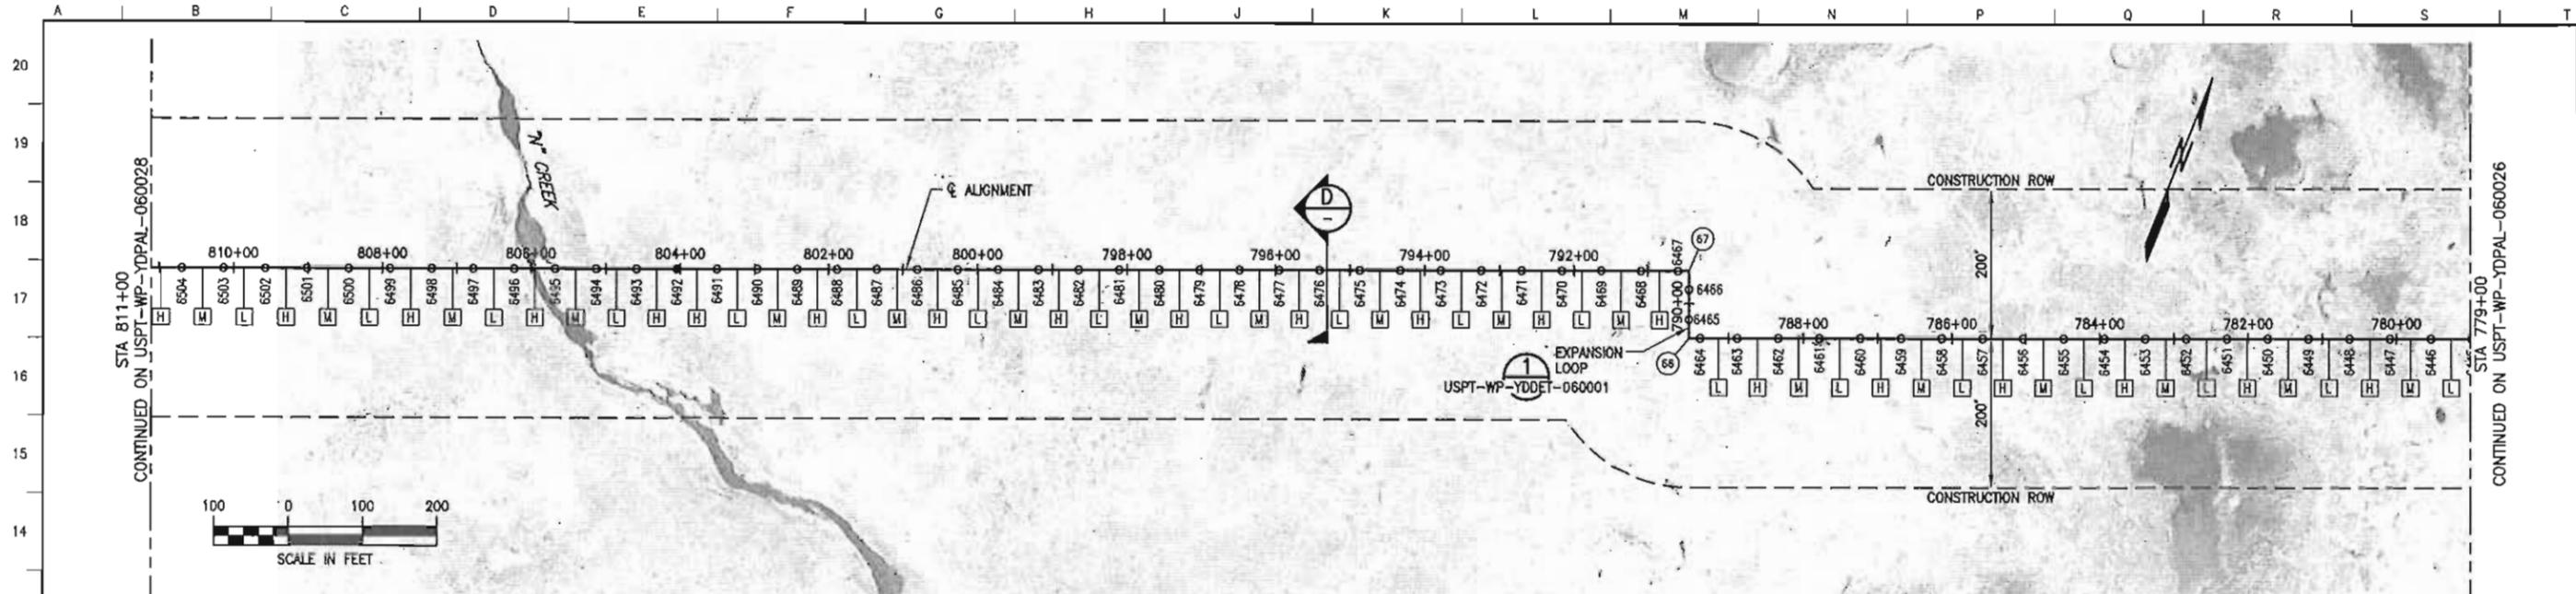PIPE SUPPORT IDENTIFICATION
 VERTICAL SUPPORT
 LOCATION CODE
 UNIT/MODULE
 SEQUENTIAL NUMBER (SHOWN ON PLAN & PROFILE)

SUPPORT TYPE NOMENCLATURE
 EXPORT = "X"
 GUIDE = "G"
 SLIDE = "S"
 ANCHOR = "A"
 HSM LENGTH (FT)
 NOMINAL VSM DIAMETER (IN)
 VSM LENGTH (FT)
 MINIMUM EMBEDMENT (FT)

- NOTES**
- CENTERLINE OF ALIGNMENT = CENTERLINE OF 12"-LN-644-0049-MEBEV-37H.
 - STATIONING ALONG ALIGNMENT REFLECTS HORIZONTAL DISTANCE.
 - HORIZONTAL DATUM IS NAD83, ALASKA STATE PLANE ZONE 3, US FOOT.
 - VERTICAL DATUM IS POINT THOMSON UNIT MEAN LOWER LOW WATER (PTU MLW).
 - FOR GUIDED AND ANCHORED SUPPORT DETAILS, SEE USPT-WP-YDOET-060010.
 - FOR SLIDING SUPPORT DETAILS, SEE USPT-WP-YDOET-060011.
 - FOR WIND-INDUCED VIBRATION MITIGATION PLAN AND TUNED VIBRATION ABSORBER (TVA) INSTALLATION, SEE USPT-WP-YDWIN-060001.

- LEGEND**
- GUIDED OR SLIDING SUPPORT
 - ANCHORED SUPPORT
 - ⊙ PI OR VPI LOCATION
 - HIGH FREQUENCY TVA
 - LOW FREQUENCY TVA
 - MEDIUM FREQUENCY TVA

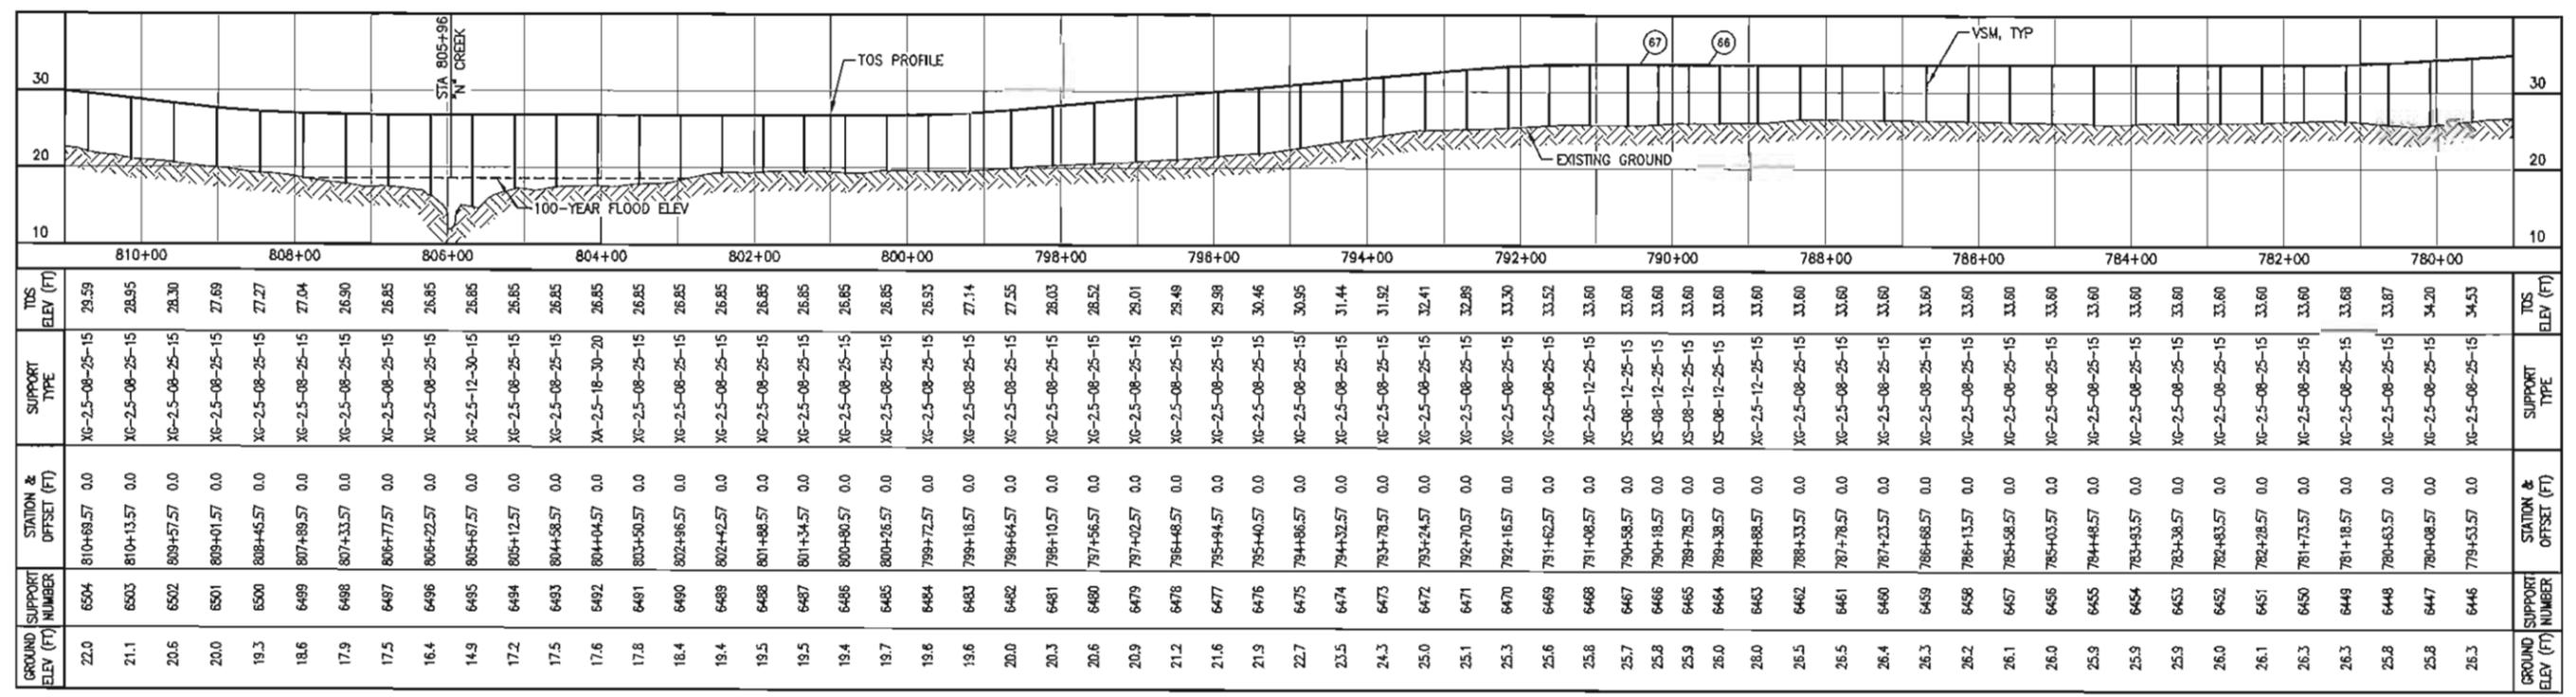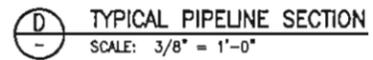

REFERENCE DRAWINGS	DESCRIPTION
USPT-WP-YDSIM-060001	PROJECT NOTES, ABBREVIATIONS AND LEGEND
USPT-WP-YDPAL-060001	SITE PLAN
USPT-WP-YDOET-060001	TYPICAL EXPANSION LOOP DETAIL
USPT-WP-YDOET-060010	GUIDED AND ANCHORED SUPPORT DETAILS
USPT-WP-YDOET-060011	SLIDING SUPPORT DETAILS
USPT-WP-YDWIN-060001	WIND-INDUCED VIBRATION MITIGATION PLAN




REV	DATE	DESCRIPTION	BY	CHK	APPD	PROJ
10	12/28/11	ISSUED FOR CONSTRUCTION				

ExxonMobil
Development

WorleyParsons **FLUOR** Baker

EXPORT PIPELINE -- PIPELINE ALIGNMENT SHEET PLAN & PROFILE			
STA 779+00 TO STA 811+00			
MODULE	DRAWN	DATE	SCALE
AS SHOWN	R. HOBBS	12/11	AS SHOWN
DRIVING NO.	DATE	SCALE	CHK APPD
USPT-WP-YDPAL-060027-001	12/11	AS SHOWN	R. HOBBS
1 of 1	10		

FILENAME: USPT-WP-YDPAL-060027-001

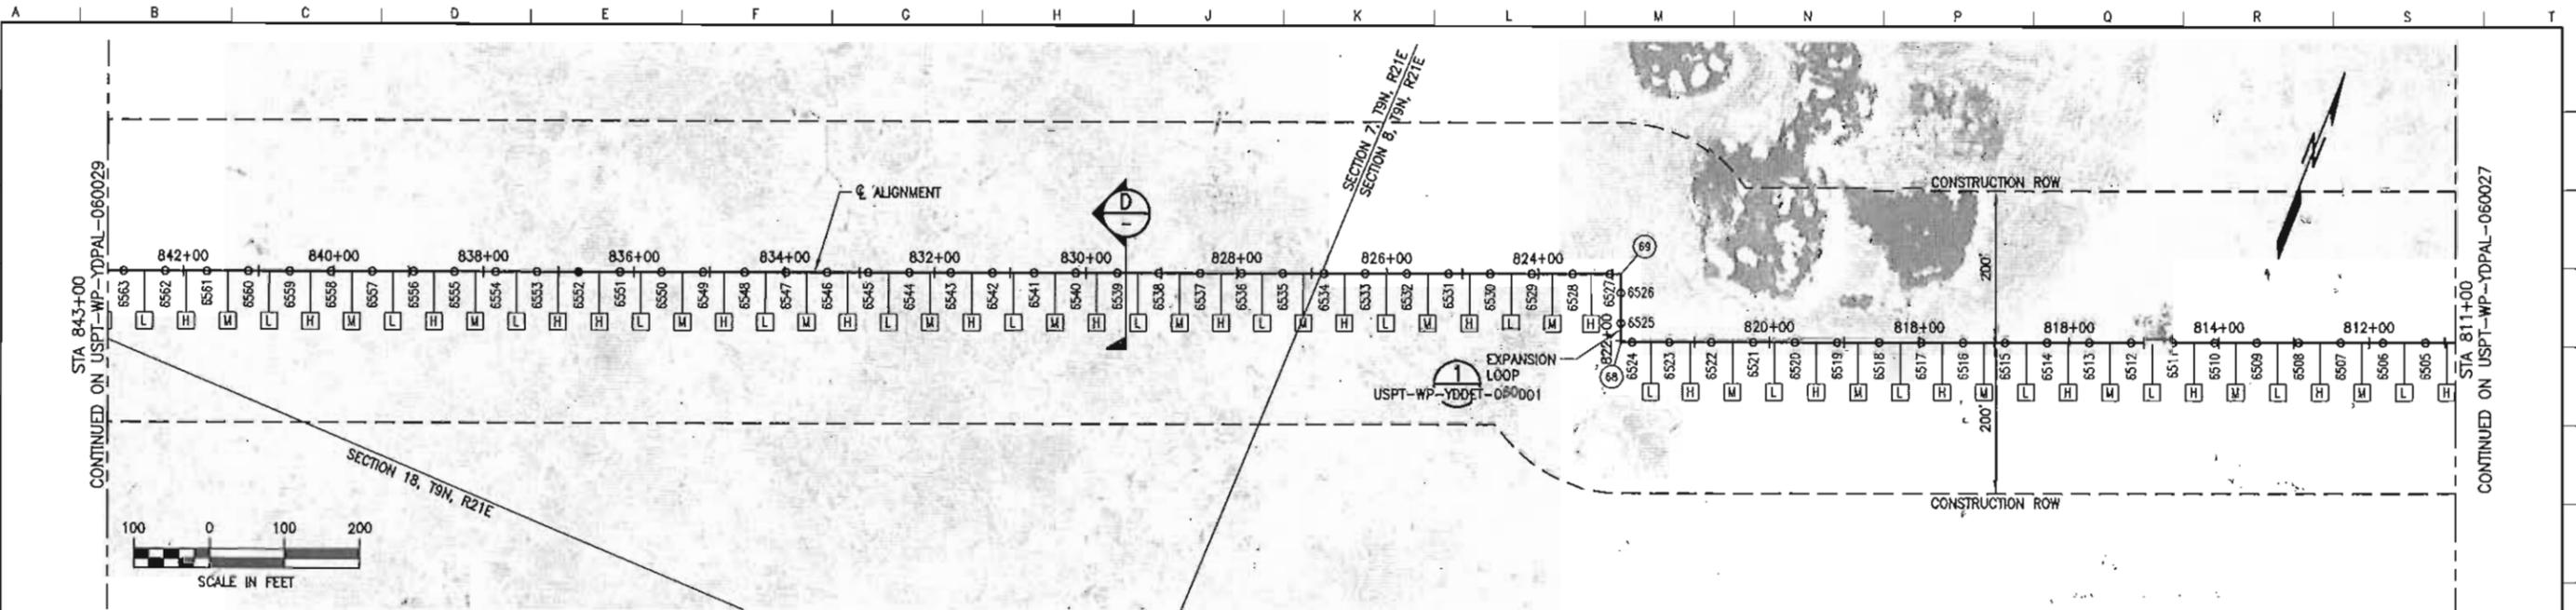

LOCATION	MATERIAL	WALL THK (IN)	FBE COATING (MIL)	INSULATION (IN)
811+00 TO 843+00	12.75" DIA API 5L X65	0.406	SHOP: 20 MIN, 32 MAX FIELD: 25 MIN, 39 MAX	3.0

POINT #	DESCRIPTION	STATION	NORTHING	EASTING	ANGLE
68	PI	821+98.57	5902698.70	1530724.94	90.0°
69	PI	822+88.57	5902762.14	1530691.23	90.0°

PIPE SUPPORT IDENTIFICATION
 VERTICAL SUPPORT: VS-06-704-XXXX
 LOCATION CODE: XX-XX-XX-XX-XX
 UNIT/MODULE: XX-XX-XX-XX-XX
 SEQUENTIAL NUMBER (SHOWN ON PLAN & PROFILE): XX-XX-XX-XX-XX

SUPPORT TYPE NOMENCLATURE
 EXPORT = "X"
 GUIDE = "G"
 SLOPE = "S"
 ANCHOR = "A"
 HSM LENGTH (FT)
 NOMINAL VSM DIAMETER (IN)
 VSM LENGTH (FT)
 MINIMUM EMBEDMENT (FT)


NOTES

- CENTERLINE OF ALIGNMENT = CENTERLINE OF 12"-LN-644-0049-ME0EV-3TH.
- STATIONING ALONG ALIGNMENT REFLECTS HORIZONTAL DISTANCE.
- HORIZONTAL DATUM IS NAD83, ALASKA STATE PLANE ZONE 3, US FOOT.
- VERTICAL DATUM IS POINT THOMSON UNIT MEAN LOWER LOW WATER (PTU MLLW).
- FOR GUIDED AND ANCHORED SUPPORT DETAILS, SEE USPT-WP-YDDET-060010.
- FOR SLIDING SUPPORT DETAILS, SEE USPT-WP-YDDET-060011.
- FOR WIND-INDUCED VIBRATION MITIGATION PLAN AND TUNED VIBRATION ABSORBER (TVA) INSTALLATION, SEE USPT-WP-YDHW-060001.

LEGEND

- GUIDED OR SLIDING SUPPORT
- ANCHORED SUPPORT
- ⊙ PI OR VPI LOCATION
- [H] HIGH FREQUENCY TVA
- [L] LOW FREQUENCY TVA
- [M] MEDIUM FREQUENCY TVA

TYPICAL PIPELINE SECTION
 SCALE: 3/8" = 1'-0"

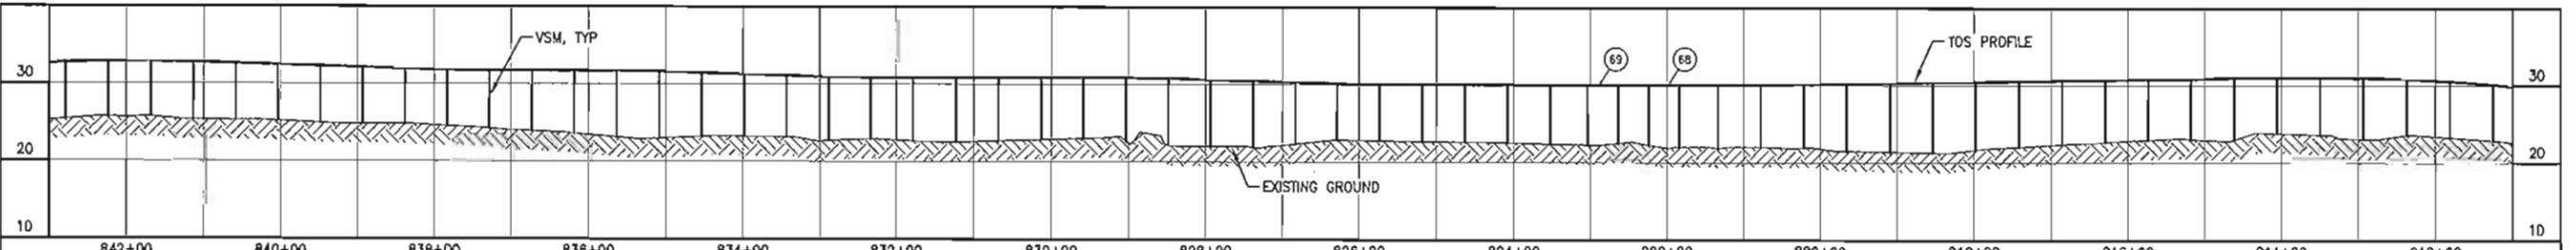

STATION	GROUND ELEV (FT)	SUPPORT NUMBER	STATION & OFFSET (FT)	SUPPORT TYPE	TOS ELEV (FT)
842+00	25.4	6563	842+78.57 0.0	XG-2.5-08-25-15	32.71
842+00	25.7	6562	842+23.57 0.0	XG-2.5-08-25-15	32.84
841+00	25.8	6561	841+68.57 0.0	XG-2.5-08-25-15	32.84
841+00	25.4	6560	841+13.57 0.0	XG-2.5-08-25-15	32.76
840+00	25.3	6559	840+58.57 0.0	XG-2.5-08-25-15	32.60
840+00	25.2	6558	840+03.57 0.0	XG-2.5-08-25-15	32.43
838+00	25.0	6557	839+48.57 0.0	XG-2.5-08-25-15	32.27
838+00	24.9	6556	838+93.57 0.0	XG-2.5-08-25-15	32.10
838+00	24.8	6555	838+38.57 0.0	XG-2.5-08-25-15	31.94
838+00	24.6	6554	837+83.57 0.0	XG-2.5-08-25-15	31.77
836+00	24.3	6553	837+28.57 0.0	XG-2.5-08-25-15	31.69
836+00	23.9	6552	836+73.57 0.0	XA-2.5-18-30-20	31.69
836+00	23.6	6551	836+18.57 0.0	XG-2.5-08-25-15	31.69
836+00	23.1	6550	835+63.57 0.0	XG-2.5-08-25-15	31.69
834+00	23.0	6549	835+08.57 0.0	XG-2.5-08-25-15	31.61
834+00	23.2	6548	834+53.57 0.0	XG-2.5-08-25-15	31.44
834+00	23.3	6547	833+98.57 0.0	XG-2.5-08-25-15	31.28
834+00	23.2	6546	833+43.57 0.0	XG-2.5-08-25-15	31.11
832+00	22.8	6545	832+88.57 0.0	XG-2.5-08-25-15	30.95
832+00	23.0	6544	832+33.57 0.0	XG-2.5-08-25-15	30.86
832+00	22.7	6543	831+78.57 0.0	XG-2.5-08-25-15	30.86
832+00	22.5	6542	831+23.57 0.0	XG-2.5-08-25-15	30.86
830+00	22.7	6541	830+68.57 0.0	XG-2.5-08-25-15	30.86
830+00	22.9	6540	830+13.57 0.0	XG-2.5-08-25-15	30.86
828+00	23.0	6539	829+58.57 0.0	XG-2.5-08-25-15	30.86
828+00	22.7	6538	829+03.57 0.0	XG-2.5-08-25-15	30.86
828+00	22.3	6537	828+48.57 0.0	XG-2.5-08-25-15	30.78
828+00	22.0	6536	827+93.57 0.0	XG-2.5-08-25-15	30.62
826+00	21.9	6535	827+38.57 0.0	XG-2.5-08-25-15	30.45
826+00	22.4	6534	826+83.57 0.0	XG-2.5-08-25-15	30.29
826+00	22.9	6533	826+28.57 0.0	XG-2.5-08-25-15	30.12
826+00	22.8	6532	825+73.57 0.0	XG-2.5-08-25-15	30.04
824+00	22.7	6531	825+18.57 0.0	XG-2.5-08-25-15	30.04
824+00	22.6	6530	824+63.57 0.0	XG-2.5-08-25-15	30.04
824+00	22.6	6529	824+08.57 0.0	XG-2.5-08-25-15	30.04
822+00	22.4	6528	823+53.57 0.0	XG-2.5-12-25-15	30.04
822+00	22.3	6527	823+03.57 0.0	XG-08-12-25-15	30.04
822+00	22.5	6526	822+43.57 0.0	XG-08-12-25-15	30.04
822+00	22.3	6525	822+23.57 0.0	XG-08-12-25-15	30.04
822+00	22.0	6524	821+63.57 0.0	XG-08-12-25-15	30.04
822+00	21.9	6523	821+33.57 0.0	XG-2.5-12-25-15	30.04
820+00	22.0	6522	820+77.57 0.0	XG-2.5-12-25-15	30.04
820+00	22.0	6521	820+21.57 0.0	XG-2.5-08-25-15	30.12
818+00	21.5	6520	819+65.57 0.0	XG-2.5-08-25-15	30.21
818+00	21.4	6519	819+09.57 0.0	XG-2.5-08-25-15	30.29
818+00	21.3	6518	818+53.57 0.0	XG-2.5-08-25-15	30.37
818+00	21.7	6517	817+97.57 0.0	XG-2.5-08-25-15	30.46
816+00	22.1	6516	817+41.57 0.0	XG-2.5-08-25-15	30.54
816+00	22.4	6515	816+85.57 0.0	XG-2.5-08-25-15	30.63
816+00	22.7	6514	816+29.57 0.0	XG-2.5-08-25-15	30.71
814+00	23.0	6513	815+73.57 0.0	XG-2.5-08-25-15	30.79
814+00	23.1	6512	815+17.57 0.0	XG-2.5-08-25-15	30.88
814+00	23.0	6511	814+61.57 0.0	XG-2.5-08-25-15	30.96
812+00	23.9	6510	814+05.57 0.0	XG-2.5-08-25-15	31.05
812+00	23.6	6509	813+49.57 0.0	XG-2.5-08-25-15	31.05
812+00	23.1	6508	812+93.57 0.0	XG-2.5-08-25-15	30.99
812+00	23.6	6507	812+37.57 0.0	XG-2.5-08-25-15	30.85
812+00	23.3	6506	811+81.57 0.0	XG-2.5-08-25-15	30.57
812+00	22.9	6505	811+25.57 0.0	XG-2.5-08-25-15	30.15

REFERENCE DRAWINGS	DESCRIPTION
USPT-WP-YDSM-060001	PROJECT NOTES, ABBREVIATIONS AND LEGEND
USPT-WP-YDPAL-060001	SITE PLAN
USPT-WP-YDDET-060001	TYPICAL EXPANSION LOOP DETAIL
USPT-WP-YDDET-060010	GUIDED AND ANCHORED SUPPORT DETAILS
USPT-WP-YDDET-060011	SLIDING SUPPORT DETAILS
USPT-WP-YDHW-060001	WIND-INDUCED VIBRATION MITIGATION PLAN




REV	DATE	DESCRIPTION	BY	CHK	APPD	PROJ
10	12/28/11	ISSUED FOR CONSTRUCTION	RHP	ANG	PAC	GMP



EXPERT PIPELINE - PIPELINE ALIGNMENT SHEET			
PLAN & PROFILE			
STA 811+00 TO STA 843+00			
DATE	SCALE	CHECKED	DATE
12/11	AS SHOWN	R. HOBBS	12/11
DRAWING NO. USPT-WP-YDPAL-060028-001		SHEET 1 of 1	

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FILENAME: USPT-WP-YDPAL-060028-001

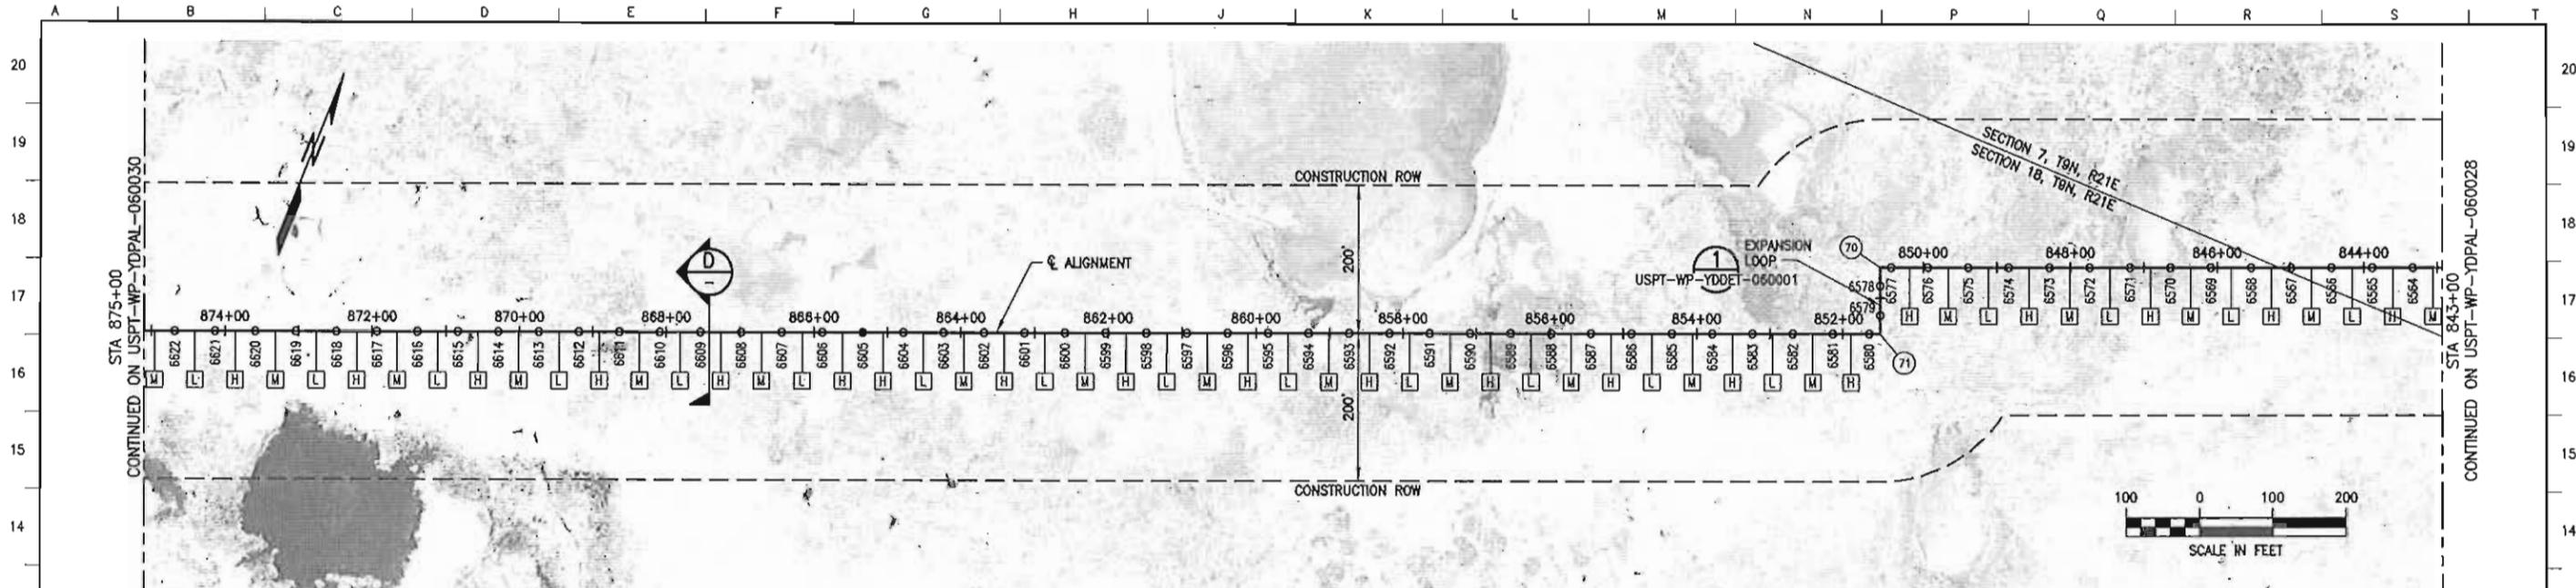

LOCATION	MATERIAL	WALL THK (IN)	FBE COATING (MIL)	INSULATION (IN)
843+00 TO 875+00	12.75" DIA API 5L X65	0.406	SHOP: 20 MIN, 32 MAX FIELD: 25 MIN, 39 MAX	3.0

POINT	DESCRIPTION	STATION	NORTHING	EASTING	ANGLE
70	PI	850+58.57	5901744.46	1528122.94	90.0°
71	PI	851+48.57	5901661.01	1528156.65	90.0°

PIPE SUPPORT IDENTIFICATION

VS-06-704-XXXX

VERTICAL SUPPORT
LOCATION CODE
UNIT/MODULE
SEQUENTIAL NUMBER
(SHOWN ON PLAN & PROFILE)

SUPPORT TYPE NOMENCLATURE



XX-XX-XX-XX-XX

EXPORT = "X"
GUIDE = "G"
SLOJE = "S"
ANCHOR = "A"

HSM LENGTH (FT)
NOMINAL VSM DIAMETER (IN)
VSM LENGTH (FT)
MINIMUM EMBEDMENT (FT)

- NOTES**
- CENTERLINE OF ALIGNMENT = CENTERLINE OF 12"-LN-644-0049-MEBEV-3"H.
 - STATIONING ALONG ALIGNMENT REFLECTS HORIZONTAL DISTANCE.
 - HORIZONTAL DATUM IS NAD83, ALASKA STATE PLANE ZONE 3, US FOOT.
 - VERTICAL DATUM IS POINT THOMSON UNIT MEAN LOWER LOW WATER (PTU MLLW).
 - FOR GUIDED AND ANCHORED SUPPORT DETAILS, SEE USPT-WP-YDDET-060010.
 - FOR SLIDING SUPPORT DETAILS, SEE USPT-WP-YDDET-060011.
 - FOR WIND-INDUCED VIBRATION MITIGATION PLAN AND TUNED VIBRATION ABSORBER (TVA) INSTALLATION, SEE USPT-WP-YDHW-060001.

- LEGEND**
- GUIDED OR SLIDING SUPPORT
 - ANCHORED SUPPORT
 - ⊙ PI OR VPI LOCATION
 - HIGH FREQUENCY TVA
 - LOW FREQUENCY TVA
 - MEDIUM FREQUENCY TVA

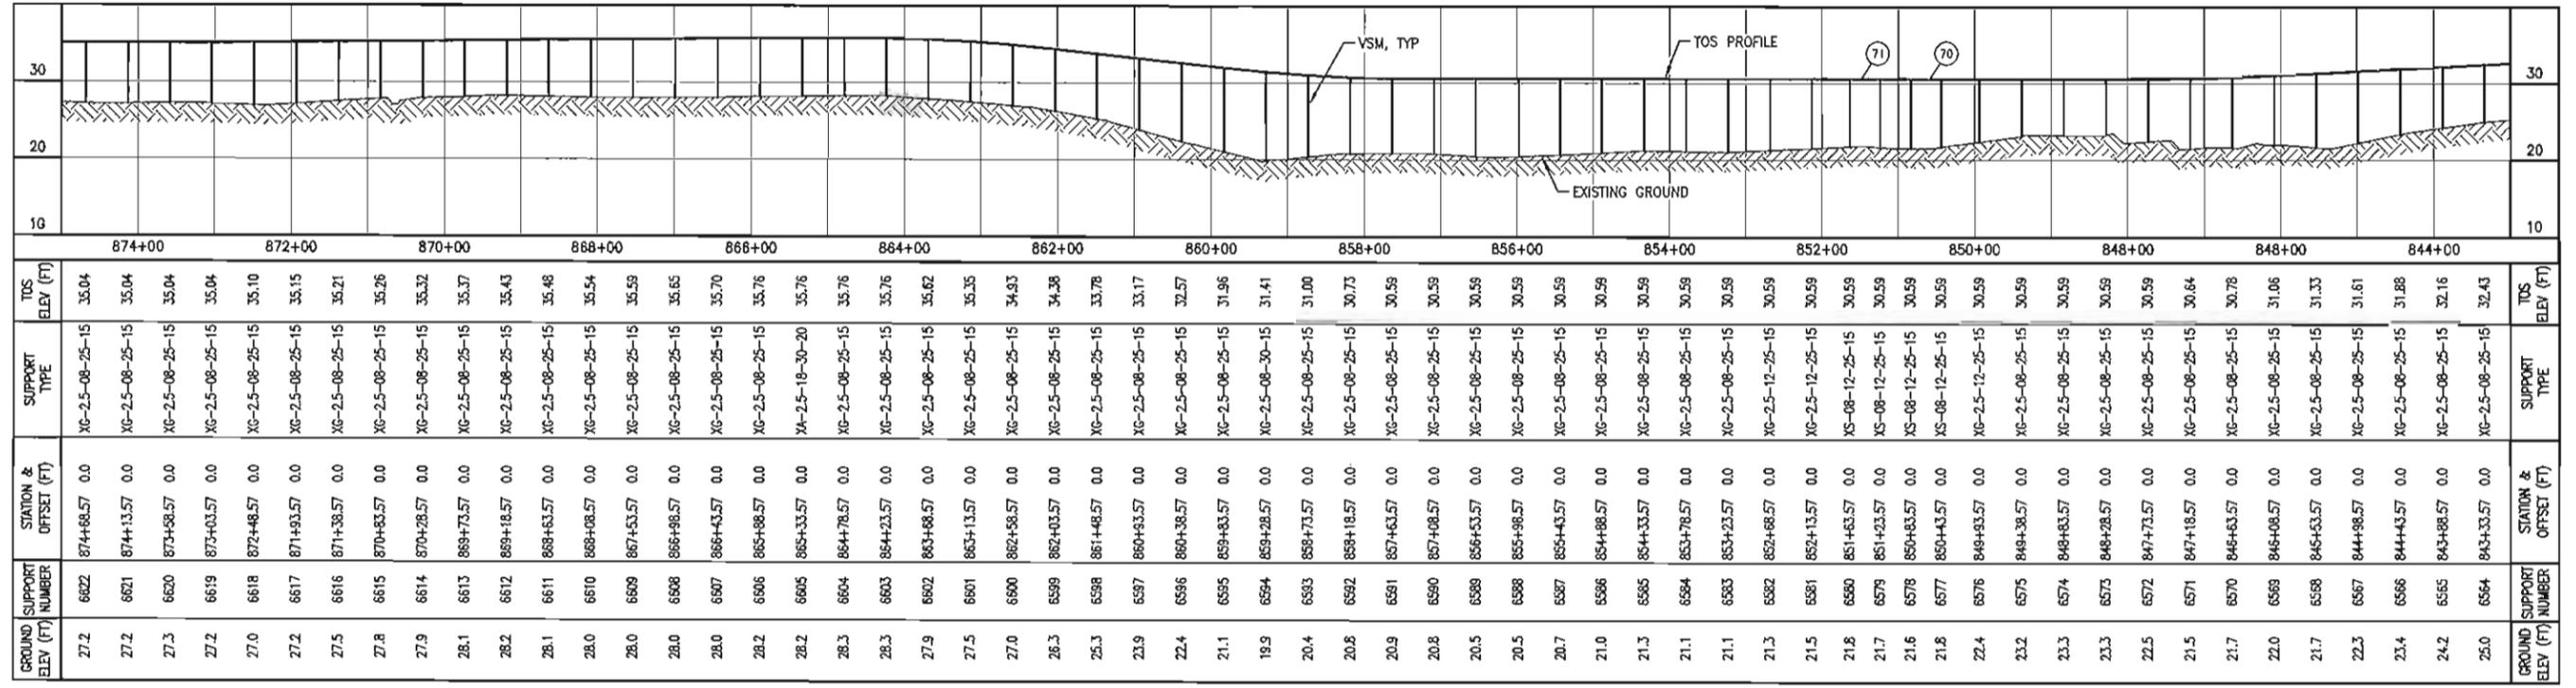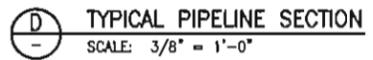

REFERENCE DRAWINGS	DESCRIPTION
USPT-WP-YDSYM-060001	PROJECT NOTES, ABBREVIATIONS AND LEGEND
USPT-WP-YDPAL-060001	SITE PLAN
USPT-WP-YDDET-060001	TYPICAL EXPANSION LOOP DETAIL
USPT-WP-YDDET-060010	GUIDED AND ANCHORED SUPPORT DETAILS
USPT-WP-YDDET-060011	SLIDING SUPPORT DETAILS
USPT-WP-YDHW-060001	WIND-INDUCED VIBRATION MITIGATION PLAN



REV	DATE	DESCRIPTION	BY	CHK	APPD	PROJ
10	12/28/11	ISSUED FOR CONSTRUCTION	RH	WJ	PAC	OMP


ExxonMobil
Development

WorleyParsons **FLUOR**, Baker

EXPOR PIPELINE - PIPELINE				ALASKA			
PIPELINE ALIGNMENT SHEET				POINT THOMSON			
PLAN & PROFILE				MODULE			
STA 843+00 TO STA 875+00				DRAWN			
				DATE			
				SCALE			
				AS SHOWN			
				CHK			
				APPD			
				PAC			
				SHEET			
				REV			
USPT-WP-YDPAL-060029-001				1 of 1			

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FILENAME: USPT-WP-YDPAL-060029-001

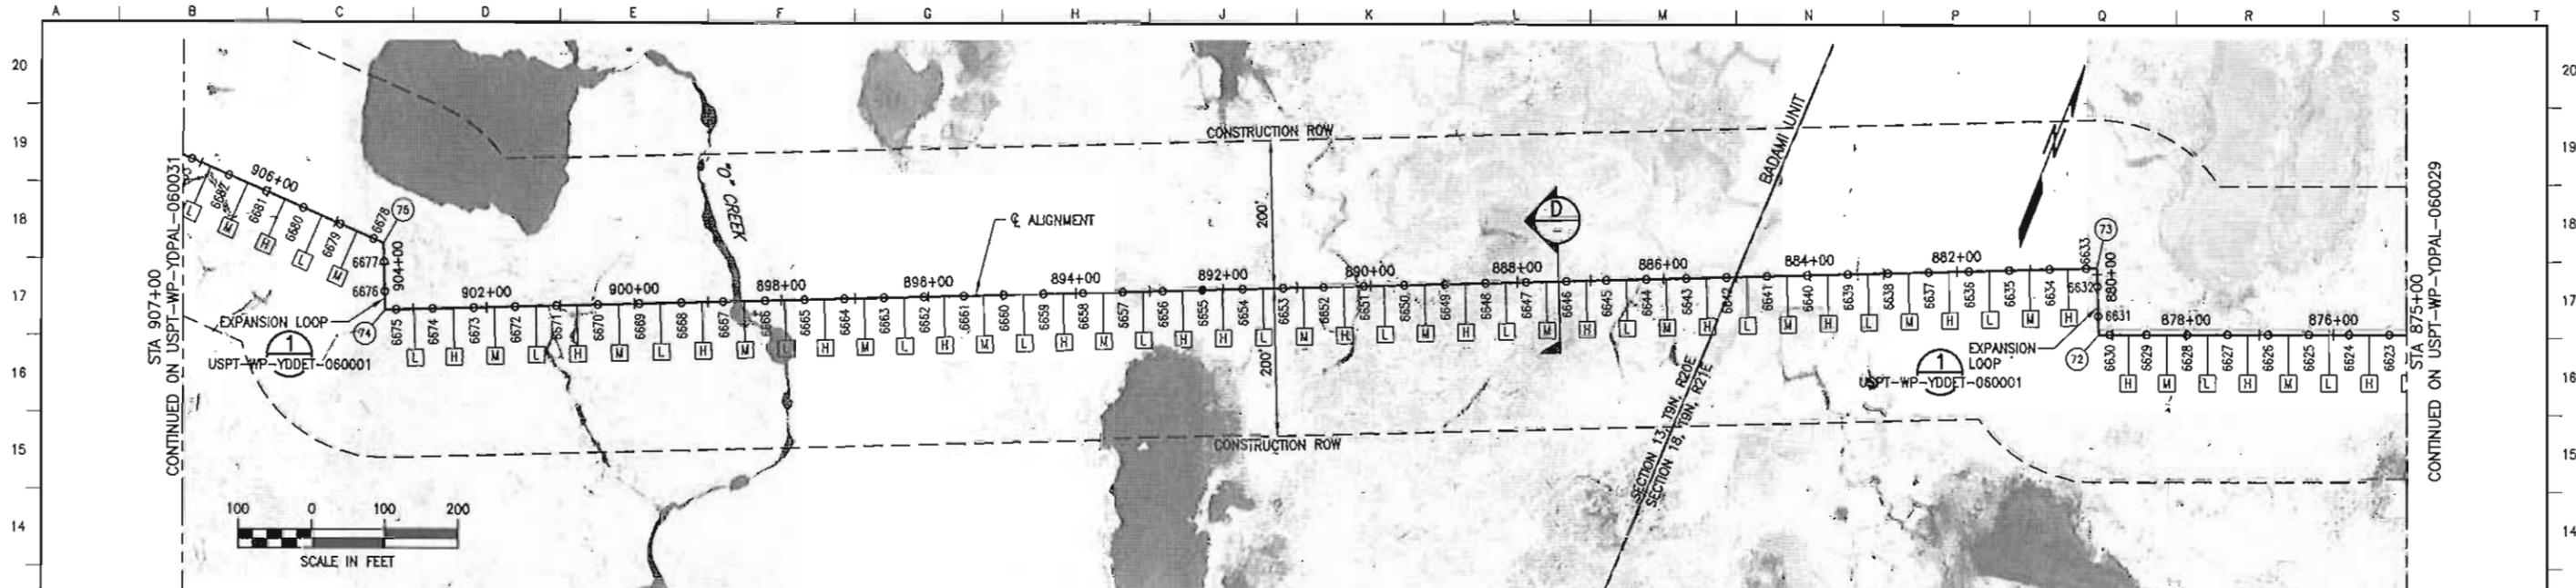

LOCATION	MATERIAL	WALL THK (IN)	FBE COATING (MIL)	INSULATION (IN)
875+00 TO 907+00	12.75" DIA API 5L X65	0.406	SHOP: 20 MIN, 32 MAX FIELD: 25 MIN, 39 MAX	3.0

POINT	DESCRIPTION	STATION	NORTHING	EASTING	ANGLE
72	PI	879+18.57	5900623.32	1525588.37	88.5°
73	PI	880+08.57	5900705.86	1525552.48	90.0°
74	PI	903+38.57	5899776.75	1523415.74	90.0°
75	PI	904+28.57	5899659.29	1523379.85	65.0°



PIPE SUPPORT IDENTIFICATION
 VS-06-704-XXXX

SUPPORT TYPE NOMENCLATURE
 XX-XX-XX-XX-XX

LEGEND

- GUIDED OR SLIDING SUPPORT
- ANCHORED SUPPORT
- ⊕ PI OR VPI LOCATION
- ⊠ HIGH FREQUENCY TVA
- ⊡ LOW FREQUENCY TVA
- ⊞ MEDIUM FREQUENCY TVA


- NOTES**
- CENTERLINE OF ALIGNMENT = CENTERLINE OF 12"-LN-644-0049-MEBEV-3"H.
 - STATIONING ALONG ALIGNMENT REFLECTS HORIZONTAL DISTANCE.
 - HORIZONTAL DATUM IS NAD83, ALASKA STATE PLANE ZONE 3, US FOOT.
 - VERTICAL DATUM IS POINT THOMSON UNIT MEAN LOWER LOW WATER (PTU MLLW).
 - FOR GUIDED AND ANCHORED SUPPORT DETAILS, SEE USPT-WP-YODET-060010.
 - FOR SLIDING SUPPORT DETAILS, SEE USPT-WP-YODET-060011.
 - FOR WIND-INDUCED VIBRATION MITIGATION PLAN AND TUNED VIBRATION ABSORBER (TVA) INSTALLATION, SEE USPT-WP-YDHW-060001.

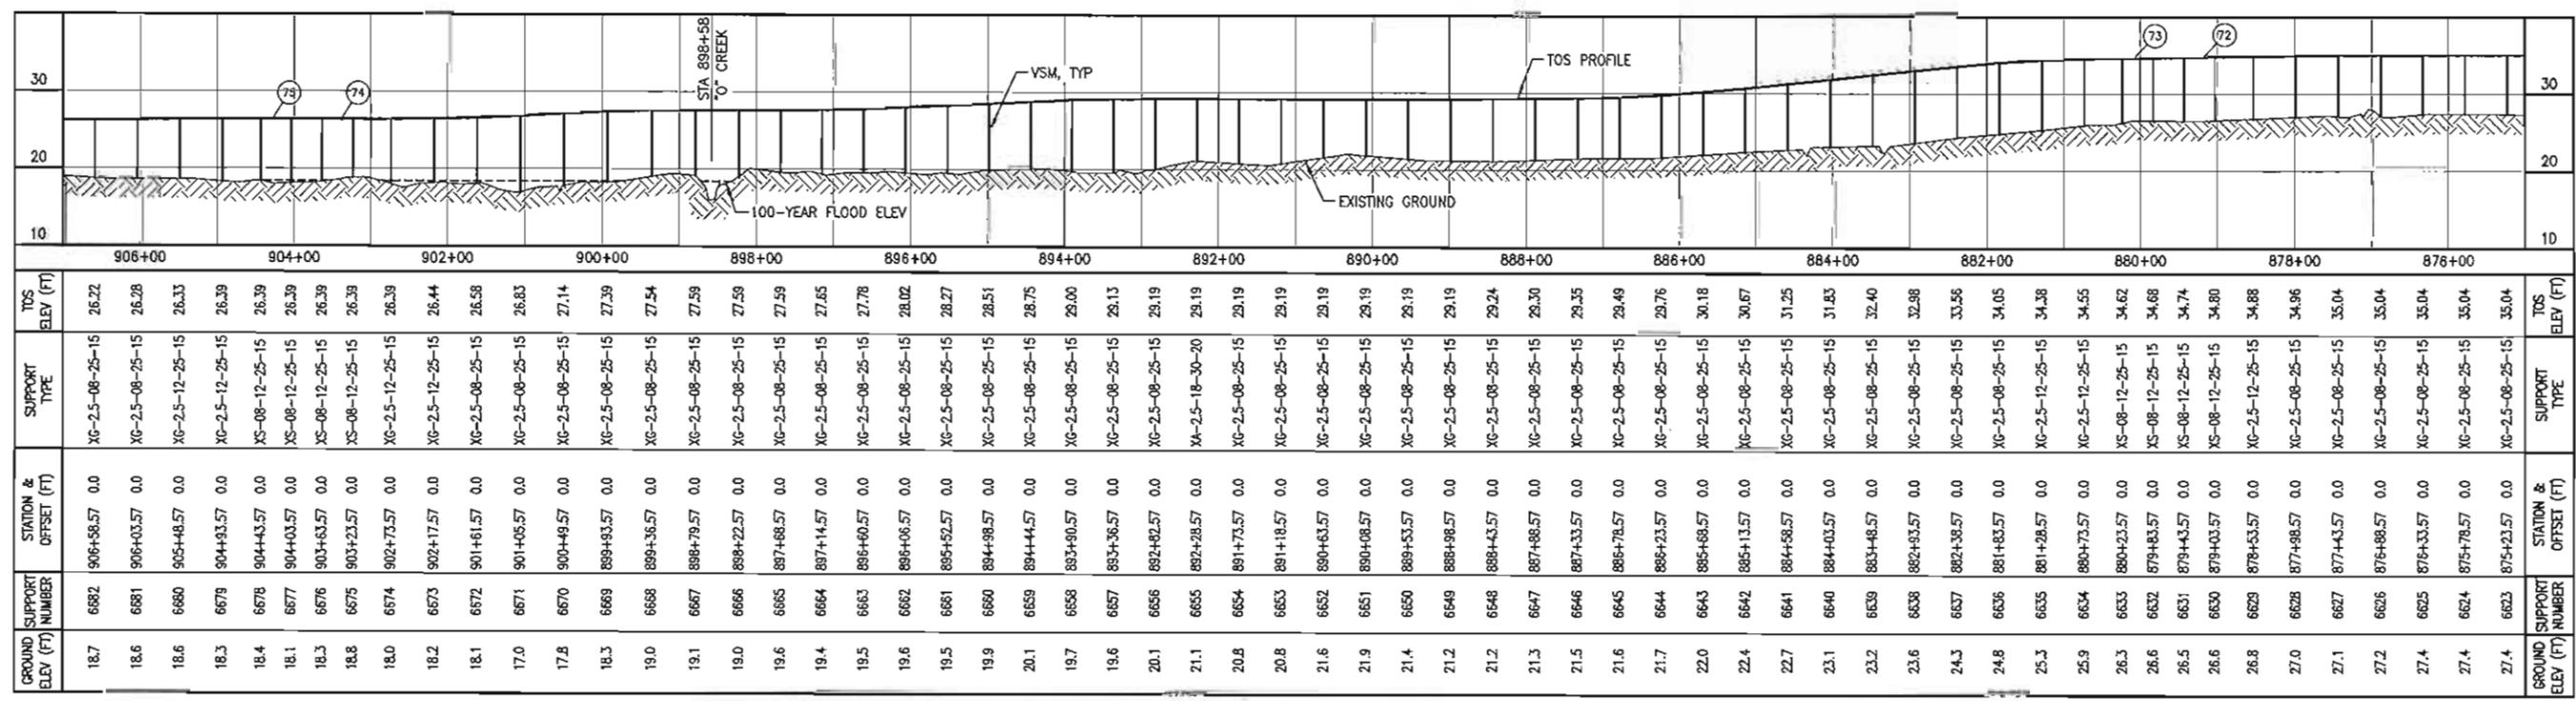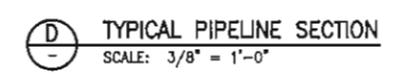

REFERENCE DRAWINGS	DESCRIPTION
USPT-WP-YDPAL-060001	PROJECT NOTES, ABBREVIATIONS AND LEGEND
USPT-WP-YDEET-060001	SITE PLAN
USPT-WP-YDEET-060010	TYPICAL EXPANSION LOOP DETAIL
USPT-WP-YDEET-060011	GUIDED AND ANCHORED SUPPORT DETAILS
USPT-WP-YDHW-060001	SLIDING SUPPORT DETAILS
USPT-WP-YDHW-060001	WIND-INDUCED VIBRATION MITIGATION PLAN




REV	DATE	DESCRIPTION	BY	CHK	APPD	PROJ
10	12/26/11	ISSUED FOR CONSTRUCTION	RH	JAG	PAC	GWP

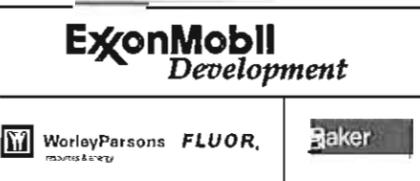

EXPORT PIPELINE - PIPELINE PIPELINE ALIGNMENT SHEET PLAN & PROFILE STA 875+00 TO STA 907+00					
POINT THOMSON	ORIGIN	DATE	SCALE	CHK	JAG
WOCULL	R. HOBBS	12/11	AS SHOWN	APPD	PAC
DRAWING NO.	USPT-WP-YDPAL-060030-001		SHEET	1	REV
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FILENAME: USPT-WP-YDPAL-060030-001



LOCATION	MATERIAL	WALL THK (IN)	FBE COATING (MIL)	INSULATION (IN)
907+00 TO 939+00	12.75" DIA API 5L X85	0.406	SHOP: 20 MIN, 32 MAX FIELD: 25 MIN, 39 MAX	3.0

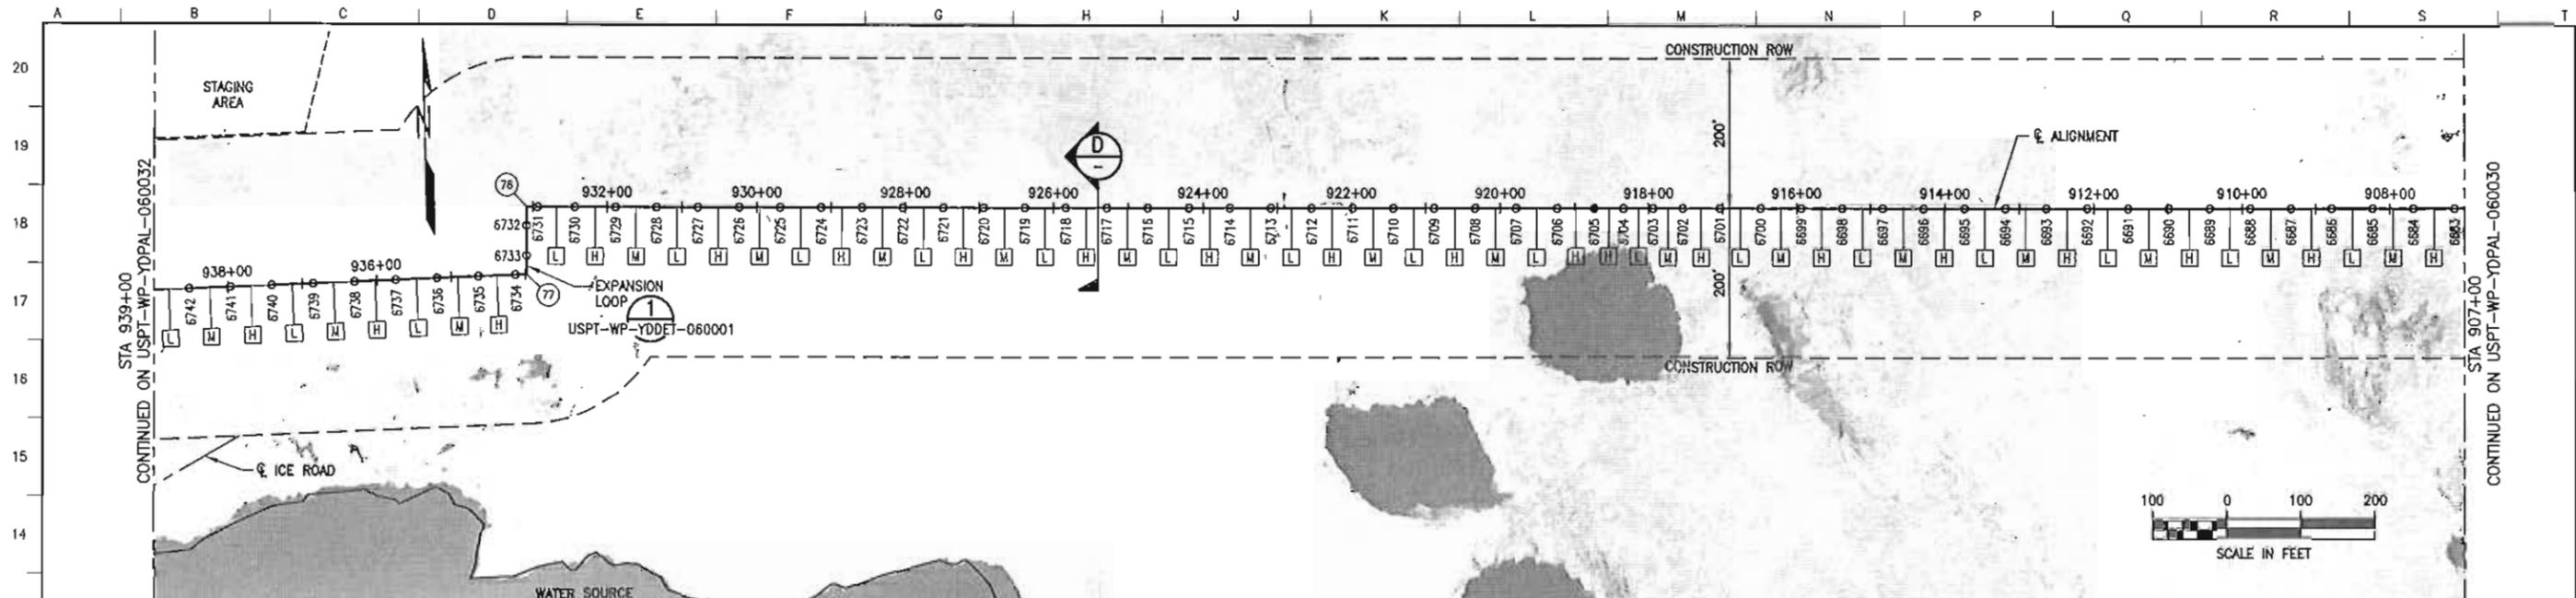POINT	DESCRIPTION	STATION	NORTHING	EASTING	ANGLE
76	PI	933+08.57	5899934.65	1520500.83	90.0'
77	PI	933+98.57	5899844.68	1520498.48	87.44'

PIPE SUPPORT IDENTIFICATION

VS-08-704-XXXX

VERTICAL SUPPORT
LOCATION CODE
UNIT/MODULE
SEQUENTIAL NUMBER
(SHOWN ON PLAN & PROFILE)

SUPPORT TYPE NOMENCLATURE


XX-XX-XX-XX-XX

EXPORT = "X"
GUIDE = "G"
SLIDE = "S"
ANCHOR = "A"

HSM LENGTH (FT)
NOMINAL VSM DIAMETER (IN)
VSM LENGTH (FT)
MINIMUM EMBEDMENT (FT)

- NOTES**
- CENTERLINE OF ALIGNMENT = CENTERLINE OF 12"-LN-644-0049-ME8EV-3TH.
 - STATIONING ALONG ALIGNMENT REFLECTS HORIZONTAL DISTANCE.
 - HORIZONTAL DATUM IS NAD83, ALASKA STATE PLANE ZONE 3, US FOOT.
 - VERTICAL DATUM IS POINT THOMSON UNIT MEAN LOWER LOW WATER (PTU MLLW).
 - FOR GUIDED AND ANCHORED SUPPORT DETAILS, SEE USPT-WP-YDDET-060010.
 - FOR SLIDING SUPPORT DETAILS, SEE USPT-WP-YDDET-060011.
 - FOR WIND-INDUCED VIBRATION MITIGATION PLAN AND TUNED VIBRATION ABSORBER (TYA) INSTALLATION, SEE USPT-WP-YDWW-060001.

- LEGEND**
- GUIDED OR SLIDING SUPPORT
 - ANCHORED SUPPORT
 - ① PI OR VPI LOCATION
 - HIGH FREQUENCY TYA
 - LOW FREQUENCY TYA
 - MEDIUM FREQUENCY TYA

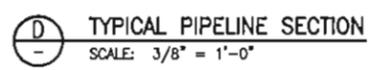

GROUND ELEV (FT)	SUPPORT NUMBER	STATION & OFFSET (FT)	SUPPORT TYPE	TOS ELEV (FT)
17.2	6742	938+52.07 0.0	XG-2.5-08-25-15	25.09
17.3	6741	937+96.57 0.0	XG-2.5-08-25-15	25.17
17.5	6740	937+41.07 0.0	XG-2.5-08-25-15	25.26
17.8	6739	936+86.57 0.0	XG-2.5-08-25-15	25.34
18.1	6738	936+30.07 0.0	XG-2.5-08-25-15	25.34
18.0	6737	935+74.57 0.0	XG-2.5-08-25-15	25.34
18.0	6736	935+19.07 0.0	XG-2.5-08-25-15	25.34
18.0	6735	934+63.57 0.0	XG-2.5-08-25-15	25.34
17.8	6734	934+13.57 0.0	XS-08-12-25-15	25.34
17.4	6733	933+73.57 0.0	XS-08-12-25-15	25.34
16.8	6732	933+33.57 0.0	XS-08-12-25-15	25.34
16.5	6731	932+93.57 0.0	XS-08-12-25-15	25.34
17.2	6730	932+43.57 0.0	XG-2.5-08-25-15	25.34
17.1	6729	931+88.57 0.0	XG-2.5-08-25-15	25.34
16.9	6728	931+33.57 0.0	XG-2.5-08-25-15	25.29
16.9	6727	930+78.57 0.0	XG-2.5-08-25-15	25.15
16.7	6726	930+23.57 0.0	XG-2.5-08-25-15	24.90
16.5	6725	929+68.57 0.0	XG-2.5-08-25-15	24.60
16.3	6724	929+13.57 0.0	XG-2.5-08-25-15	24.30
16.2	6723	928+58.57 0.0	XG-2.5-08-25-15	24.05
16.0	6722	928+03.57 0.0	XG-2.5-08-25-15	23.91
15.8	6721	927+48.57 0.0	XG-2.5-08-25-15	23.86
15.4	6720	926+93.57 0.0	XG-2.5-08-25-15	23.86
15.1	6719	926+38.57 0.0	XG-2.5-08-25-15	23.86
15.2	6718	925+83.57 0.0	XG-2.5-08-25-15	23.86
15.3	6717	925+28.57 0.0	XG-2.5-08-25-15	23.86
15.6	6716	924+73.57 0.0	XG-2.5-08-25-15	23.86
15.8	6715	924+18.57 0.0	XG-2.5-08-25-15	23.86
16.0	6714	923+63.57 0.0	XG-2.5-08-25-15	23.86
15.9	6713	923+08.57 0.0	XG-2.5-08-25-15	23.86
15.4	6712	922+53.57 0.0	XG-2.5-08-25-15	23.86
14.9	6711	921+98.57 0.0	XG-2.5-08-25-15	23.86
15.1	6710	921+43.57 0.0	XG-2.5-08-25-15	23.86
15.4	6709	920+88.57 0.0	XG-2.5-08-25-15	23.86
15.7	6708	920+33.57 0.0	XG-2.5-08-25-15	23.86
15.7	6707	919+78.57 0.0	XG-2.5-08-25-15	23.86
15.8	6706	919+23.57 0.0	XG-2.5-08-25-15	23.86
16.1	6705	918+73.57 0.0	XA-2.5-18-30-20	23.86
16.3	6704	918+33.57 0.0	XG-2.5-08-25-15	23.86
16.4	6703	917+93.57 0.0	XG-2.5-08-25-15	23.86
16.4	6702	917+53.57 0.0	XG-2.5-08-25-15	23.86
16.4	6701	917+03.57 0.0	XG-2.5-08-25-15	23.86
16.4	6700	916+48.57 0.0	XG-2.5-08-25-15	23.86
16.3	6699	915+93.57 0.0	XG-2.5-08-25-15	23.86
16.2	6698	915+38.57 0.0	XG-2.5-08-25-15	23.86
16.3	6697	914+83.57 0.0	XG-2.5-08-25-15	23.86
16.4	6696	914+28.57 0.0	XG-2.5-08-25-15	23.91
16.1	6695	913+73.57 0.0	XG-2.5-08-25-15	24.05
16.1	6694	913+18.57 0.0	XG-2.5-08-25-15	24.27
16.6	6693	912+63.57 0.0	XG-2.5-08-25-15	24.49
16.9	6692	912+08.57 0.0	XG-2.5-08-25-15	24.71
17.1	6691	911+53.57 0.0	XG-2.5-08-25-15	24.93
17.3	6690	910+98.57 0.0	XG-2.5-08-25-15	25.15
17.5	6689	910+43.57 0.0	XG-2.5-08-25-15	25.37
17.8	6688	909+88.57 0.0	XG-2.5-08-25-15	25.59
18.1	6687	909+33.57 0.0	XG-2.5-08-25-15	25.81
18.2	6686	908+78.57 0.0	XG-2.5-08-25-15	26.03
18.5	6685	908+23.57 0.0	XG-2.5-08-25-15	26.17
18.9	6684	907+68.57 0.0	XG-2.5-08-25-15	26.22
19.1	6683	907+13.57 0.0	XG-2.5-08-25-15	26.22

REFERENCE DRAWINGS	DESCRIPTION
USPT-WP-YDGM-060001	PROJECT NOTES, ABBREVIATIONS AND LEGEND
USPT-WP-YDPAL-060001	SITE PLAN
USPT-WP-YDDET-060001	TYPICAL EXPANSION LOOP DETAIL
USPT-WP-YDDET-060010	GUIDED AND ANCHORED SUPPORT DETAILS
USPT-WP-YDDET-060011	SLIDING SUPPORT DETAILS
USPT-WP-YDWW-060001	WIND-INDUCED VIBRATION MITIGATION PLAN




REV	DATE	DESCRIPTION	BY	CHK	APPD	PROJ
10	12/28/11	ISSUED FOR CONSTRUCTION	R/H	J/D	PAC	GMP

EXPORT PIPELINE - PIPELINE ALIGNMENT SHEET PLAN & PROFILE
STA 907+00 TO STA 939+00

POINT THOMSON		ALASKA	
MODULE	DATE	SCALE	CHK
R. HOBBS	12/11	AS SHOWN	J/D
DRAWING NO.		SHEET	
USPT-WP-YDPAL-060031-001		1 of 1	

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FILENAME: USPT-WP-YDPAL-060031-001

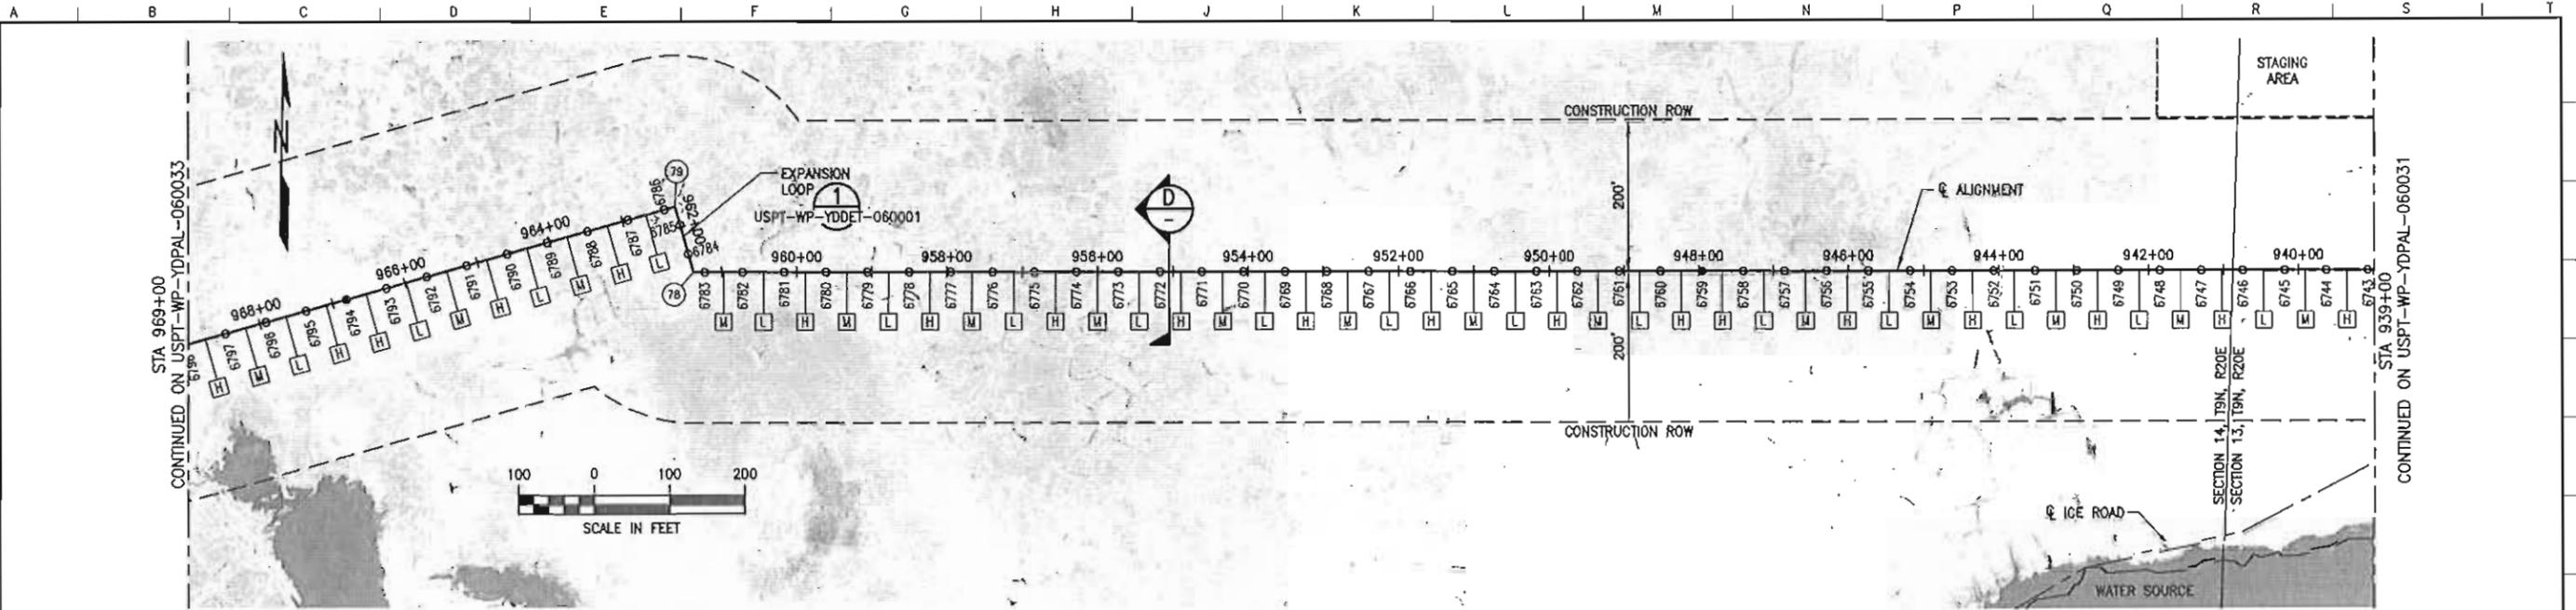

LOCATION	MATERIAL	WALL THK (IN)	FBE COATING (MIL)	INSULATION (IN)
939+00 TO 969+00	12.75" DIA API 5L X85	0.406	SHOP: 20 MIN, 32 MAX FIELD: 25 MIN, 39 MAX	3.0


POINT #	DESCRIPTION	STATION	NORTHING	EASTING	ANGLE
78	PI	961+37.55	5899793.74	1517759.97	74.32'
79	PI	962+27.55	5899879.92	1517734.04	90.0'

PIPE SUPPORT IDENTIFICATION
 VERTICAL SUPPORT LOCATION CODE UNIT/MODULE SEQUENTIAL NUMBER (SHOWN ON PLAN & PROFILE)
 YS-06-704-XXXX

SUPPORT TYPE NOMENCLATURE
 EXPORT = "X"
 GUIDE = "G"
 SLIDE = "S"
 ANCHOR = "A"
 HSM LENGTH (FT)
 NOMINAL VSM DIAMETER (IN)
 VSM LENGTH (FT)
 MINIMUM EMBEDMENT (FT)
 XX-XX-XX-XX-XX

- NOTES**
- CENTERLINE OF ALIGNMENT = CENTERLINE OF 12"-LN-644-0049-ME8EV-3"TH.
 - STATIONING ALONG ALIGNMENT REFLECTS HORIZONTAL DISTANCE.
 - HORIZONTAL DATUM IS NAD83, ALASKA STATE PLANE ZONE 3, US FOOT.
 - VERTICAL DATUM IS POINT THOMSON UNIT MEAN LOWER LOW WATER (PTU MLW).
 - FOR GUIDED AND ANCHORED SUPPORT DETAILS, SEE USPT-WP-YDOET-060010.
 - FOR SLIDING SUPPORT DETAILS, SEE USPT-WP-YDOET-060011.
 - FOR WIND-INDUCED VIBRATION MITIGATION PLAN AND TUNED VIBRATION ABSORBER (TVA) INSTALLATION, SEE USPT-WP-YDWW-060001.

- LEGEND**
- GUIDED OR SLIDING SUPPORT
 - ANCHORED SUPPORT
 - ⊙ PI OR VPI LOCATION
 - ⊠ HIGH FREQUENCY TVA
 - ⊡ LOW FREQUENCY TVA
 - ⊞ MEDIUM FREQUENCY TVA

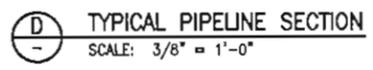

GROUND SUPPORT ELEV (FT)	GROUND SUPPORT NUMBER	STATION & OFFSET (FT)	SUPPORT TYPE	TOS ELEV (FT)
15.5	6797	968+47.55 0.0	XG-2.5-08-25-15	22.88
15.5	6796	967+492.05 0.0	XG-2.5-08-25-15	23.00
15.3	6795	967+36.55 0.0	XG-2.5-08-25-15	23.12
15.2	6794	966+61.05 0.0	XA-2.5-18-30-20	23.12
15.1	6793	966+25.55 0.0	XG-2.5-08-25-15	23.12
15.2	6792	965+70.05 0.0	XG-2.5-08-25-15	23.20
15.4	6791	965+14.55 0.0	XG-2.5-08-25-15	23.51
15.9	6790	964+59.05 0.0	XG-2.5-08-25-15	23.81
16.2	6789	964+03.55 0.0	XG-2.5-08-25-15	24.04
16.2	6788	963+48.05 0.0	XG-2.5-08-25-15	24.12
16.6	6787	962+492.55 0.0	XG-2.5-12-25-15	24.12
16.7	6786	962+42.55 0.0	XS-08-12-25-15	24.12
16.7	6785	962+402.55 0.0	XS-08-12-25-15	24.12
16.7	6784	961+62.55 0.0	XS-08-12-25-15	24.12
16.3	6783	961+22.55 0.0	XS-08-12-25-15	24.12
16.0	6782	960+72.07 0.0	XG-2.5-12-25-15	24.12
16.1	6781	960+16.57 0.0	XG-2.5-12-25-15	24.12
16.0	6780	959+61.07 0.0	XG-2.5-08-25-15	24.12
16.1	6779	959+05.57 0.0	XG-2.5-08-25-15	24.12
16.4	6778	958+50.07 0.0	XG-2.5-08-25-15	24.12
16.6	6777	957+44.57 0.0	XG-2.5-08-25-15	24.12
16.7	6776	957+39.07 0.0	XG-2.5-08-25-15	24.12
16.8	6775	956+83.57 0.0	XG-2.5-08-25-15	24.12
16.9	6774	956+28.07 0.0	XG-2.5-08-25-15	24.12
16.8	6773	955+72.57 0.0	XG-2.5-08-25-15	24.12
16.6	6772	955+17.07 0.0	XG-2.5-08-25-15	24.12
16.5	6771	954+61.57 0.0	XG-2.5-08-25-15	24.12
16.5	6770	954+06.07 0.0	XG-2.5-08-25-15	24.12
16.7	6769	953+50.57 0.0	XG-2.5-08-25-15	24.12
16.5	6768	952+95.07 0.0	XG-2.5-08-25-15	24.12
16.4	6767	952+39.57 0.0	XG-2.5-08-25-15	24.12
16.6	6766	951+84.07 0.0	XG-2.5-08-25-15	24.12
16.8	6765	951+28.57 0.0	XG-2.5-08-25-15	24.12
16.7	6764	950+73.07 0.0	XG-2.5-08-25-15	24.12
16.6	6763	950+17.57 0.0	XG-2.5-08-25-15	24.12
16.5	6762	949+62.07 0.0	XG-2.5-08-25-15	24.12
16.5	6761	949+06.57 0.0	XG-2.5-08-25-15	24.12
16.6	6760	948+51.07 0.0	XG-2.5-08-25-15	24.12
16.6	6759	947+95.57 0.0	XA-2.5-18-30-20	24.12
16.6	6758	947+40.07 0.0	XG-2.5-08-25-15	24.12
16.1	6757	946+84.57 0.0	XG-2.5-08-25-15	24.12
15.9	6756	946+29.07 0.0	XG-2.5-08-25-15	24.12
16.2	6755	945+73.57 0.0	XG-2.5-08-25-15	24.12
16.5	6754	945+18.07 0.0	XG-2.5-08-25-15	24.12
16.6	6753	944+62.57 0.0	XG-2.5-08-25-15	24.17
16.6	6752	944+07.07 0.0	XG-2.5-08-25-15	24.26
16.7	6751	943+51.57 0.0	XG-2.5-08-25-15	24.34
16.8	6750	942+96.07 0.0	XG-2.5-08-25-15	24.42
16.8	6749	942+40.57 0.0	XG-2.5-08-25-15	24.51
16.7	6748	941+85.07 0.0	XG-2.5-08-25-15	24.59
16.7	6747	941+29.57 0.0	XG-2.5-08-25-15	24.67
16.7	6746	940+74.07 0.0	XG-2.5-08-25-15	24.75
16.8	6745	940+18.57 0.0	XG-2.5-08-25-15	24.84
17.1	6744	939+63.07 0.0	XG-2.5-08-25-15	24.92
17.2	6743	939+07.57 0.0	XG-2.5-08-25-15	25.01

REFERENCE DRAWINGS	DESCRIPTION
USPT-WP-YDSYM-060001	PROJECT NOTES, ABBREVIATIONS AND LEGEND
USPT-WP-YDPAL-060001	SITE PLAN
USPT-WP-YDDET-060001	TYPICAL EXPANSION LOOP DETAIL
USPT-WP-YDDET-060010	GUIDED AND ANCHORED SUPPORT DETAILS
USPT-WP-YDDET-060011	SLIDING SUPPORT DETAILS
USPT-WP-YDWW-060001	WIND-INDUCED VIBRATION MITIGATION PLAN




REV	DATE	DESCRIPTION	BY	CHK	APPD	PROJ
10	12/28/11	ISSUED FOR CONSTRUCTION	RPH	JAG	PAC	GMP



EXPORT PIPELINE - PIPELINE ALIGNMENT SHEET PLAN & PROFILE				ALASKA	
STA 939+00 TO STA 969+00					
POINT THOMSON	MODULE	DRAWN	DATE	SCALE	AS SHOWN
		R. HOBBS	12/11		
DRAWING NO.	USPT-WP-YDPAL-060032-001		SHEET	1 of 1	REV
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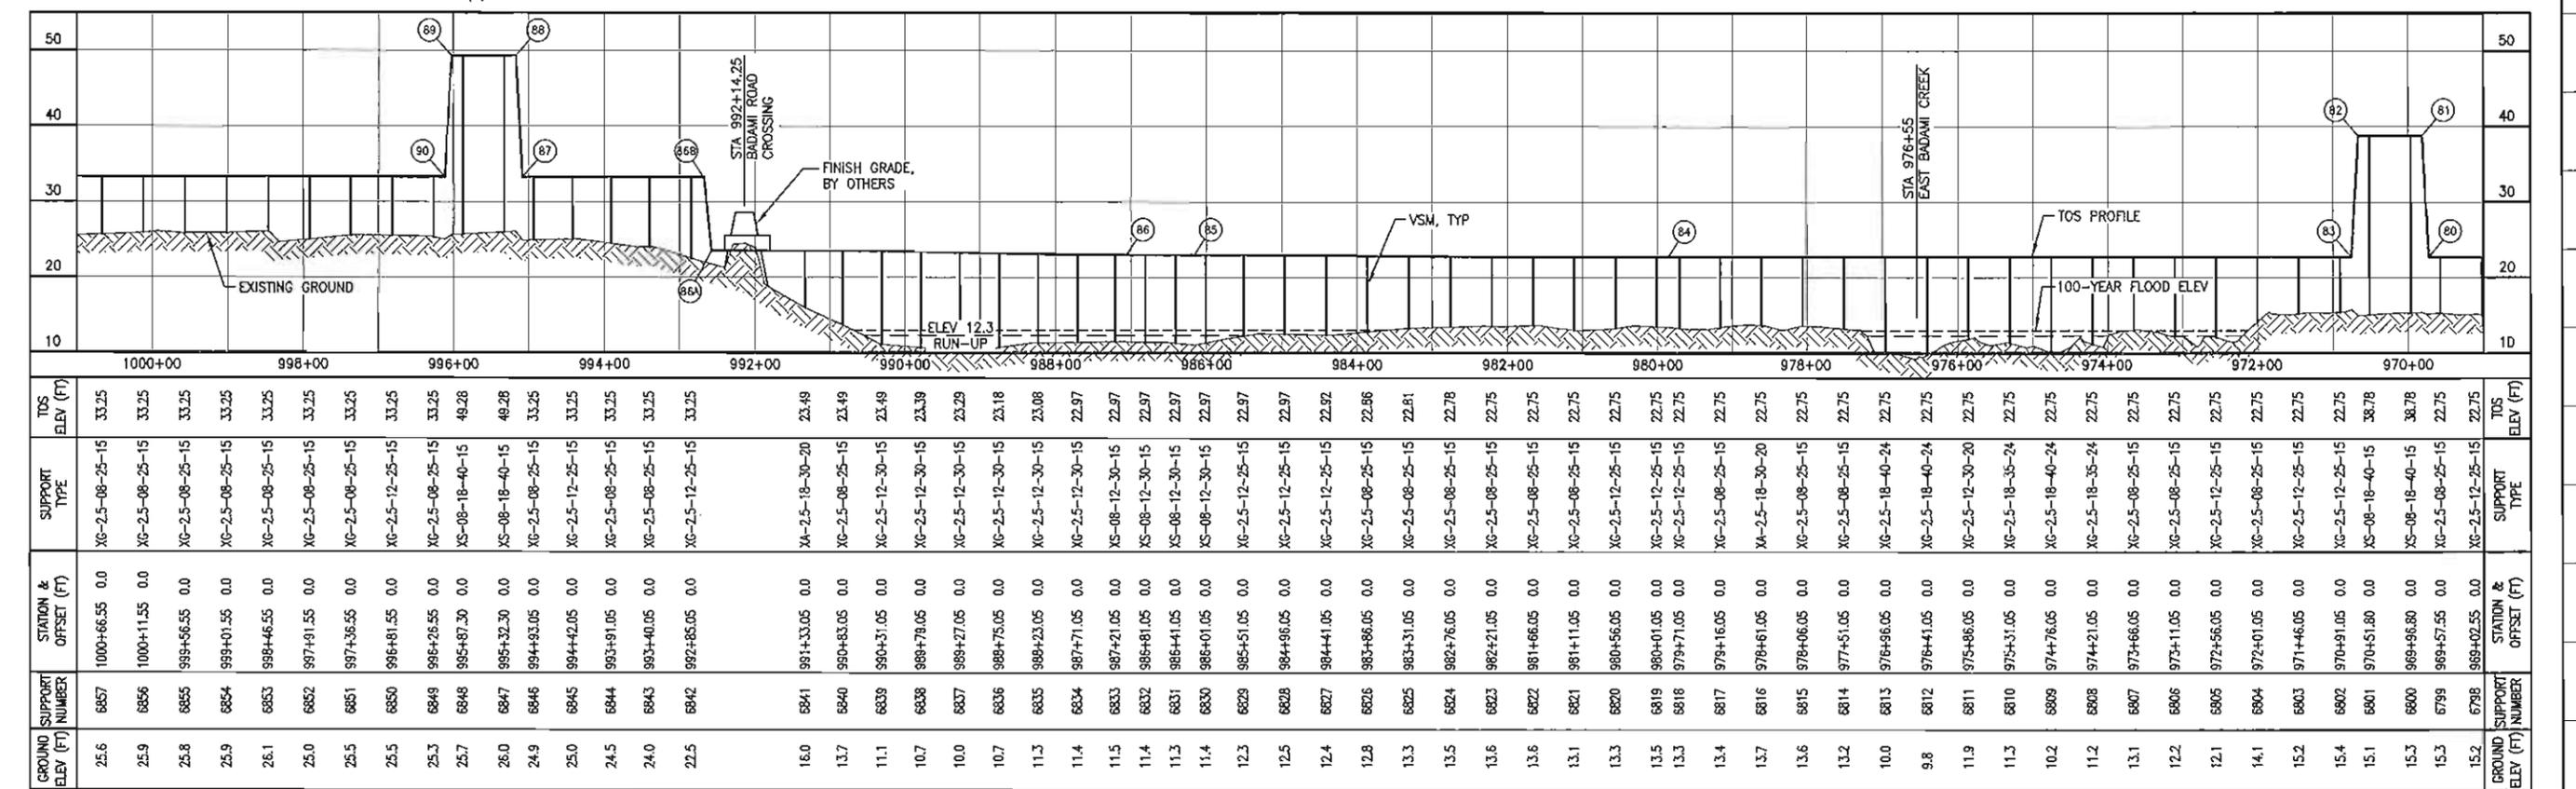
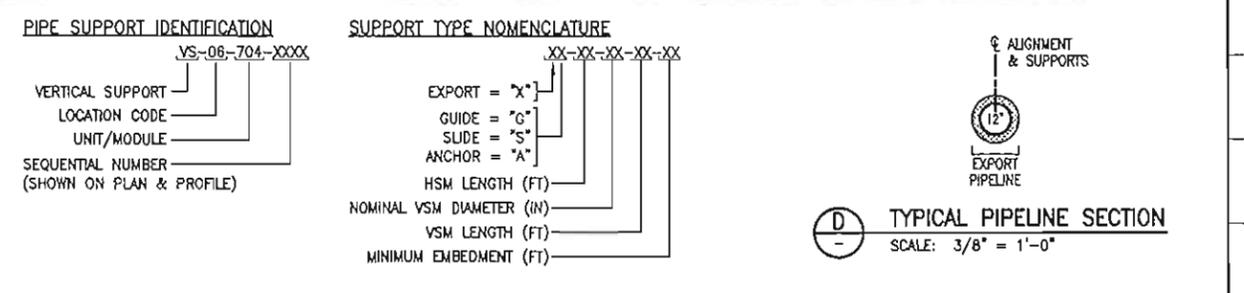
COORDINATE TABLE					
POINT #	DESCRIPTION	STATION	NORTHING	EASTING	ANGLE
80	PI/VP	969+72.55	5899665.21	1517020.64	90.0° (R)
81	PI/VP	969+61.80	5899674.07	1517017.98	90.0° (R)
82	PI/VP	970+66.80	5899649.58	1516936.59	90.0° (R)
83	PI/VP	970+76.05	5899640.72	1516939.25	90.0° (R)
84	PI	979+86.05	5899378.46	1516067.86	13.0°
85	PI	986+16.05	5899337.26	1515439.21	72.5°
86	PI	987+06.05	5899421.14	1515406.59	90.0°
86A	VPI	992+58.13	5899221.04	1514892.04	45.0°
86B	VPI	992+67.81	5899217.53	1514883.03	45.0°
87	PI/VP	995+08.05	5899130.46	1514659.12	90.0° (R)
88	PI/VP	995+17.30	5899121.84	1514662.47	90.0° (R)
89	PI/VP	996+02.30	5899091.03	1514583.25	90.0° (R)
90	PI/VP	996+11.55	5899099.65	1514579.90	90.0° (R)

(R) ANGLE = ROLLED

PIPELINE DATA TABLE				
LOCATION	MATERIAL	WALL THK (IN)	FBE COATING (MIL)	INSULATION (IN)
969+00 TO 1001+00	12.75" OIA API 5L X65	0.406	SHOP: 20 MIN, 32 MAX FIELD: 25 MIN, 39 MAX	3.0

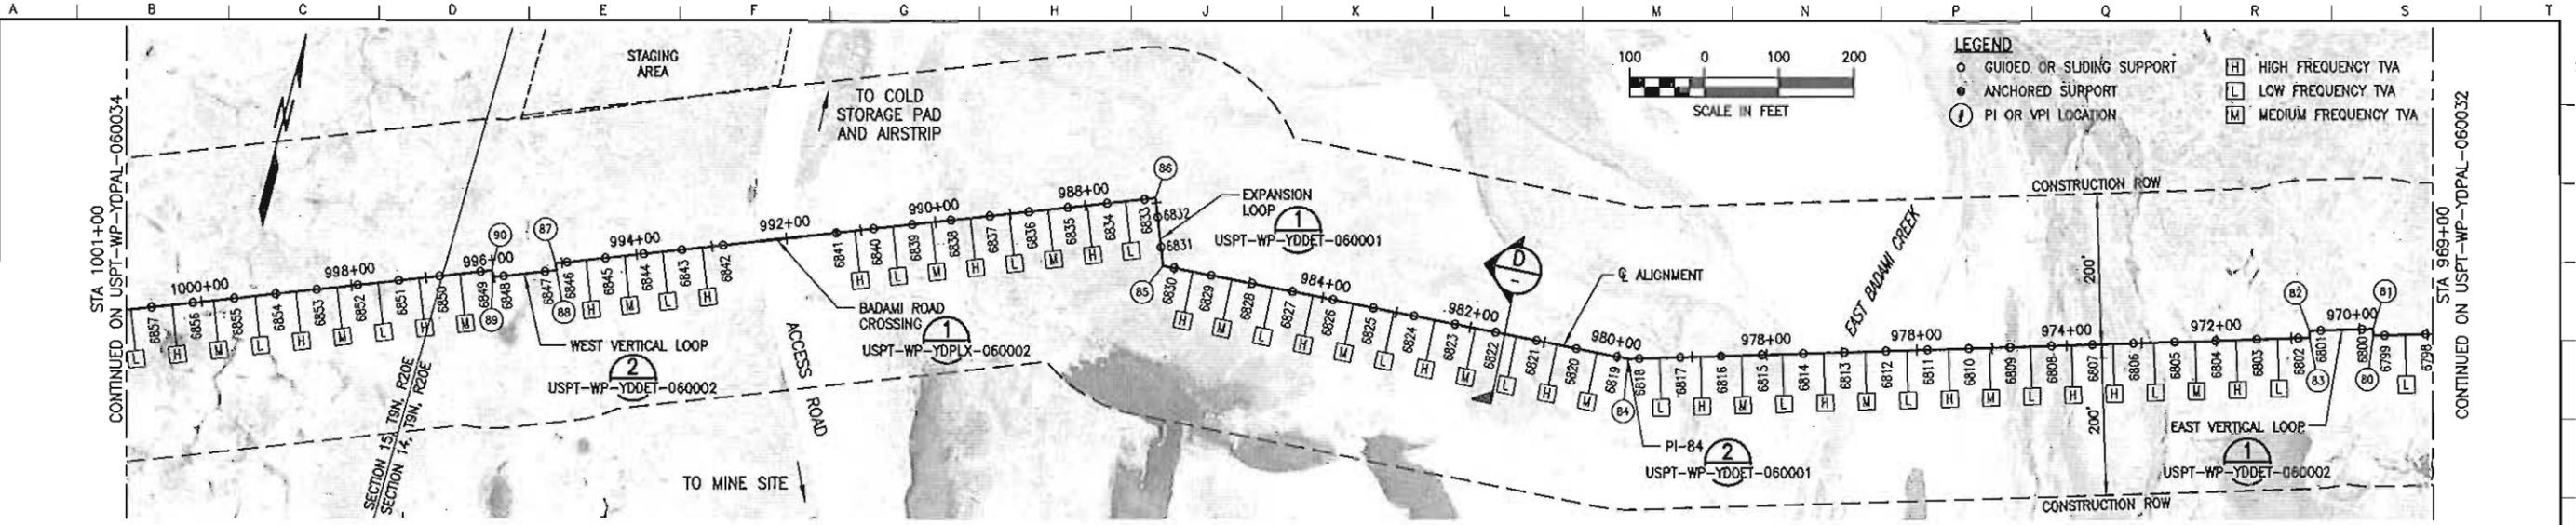NOTES

- CENTERLINE OF ALIGNMENT = CENTERLINE OF 12"-LN-644-0049-MEBEV-3"H.
- STATIONING ALONG ALIGNMENT REFLECTS HORIZONTAL DISTANCE.
- HORIZONTAL DATUM IS NAD83, ALASKA STATE PLANE ZONE 3, US FOOT.
- VERTICAL DATUM IS POINT THOMSON UNIT MEAN LOWER LOW WATER (PTU MLLW).
- FOR GUIDED AND ANCHORED SUPPORT DETAILS, SEE USPT-WP-YDDET-060010.
- FOR SLIDING SUPPORT DETAILS, SEE USPT-WP-YDDET-060011.
- FOR WIND-INDUCED VIBRATION MITIGATION PLAN AND TUNED VIBRATION ABSORBER (TVA) INSTALLATION, SEE USPT-WP-YDWRV-060001.



REFERENCE DRAWINGS	DESCRIPTION
USPT-WP-YDSTM-060001	PROJECT NOTES, ABBREVIATIONS AND LEGEND
USPT-WP-YDPAL-060001	SITE PLAN
USPT-WP-YDDET-060001	TYPICAL EXPANSION LOOP DETAIL
USPT-WP-YDDET-060010	GUIDED AND ANCHORED SUPPORT DETAILS
USPT-WP-YDDET-060011	SLIDING SUPPORT DETAILS
USPT-WP-YDDET-060002	VERTICAL LOOP DETAILS
USPT-WP-YDPLX-060002	ROAD CROSSING PLAN AND SECTION BADAMI ACCESS ROAD



REV	DATE	DESCRIPTION	BY	CHK	APPD	PROJ
10	12/28/11	ISSUED FOR CONSTRUCTION	RTH	JWG	PAC	GMP

ExxonMobil Development

WorleyParsons FLUOR Baker

EXPORT PIPELINE - PIPELINE PIPELINE ALIGNMENT SHEET PLAN & PROFILE STA 969+00 TO STA 1001+00


POINT THOMSON, ALASKA

MODULE: R. HOBBS DATE: 12/11 SCALE: AS SHOWN

DRAWING NO. USPT-WP-YDPAL-060033-001 SHEET 1 OF 10

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FILENAME: USPT-WP-YDPAL-060033-001

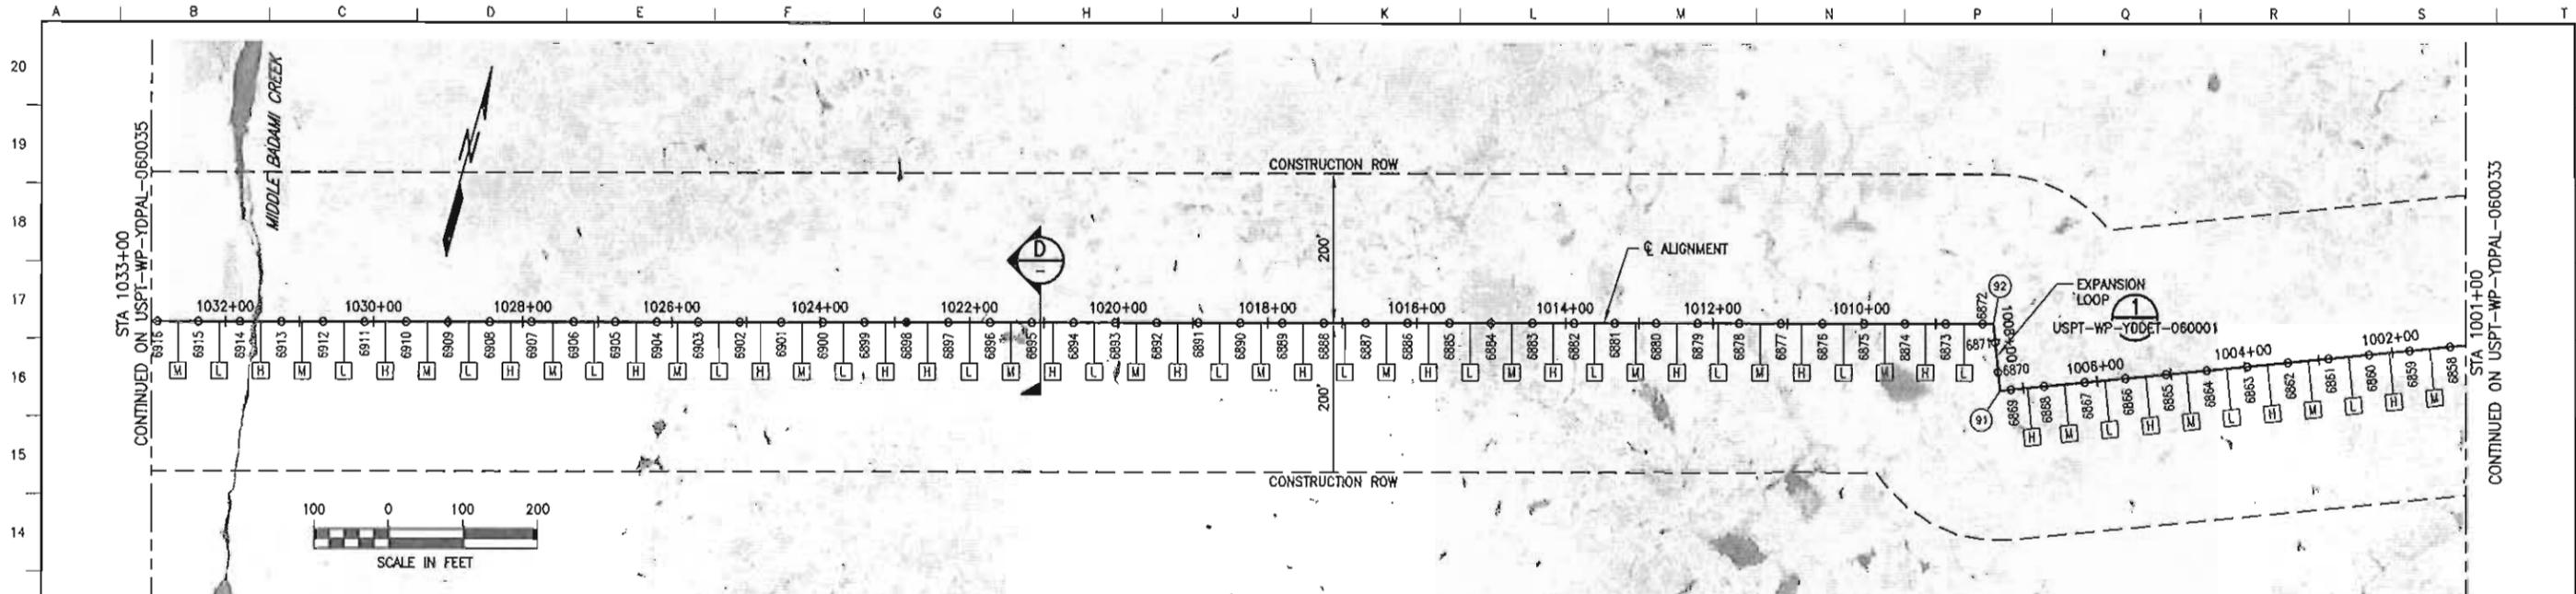

LOCATION	MATERIAL	WALL THK (IN)	FBE COATING (MIL)	INSULATION (IN)
1001+00 TO 1033+00	12.75" OIA API 5L X65	0.406	SHOP: 20 MIN, 32 MAX FIELD: 25 MIN, 39 MAX	3.0

POINT #	DESCRIPTION	STATION	NORTHING	EASTING	ANGLE
91	PI	1007+31.55	5898693.72	1513536.05	90.0°
92	PI	1008+21.55	5898777.60	1513503.43	84.5°

PIPE SUPPORT IDENTIFICATION
 VERTICAL SUPPORT
 LOCATION CODE
 UNIT/MODULE
 SEQUENTIAL NUMBER (SHOWN ON PLAN & PROFILE)



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 EXPORT = "X"
 GUIDE = "G"
 SUDE = "S"
 ANCHOR = "A"
 HSM LENGTH (FT)
 NOMINAL VSM DIAMETER (IN)
 VSM LENGTH (FT)
 MINIMUM EMBEDMENT (FT)

NOTES

- CENTERLINE OF ALIGNMENT = CENTERLINE OF 12"-LN-644-0049-ME8EV-3'H.
- STATIONING ALONG ALIGNMENT REFLECTS HORIZONTAL DISTANCE.
- HORIZONTAL DATUM IS NAD83, ALASKA STATE PLANE ZONE 3, US FOOT.
- VERTICAL DATUM IS POINT THOMSON UNIT MEAN LOWER LOW WATER (PTU MLW).
- FOR GUIDED AND ANCHORED SUPPORT DETAILS, SEE USPT-WP-YODET-060010.
- FOR SLIDING SUPPORT DETAILS, SEE USPT-WP-YODET-060011.
- FOR WIND-INDUCED VIBRATION MITIGATION PLAN AND TUNED VIBRATION ABSORBER (TVA) INSTALLATION, SEE USPT-WP-YDWM-060001.

LEGEND

- GUIDED OR SLIDING SUPPORT
- ANCHORED SUPPORT
- ⊙ PI OR VPI LOCATION
- H HIGH FREQUENCY TVA
- L LOW FREQUENCY TVA
- M MEDIUM FREQUENCY TVA

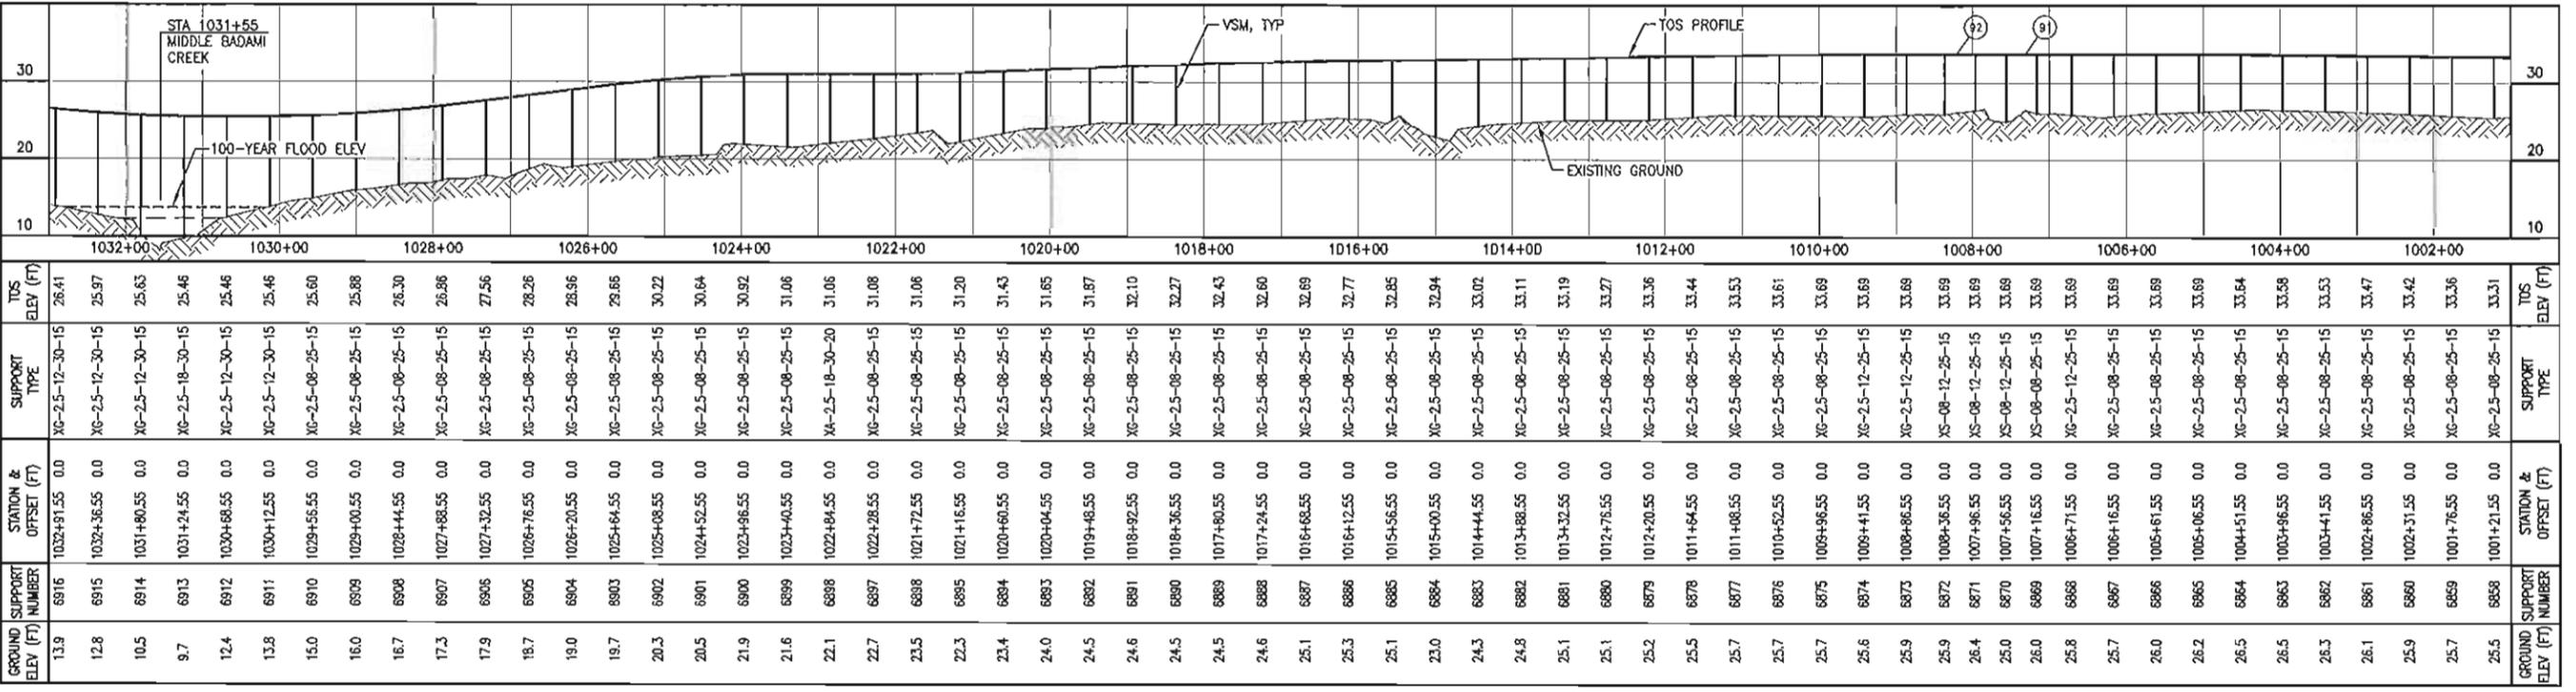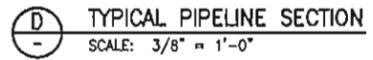

REFERENCE DRAWINGS	DESCRIPTION
USPT-WP-YDSM-060001	PROJECT NOTES, ABBREVIATIONS AND LEGEND
USPT-WP-YDPAL-060001	SITE PLAN
USPT-WP-YDDET-060001	TYPICAL EXPANSION LOOP DETAIL
USPT-WP-YDDET-060010	GUIDED AND ANCHORED SUPPORT DETAILS
USPT-WP-YDDET-060011	SLIDING SUPPORT DETAILS
USPT-WP-YDWM-060001	WIND-INDUCED VIBRATION MITIGATION PLAN



REV	DATE	DESCRIPTION	BY	CHK	APPRO	PROJ
10	12/28/11	ISSUED FOR CONSTRUCTION	RPH	JAG	PAC	GMP




EXPORT PIPELINE - PIPELINE PIPELINE ALIGNMENT SHEET PLAN & PROFILE STA 1001+00 TO STA 1033+00			
MODULE	DRAWN	DATE	SCALE
R. HOBBS	12/11	AS SHOWN	
POINT THOMSON ALASKA			
MODULE	DRAWN	DATE	SCALE
R. HOBBS	12/11	AS SHOWN	
DRAWING NO. USPT-WP-YDPAL-060034-001			
CHK	APPD	JWO	REV
			10
			1 of 1

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FILENAME: USPT-WP-YDPAL-060034-001

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PIPELINE DATA TABLE				
LOCATION	MATERIAL	WALL THK (IN)	FBE COATING (MIL)	INSULATION (IN)
1033+00 TO 1061+00	12.75" OIA API 5L X65	0.406	SHOP: 20 MIN, 32 MAX FIELD: 25 MIN, 39 MAX	3.0



COORDINATE TABLE					
POINT #	DESCRIPTION	STATION	NORTHING	EASTING	ANGLE
93	PI	1038+51.55	5898009.43	1510779.68	90.0°
94	PI	1037+41.55	5898096.05	1510755.25	90.0°
95	PI	1050+31.55	5897745.89	1509513.69	46.5°

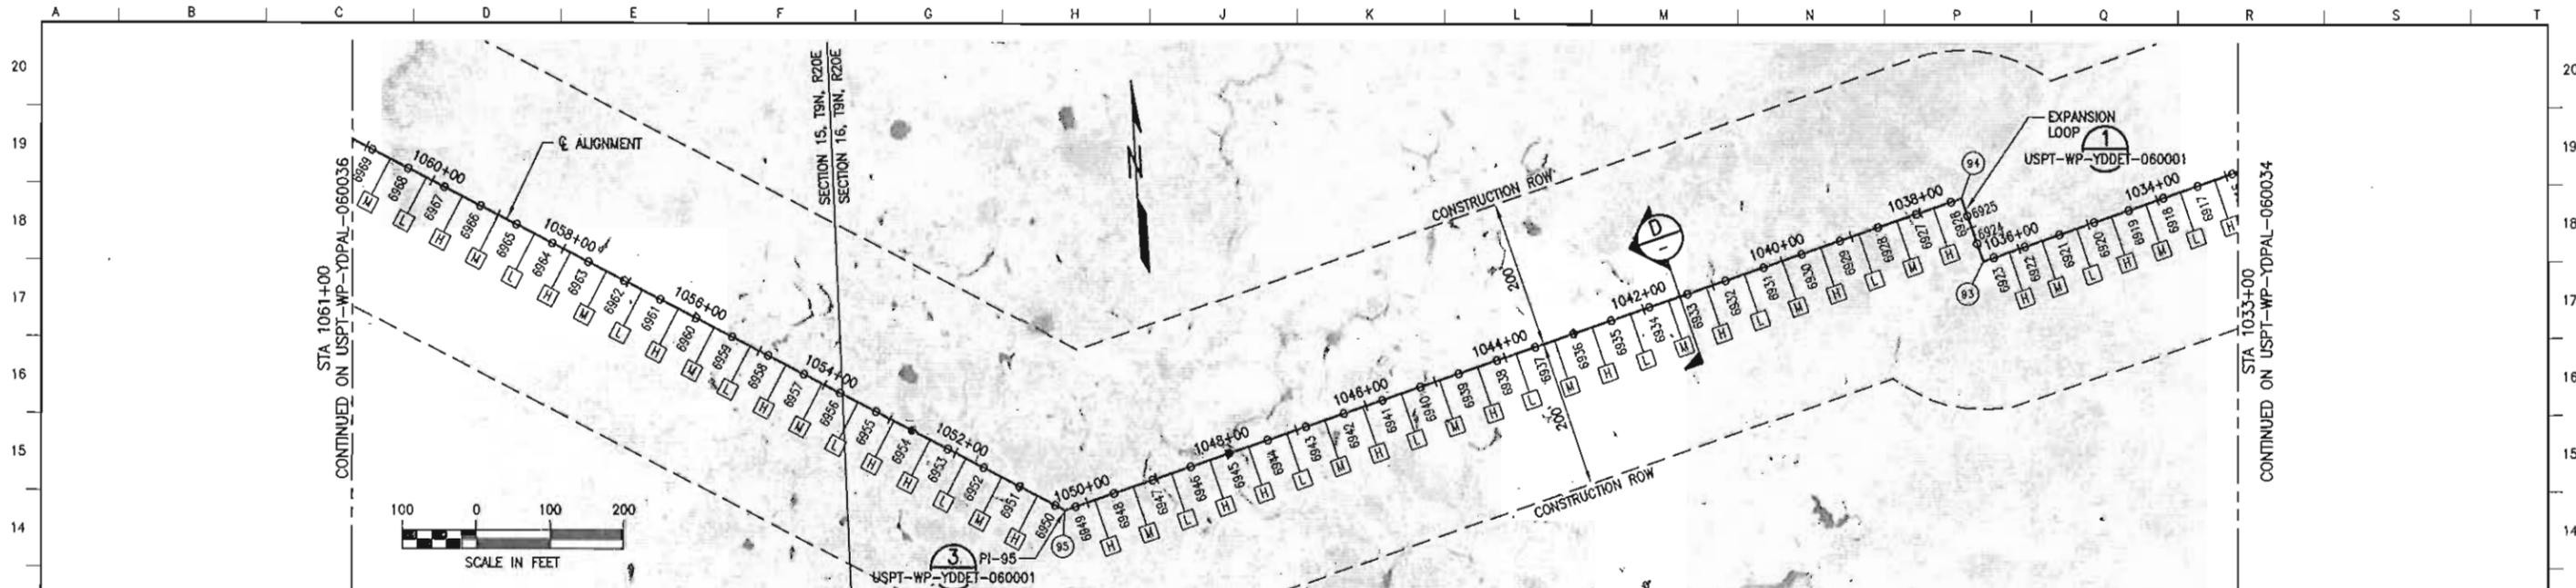PIPE SUPPORT IDENTIFICATION
 VS-06-704-XXXX
 VERTICAL SUPPORT
 LOCATION CODE
 UNIT/MODULE
 SEQUENTIAL NUMBER
 (SHOWN ON PLAN & PROFILE)

SUPPORT TYPE NOMENCLATURE
 XX-XX-XX-XX-XX
 EXPORT = "X"
 GUIDE = "G"
 SLIDE = "S"
 ANCHOR = "A"
 HSM LENGTH (FT)
 NOMINAL VSM DIAMETER (IN)
 VSM LENGTH (FT)
 MINIMUM EMBEDMENT (FT)

NOTES
 1. CENTERLINE OF ALIGNMENT = CENTERLINE OF 12"-LN-644-0049-WE6EV-37H.
 2. STATIONING ALONG ALIGNMENT REFLECTS HORIZONTAL DISTANCE.
 3. HORIZONTAL DATUM IS NAD83, ALASKA STATE PLANE ZONE 3, US FOOT.
 4. VERTICAL DATUM IS POINT THOMSON UNIT MEAN LOWER LOW WATER (PTU MLW).
 5. FOR GUIDED AND ANCHORED SUPPORT DETAILS, SEE USPT-WP-YDDET-060010.
 6. FOR SLIDING SUPPORT DETAILS, SEE USPT-WP-YDDET-060011.
 7. FOR WIND-INDUCED VIBRATION MITIGATION PLAN AND TUNED VIBRATION ABSORBER (TVA) INSTALLATION, SEE USPT-WP-YDWMV-D60001.

LEGEND
 ○ GUIDED OR SLIDING SUPPORT
 ● ANCHORED SUPPORT
 ⊙ PI OR VPI LOCATION
 □ HIGH FREQUENCY TVA
 □ LOW FREQUENCY TVA
 □ MEDIUM FREQUENCY TVA

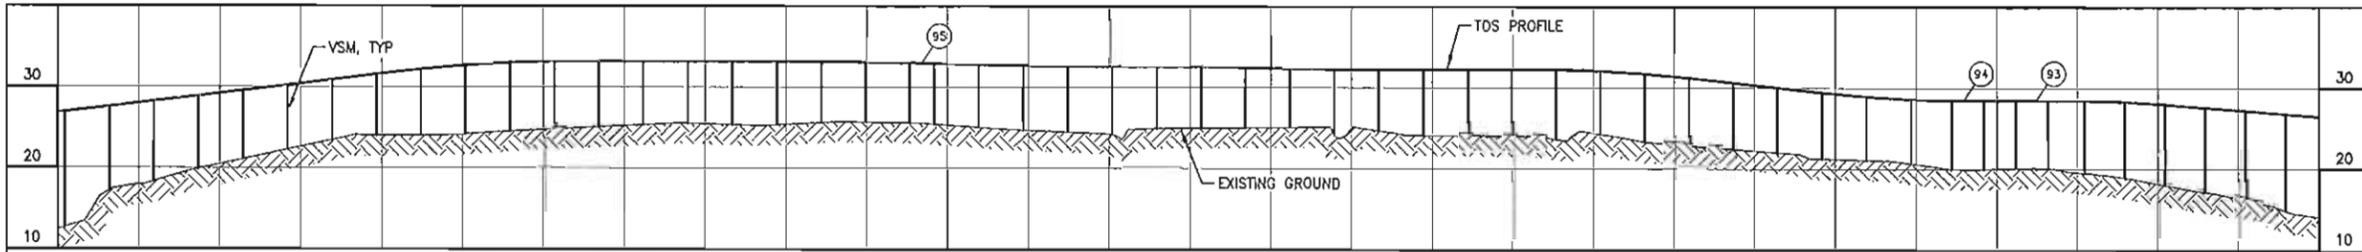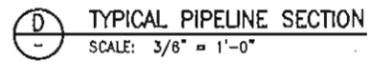

GROUND SUPPORT ELEV (FT)	SUPPORT NUMBER	STATION & OFFSET (FT)	SUPPORT TYPE	TOS ELEV (FT)
12.7	6969	1060+91.55 0.0	XG-2.5-12-30-15	26.91
17.2	6968	1060+36.55 0.0	XG-2.5-08-25-15	27.57
18.4	6967	1059+81.55 0.0	XG-2.5-08-25-15	28.23
19.9	6966	1059+26.55 0.0	XG-2.5-08-25-15	28.89
21.1	6965	1059+71.55 0.0	XG-2.5-08-25-15	29.55
22.3	6964	1058+16.55 0.0	XG-2.5-08-25-15	30.21
23.5	6963	1057+61.55 0.0	XG-2.5-08-25-15	30.87
24.0	6962	1057+06.55 0.0	XG-2.5-08-25-15	31.53
24.0	6961	1056+51.55 0.0	XG-2.5-08-25-15	32.19
24.2	6960	1056+96.55 0.0	XG-2.5-08-25-15	32.86
24.6	6959	1055+41.55 0.0	XG-2.5-08-25-15	33.01
24.8	6958	1054+86.55 0.0	XG-2.5-08-25-15	33.18
25.1	6957	1054+31.55 0.0	XG-2.5-08-25-15	33.18
25.4	6956	1053+76.55 0.0	XG-2.5-08-25-15	33.18
25.6	6955	1053+21.55 0.0	XG-2.5-08-25-15	33.18
25.4	6954	1052+66.55 0.0	XA-2.5-18-30-20	33.18
25.4	6953	1052+11.55 0.0	XG-2.5-08-25-15	33.18
25.6	6952	1051+56.55 0.0	XG-2.5-08-25-15	33.18
25.7	6951	1051+01.55 0.0	XG-2.5-12-25-15	33.07
25.6	6950	1050+46.55 0.0	XS-08-12-25-15	32.96
25.5	6949	1050+16.55 0.0	XS-08-12-25-15	32.90
25.1	6948	1049+61.55 0.0	XG-2.5-12-25-15	32.79
24.7	6947	1049+06.55 0.0	XG-2.5-12-25-15	32.68
24.5	6946	1048+51.55 0.0	XG-2.5-08-25-15	32.57
24.2	6945	1047+96.55 0.0	XA-2.5-18-30-20	32.57
25.0	6944	1047+41.55 0.0	XG-2.5-08-25-15	32.57
25.0	6943	1046+86.55 0.0	XG-2.5-08-25-15	32.46
25.0	6942	1046+31.55 0.0	XG-2.5-08-25-15	32.35
25.1	6941	1045+76.55 0.0	XG-2.5-08-25-15	32.24
24.2	6940	1045+21.55 0.0	XG-2.5-08-25-15	32.24
24.7	6939	1044+66.55 0.0	XG-2.5-08-25-15	32.24
24.1	6938	1044+11.55 0.0	XG-2.5-08-25-15	32.24
24.1	6937	1043+56.55 0.0	XG-2.5-08-25-15	32.24
24.0	6936	1043+01.55 0.0	XG-2.5-08-25-15	32.24
23.6	6935	1042+46.55 0.0	XG-2.5-08-25-15	32.24
24.3	6934	1041+91.55 0.0	XG-2.5-08-25-15	32.07
23.4	6933	1041+36.55 0.0	XG-2.5-08-25-15	31.74
22.9	6932	1040+81.55 0.0	XG-2.5-08-25-15	31.25
22.5	6931	1040+26.55 0.0	XG-2.5-08-25-15	30.64
22.0	6930	1039+71.55 0.0	XG-2.5-08-25-15	30.04
21.3	6929	1039+16.55 0.0	XG-2.5-08-25-15	29.43
21.1	6928	1038+61.55 0.0	XG-2.5-12-25-15	28.94
20.7	6927	1038+06.55 0.0	XG-2.5-12-25-15	28.61
20.0	6926	1037+56.55 0.0	XS-08-12-25-15	28.46
20.0	6925	1037+16.55 0.0	XS-08-12-25-15	28.46
20.2	6924	1036+66.55 0.0	XS-08-12-25-15	28.46
20.1	6923	1036+16.55 0.0	XS-08-12-25-15	28.46
19.5	6922	1035+61.55 0.0	XG-2.5-12-25-15	28.46
18.9	6921	1035+11.55 0.0	XG-2.5-12-25-15	28.31
18.0	6920	1034+61.55 0.0	XG-2.5-08-25-15	28.01
17.2	6919	1034+11.55 0.0	XG-2.5-08-25-15	27.61
16.2	6918	1033+61.55 0.0	XG-2.5-08-25-15	27.21
14.9	6917	1033+11.55 0.0	XG-2.5-08-30-15	26.81

REFERENCE DRAWINGS	DESCRIPTION
USPT-WP-YDSYM-060001	PROJECT NOTES, ABBREVIATIONS AND LEGEND
USPT-WP-YDPAL-060001	SITE PLAN
USPT-WP-YDDET-060001	TYPICAL EXPANSION LOOP DETAIL
USPT-WP-YDDET-060010	GUIDED AND ANCHORED SUPPORT DETAILS
USPT-WP-YDDET-060011	SLIDING SUPPORT DETAILS
USPT-WP-YDWMV-060001	WIND-INDUCED VIBRATION MITIGATION PLAN



REV	DATE	DESCRIPTION	BY	CHK	APPD	PROJ
10	12/28/11	ISSUED FOR CONSTRUCTION	RPH	JAG	PAC	GMP


ExxonMobil Development

WorleyParsons FLUOR. Baker

EXPORT PIPELINE - PIPELINE ALIGNMENT SHEET PLAN & PROFILE STA 1033+00 TO STA 1061+00			
POINT THOMSON	ALASKA	SCALE	AS SHOWN
MODULE	DRAWN	DATE	12/11
R. HOBBS			
DRAWING NO.	USPT-WP-YDPAL-060035-001	SHEET	1 OF 1

FILENAME: USPT-WP-YDPAL-060035-001

T:\122263 - Point Thomson EPC03 - CADD01 - Export\USPT-WP-YDPAL-060036.dwg, 36, 1/24/2011 11:41:01 AM, Jambum

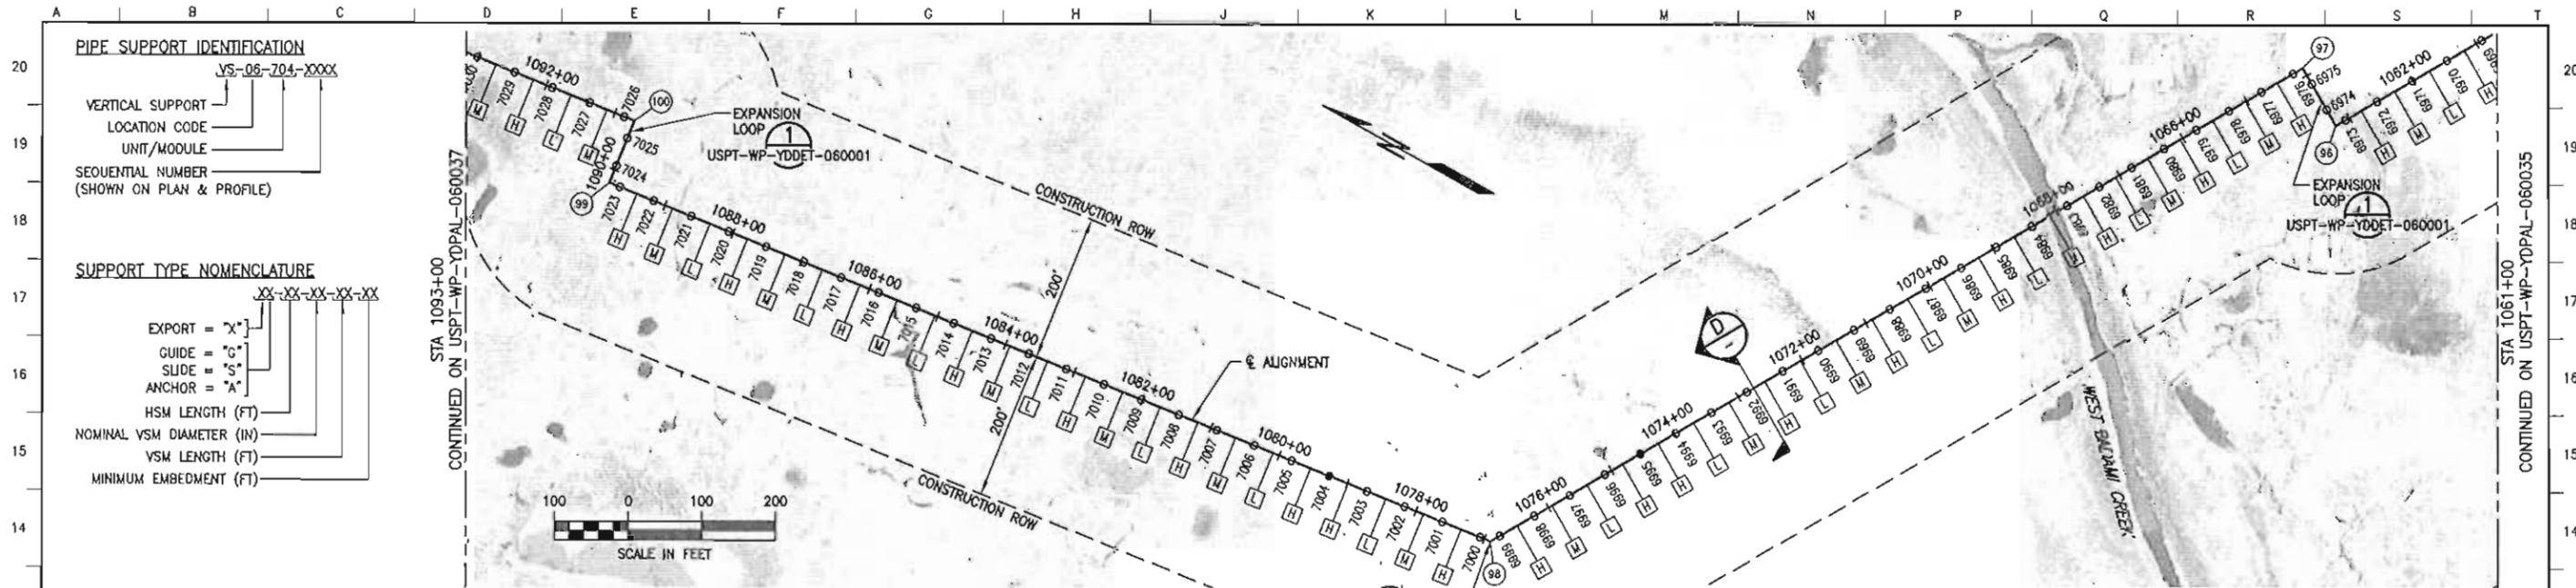

PIPE SUPPORT IDENTIFICATION
 VS-06-704-XXXX
 VERTICAL SUPPORT
 LOCATION CODE
 UNIT/MODULE
 SEQUENTIAL NUMBER
 (SHOWN ON PLAN & PROFILE)

SUPPORT TYPE NOMENCLATURE
 XX-XX-XX-XX-XX
 EXPORT = "X"
 GUIDE = "G"
 SLIDE = "S"
 ANCHOR = "A"
 HSM LENGTH (FT)
 NOMINAL VSM DIAMETER (IN)
 VSM LENGTH (FT)
 MINIMUM EMBEDMENT (FT)

PIPELINE DATA TABLE



LOCATION	MATERIAL	WALL THK (IN)	FBE COATING (MIL)	INSULATION (IN)
1061+00 TO 1093+00	12.75" DIA API 5L X65	0.406	SHOP: 20 MIN, 32 MAX FIELD: 25 MIN, 39 MAX	3.0

COORDINATE TABLE

POINT #	DESCRIPTION	STATION	NORTHING	EASTING	ANGLE
96	PI	1063+21.55	5898405.46	1508405.05	90.0°
97	PI	1064+11.55	5898482.80	1508451.07	90.0°
98	PI	1076+91.55	5899137.26	1507351.03	52.0°
99	PI	1089+81.55	5900416.95	1507188.23	90.0°
100	PI	1090+71.55	5900428.30	1507277.51	90.0°

- NOTES**
- CENTERLINE OF ALIGNMENT = CENTERLINE OF 12"-LN-644-0049-ME6EV-3"H.
 - STATIONING ALONG ALIGNMENT REFLECTS HORIZONTAL DISTANCE.
 - HORIZONTAL DATUM IS NAD83, ALASKA STATE PLANE ZONE 3, US FOOT.
 - VERTICAL DATUM IS POINT THOMSON UNIT MEAN LOWER LOW WATER (PTU MLW).
 - FOR GUIDED AND ANCHORED SUPPORT DETAILS, SEE USPT-WP-YDDET-060010.
 - FOR SLIDING SUPPORT DETAILS, SEE USPT-WP-YDDET-060011.
 - FOR WIND-INDUCED VIBRATION MITIGATION PLAN AND TUNED VIBRATION ABSORBER (TVA) INSTALLATION, SEE USPT-WP-YDWV-060001.

- LEGEND**
- GUIDED OR SLIDING SUPPORT
 - ANCHORED SUPPORT
 - ⊙ PI OR VPI LOCATION
 - ⊠ HIGH FREQUENCY TVA
 - ⊡ LOW FREQUENCY TVA
 - ⊞ MEDIUM FREQUENCY TVA

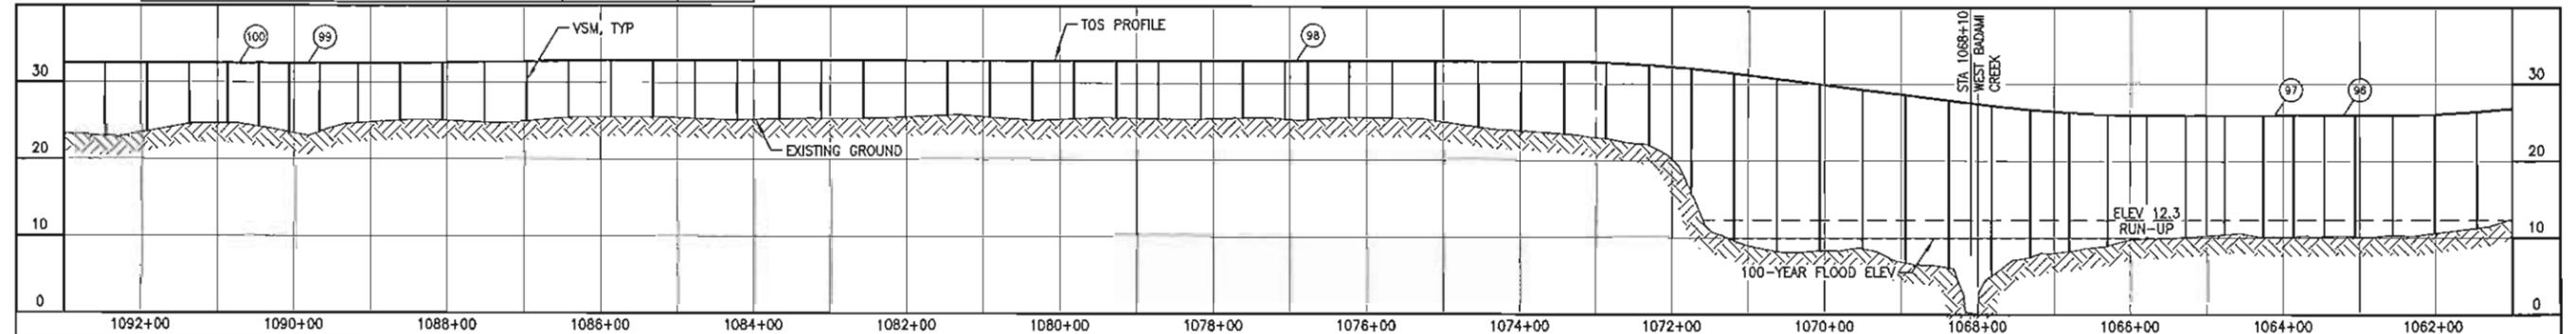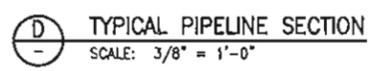

GROUND ELEV (FT)	SUPPORT NUMBER	STATION & OFFSET (FT)	SUPPORT TYPE	TOS ELEV (FT)
23.0	7029	1092+46.55 0.0	XG-2.5-12-25-15	32.49
23.6	7028	1091+91.55 0.0	XG-2.5-12-25-15	32.49
24.6	7027	1091+36.55 0.0	XG-2.5-12-25-15	32.49
24.6	7026	1090+86.55 0.0	XS-08-12-25-15	32.49
24.2	7025	1090+46.55 0.0	XS-08-12-25-15	32.49
23.5	7024	1090+06.55 0.0	XS-08-12-25-15	32.49
23.6	7023	1089+56.55 0.0	XS-08-12-25-15	32.49
24.7	7022	1089+16.55 0.0	XG-2.5-12-25-15	32.49
25.0	7021	1088+61.55 0.0	XG-2.5-12-25-15	32.49
25.1	7020	1088+06.55 0.0	XG-2.5-08-25-15	32.57
24.8	7019	1087+51.55 0.0	XG-2.5-08-25-15	32.66
25.0	7018	1086+96.55 0.0	XG-2.5-08-25-15	32.74
25.4	7017	1086+41.55 0.0	XG-2.5-08-25-15	32.82
25.5	7016	1085+86.55 0.0	XG-2.5-08-25-15	32.90
25.6	7015	1085+31.55 0.0	XG-2.5-08-25-15	32.90
25.3	7014	1084+76.55 0.0	XG-2.5-08-25-15	32.90
25.2	7013	1084+21.55 0.0	XG-2.5-08-25-15	32.90
25.3	7012	1083+66.55 0.0	XG-2.5-08-25-15	32.90
25.4	7011	1083+11.55 0.0	XG-2.5-08-25-15	32.90
25.4	7010	1082+56.55 0.0	XG-2.5-08-25-15	32.90
25.6	7009	1082+01.55 0.0	XG-2.5-08-25-15	32.90
25.8	7008	1081+46.55 0.0	XA-2.5-18-30-20	32.90
25.6	7007	1080+91.55 0.0	XG-2.5-08-25-15	32.90
25.2	7006	1080+36.55 0.0	XG-2.5-08-25-15	32.90
25.3	7005	1079+81.55 0.0	XG-2.5-08-25-15	32.90
25.5	7004	1079+26.55 0.0	XA-2.5-18-30-20	32.90
25.4	7003	1078+71.55 0.0	XG-2.5-08-25-15	32.90
25.3	7002	1078+16.55 0.0	XG-2.5-12-25-15	32.90
25.5	7001	1077+61.55 0.0	XG-2.5-12-25-15	32.90
25.3	7000	1077+06.55 0.0	XS-08-12-25-15	32.90
25.3	6999	1076+51.55 0.0	XS-08-12-25-15	32.90
25.6	6998	1076+22.55 0.0	XG-2.5-12-25-15	32.90
25.5	6997	1075+66.55 0.0	XG-2.5-08-25-15	32.90
25.2	6996	1075+10.55 0.0	XG-2.5-08-25-15	32.90
24.4	6995	1074+54.55 0.0	XA-2.5-18-30-20	32.90
23.9	6994	1073+98.55 0.0	XG-2.5-08-25-15	32.90
23.5	6993	1073+42.55 0.0	XG-2.5-08-25-15	32.90
22.9	6992	1072+86.55 0.0	XG-2.5-08-25-15	32.76
22.0	6991	1072+30.55 0.0	XG-2.5-08-25-15	32.46
15.9	6990	1071+74.55 0.0	XG-2.5-12-35-15	32.01
9.6	6989	1071+18.55 0.0	XG-2.5-18-40-15	31.39
8.2	6988	1070+62.55 0.0	XG-2.5-18-40-15	30.69
8.4	6987	1070+06.55 0.0	XG-2.5-18-40-15	29.99
8.6	6986	1069+50.55 0.0	XG-2.5-12-35-15	29.29
6.7	6985	1068+94.55 0.0	XG-2.5-18-40-15	28.59
6.1	6984	1068+38.55 0.0	XG-2.5-18-40-15	27.89
5.1	6983	1067+82.55 0.0	XG-2.5-18-40-15	27.19
7.5	6982	1067+26.55 0.0	XG-2.5-12-35-15	26.68
8.2	6981	1066+70.55 0.0	XG-2.5-12-35-15	26.30
9.0	6980	1066+14.55 0.0	XG-2.5-12-35-15	26.04
9.9	6979	1065+58.55 0.0	XG-2.5-12-30-15	25.92
10.1	6978	1065+02.55 0.0	XG-2.5-12-30-15	25.92
10.4	6977	1064+46.55 0.0	XG-2.5-18-30-15	25.92
10.2	6976	1064+06.55 0.0	XS-08-12-30-15	25.92
10.1	6975	1063+50.55 0.0	XS-08-12-30-15	25.92
10.2	6974	1063+06.55 0.0	XS-08-12-30-15	25.92
10.2	6973	1062+50.55 0.0	XS-08-12-30-15	25.92
10.3	6972	1062+06.55 0.0	XG-2.5-18-30-15	25.92
10.6	6971	1062+01.55 0.0	XG-2.5-12-30-15	26.08
11.3	6970	1061+46.55 0.0	XG-2.5-12-30-15	26.41

REFERENCE DRAWINGS

DESCRIPTION	DESCRIPTION
USPT-WP-YDSM-060001	PROJECT NOTES, ABBREVIATIONS AND LEGEND
USPT-WP-YDPAL-060001	SITE PLAN
USPT-WP-YDDET-060001	TYPICAL EXPANSION LOOP DETAIL
USPT-WP-YDDET-060010	GUIDED AND ANCHORED SUPPORT DETAILS
USPT-WP-YDDET-060011	SLIDING SUPPORT DETAILS
USPT-WP-YDWV-060001	WIND-INDUCED VIBRATION MITIGATION PLAN



REVISIONS

REV	DATE	DESCRIPTION	BY	CHK	APPD	PROJ
10	12/28/11	ISSUED FOR CONSTRUCTION	RFH	JWG	PAD	GMP




EXPORT PIPELINE - PIPELINE PIPELINE ALIGNMENT SHEET PLAN & PROFILE
 STA 1061+00 TO STA 1093+00

POINT THOMSON ALASKA

MODULE: R. HOBBS DATE: 12/11 SCALE: AS SHOWN

DRAWING NO. USPT-WP-YDPAL-060036-001 SHEET 1 of 110

FILENAME: USPT-WP-YDPAL-060035-001

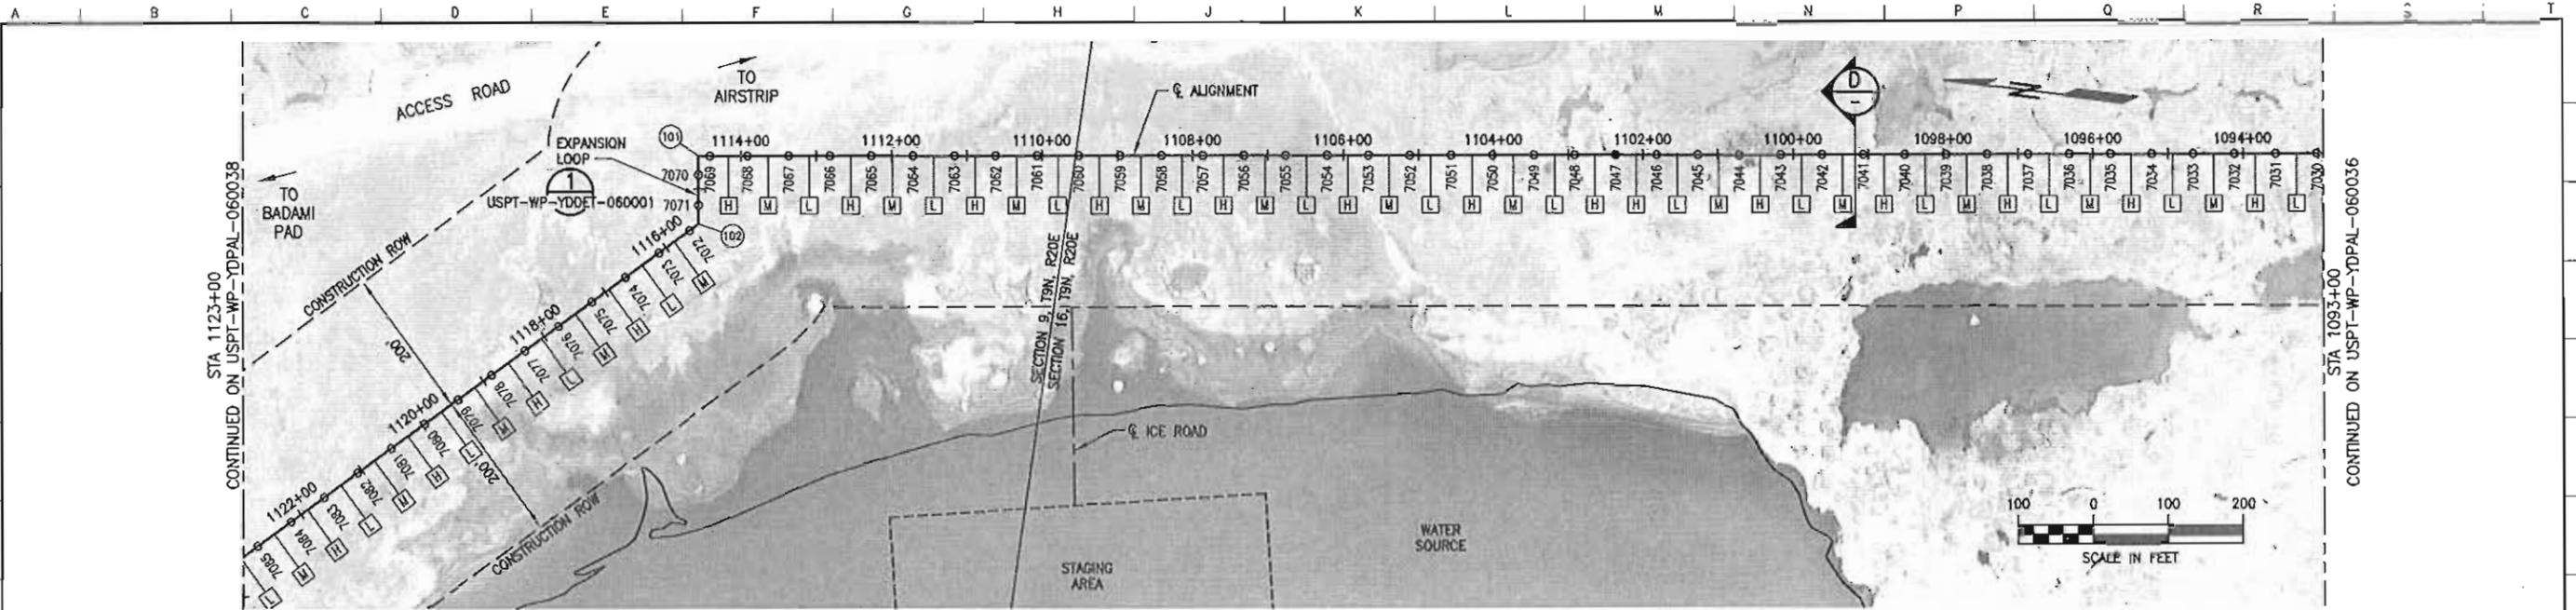

LOCATION	MATERIAL	WALL THK (IN)	FBE COATING (MIL)	INSULATION (IN)
1093+00 TO 1123+00	12.75" OIA API 5L X85	0.406	SHOP: 20 MIN, 32 MAX FIELD: 25 MIN, 39 MAX	3.0



POINT #	DESCRIPTION	STATION	NORTHING	EASTING	ANGLE
101	PI	1114+56.55	5902794.24	1506976.53	90.0'
102	PI	1115+46.55	5902782.88	1506887.25	54.0'

PIPE SUPPORT IDENTIFICATION
 VS-06-704-XXXX
 VERTICAL SUPPORT
 LOCATION CODE
 UNIT/MODULE
 SEQUENTIAL NUMBER
 (SHOWN ON PLAN & PROFILE)

SUPPORT TYPE NOMENCLATURE
 XX-XX-XX-XX-XX
 EXPORT = "X"
 GUIDE = "G"
 SLUOE = "S"
 ANCHOR = "A"
 HSM LENGTH (FT)
 NOMINAL VSM DIAMETER (IN)
 VSM LENGTH (FT)
 MINIMUM EMBEEDMENT (FT)

- NOTES**
- CENTERLINE OF ALIGNMENT = CENTERLINE OF 12"-LN-644-0049-MEBEV-3"TH.
 - STATIONING ALONG ALIGNMENT REFLECTS HORIZONTAL DISTANCE.
 - HORIZONTAL DATUM IS NAD83, ALASKA STATE PLANE ZONE 3, US FOOT.
 - VERTICAL DATUM IS POINT THOMSON UNIT MEAN LOWER LOW WATER (PTU MLLW).
 - FOR GUIDED AND ANCHORED SUPPORT DETAILS, SEE USPT-WP-YDDET-060010.
 - FOR SLIDING SUPPORT DETAILS, SEE USPT-WP-YDDET-060011.
 - FOR WIND-INDUCED VIBRATION MITIGATION PLAN AND TUNED VIBRATION ABSORBER (TVA) INSTALLATION, SEE USPT-WP-YDWIN-060001.

- LEGEND**
- GUIDED OR SLIDING SUPPORT
 - ANCHORED SUPPORT
 - ⊙ PI OR VPI LOCATION
 - H HIGH FREQUENCY TVA
 - L LOW FREQUENCY TVA
 - M MEDIUM FREQUENCY TVA

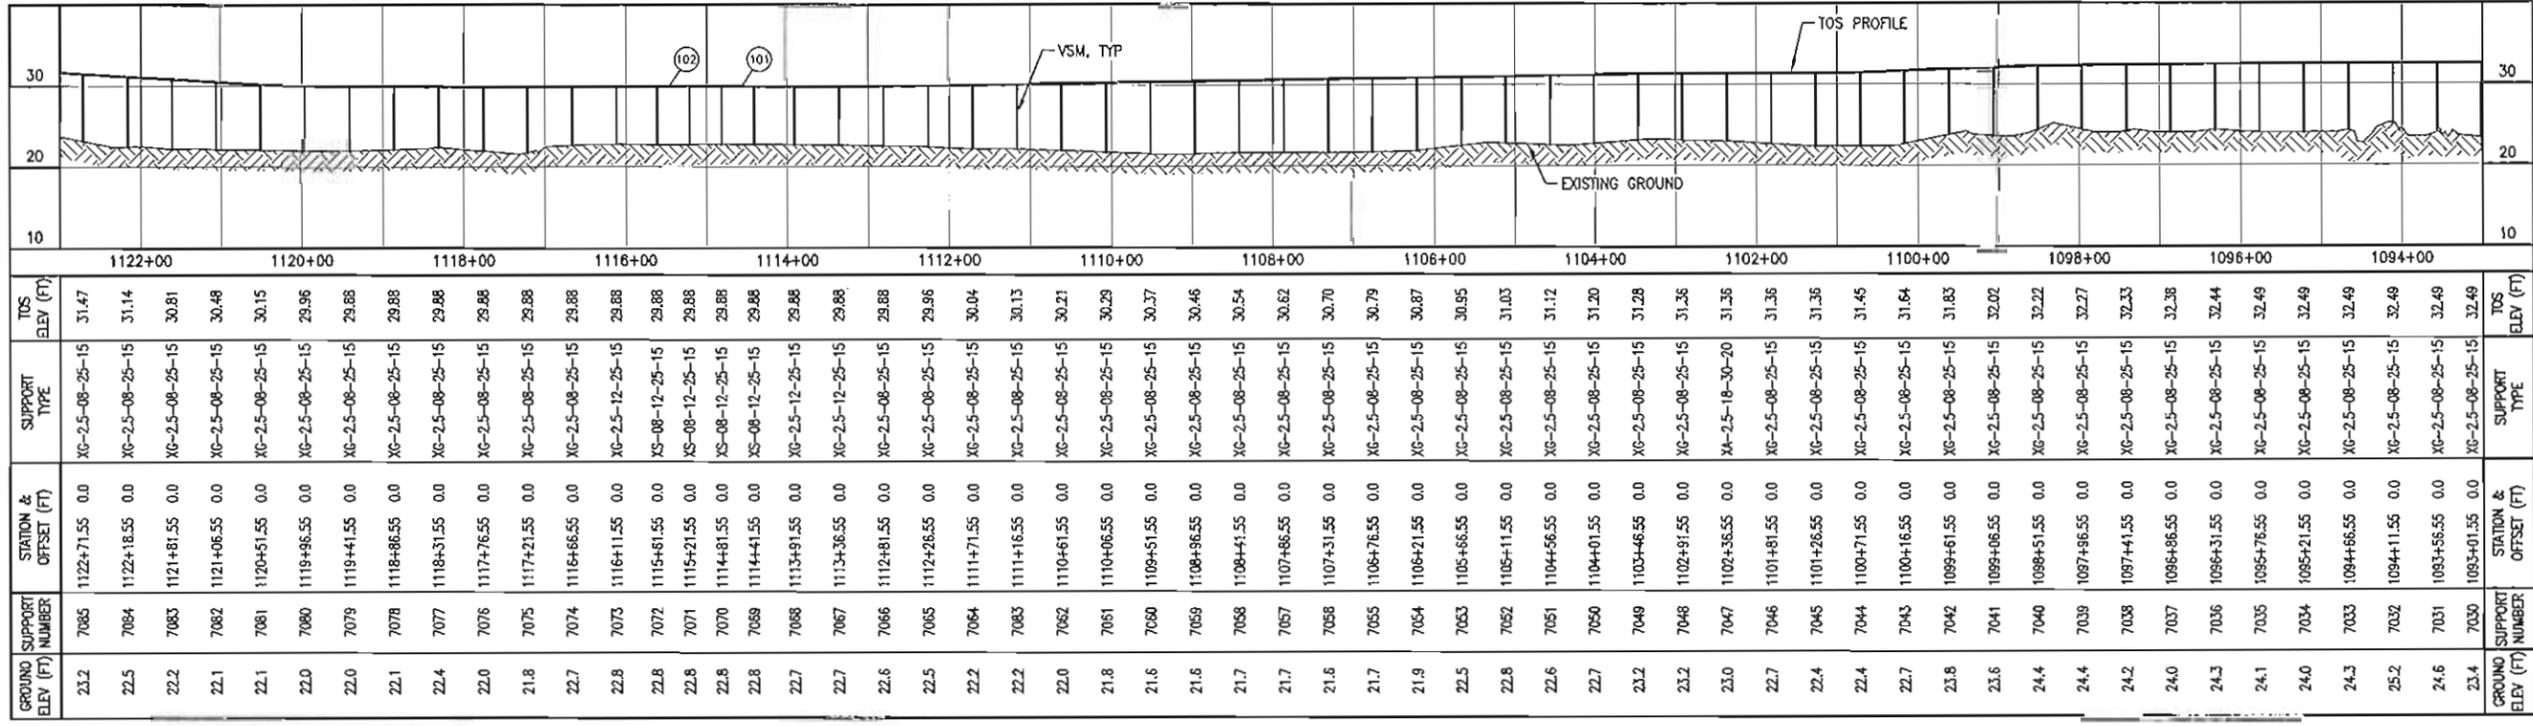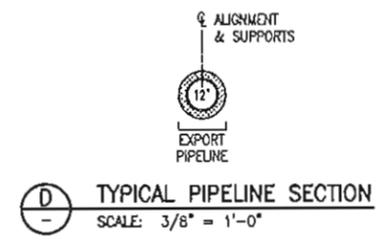

REFERENCE DRAWINGS	DESCRIPTION
USPT-WP-YDSTM-060001	PROJECT NOTES, ABBREVIATIONS AND LEGEND
USPT-WP-YDPAL-060001	SITE PLAN
USPT-WP-YDDET-060001	TYPICAL EXPANSION LOOP DETAIL
USPT-WP-YDDET-060010	GUIDED AND ANCHORED SUPPORT DETAILS
USPT-WP-YDDET-060011	SLIDING SUPPORT DETAILS
USPT-WP-YDWIN-060001	WIND-INDUCED VIBRATION MITIGATION PLAN



REV	DATE	DESCRIPTION	BY	CHK	APPD	PROJ
10	12/28/11	ISSUED FOR CONSTRUCTION	RH	JWG	PAC	GMP



EXPORT PIPELINE - PIPELINE ALIGNMENT SHEET PLAN & PROFILE
 STA 1093+00 TO STA 1123+00


POINT THOMSON ALASKA

MODULE	DRAWN	DATE	SCALE	CHK	APPD
	R. HOBBS	12/11	AS SHOWN		

DRAWING NO. USPT-WP-YDPAL-060037-001 SHEET 1 OF 10

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FILENAME: USPT-WP-YDPAL-060037-001

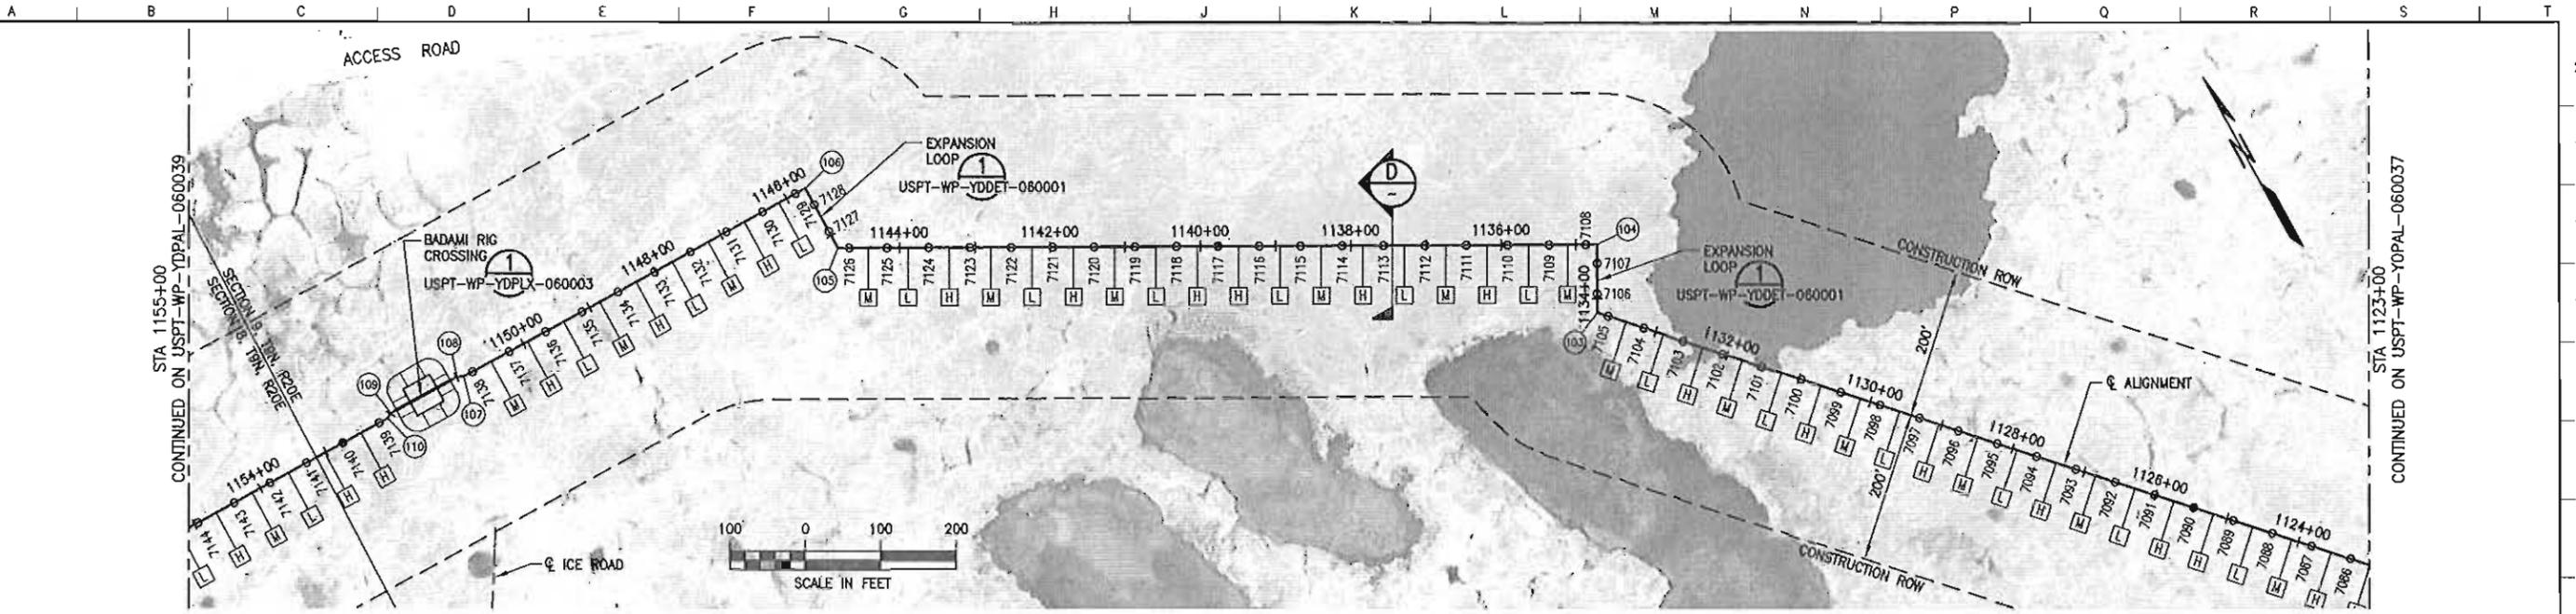

PIPELINE DATA TABLE				
LOCATION	MATERIAL	WALL THK (IN)	FBE COATING (MIL)	INSULATION (IN)
1123+00 TO 1155+00	12.75" DIA API 5L X65	0.406	SHOP: 20 MIN, 32 MAX FIELD: 25 MIN, 39 MAX	3.0



COORDINATE TABLE					
POINT	DESCRIPTION	STATION	NORTHING	EASTING	ANGLE
103	PI	1133+81.55	5904119.44	1505629.94	71.7°
104	PI	1134+71.55	5904198.55	1505672.85	90.0°
105	PI	1144+81.55	5904680.14	1504785.06	61.5°
106	PI	1145+71.55	5904770.14	1504785.06	90.0°
107	PI/VPI	1150+89.72	5904770.14	1504286.90	27.6°
108	PI/VPI	1150+98.35	5904774.14	1504259.24	27.6°
109	PI/VPI	1151+98.70	5904774.14	1504158.89	31.1°
110	PI/VPI	1152+06.68	5904770.14	1504151.99	31.1°

PIPE SUPPORT IDENTIFICATION
 VS-08-704-XXXX
 VERTICAL SUPPORT
 LOCATION CODE
 UNIT/MODULE
 SEQUENTIAL NUMBER
 (SHOWN ON PLAN & PROFILE)

SUPPORT TYPE NOMENCLATURE
 XX-XX-XX-XX-XX
 EXPORT = "X"
 GUIDE = "G"
 SLIDE = "S"
 ANCHOR = "A"
 HSM LENGTH (FT)
 NOMINAL VSM DIAMETER (IN)
 VSM LENGTH (FT)
 MINIMUM EMBEDMENT (FT)

- NOTES**
- CENTERLINE OF ALIGNMENT = CENTERLINE OF 12"-LN-644-0049-ME8EV-3"H.
 - STATIONING ALONG ALIGNMENT REFLECTS HORIZONTAL DISTANCE.
 - HORIZONTAL DATUM IS NAD83, ALASKA STATE PLANE ZONE 3, US FOOT.
 - VERTICAL DATUM IS POINT THOMSON UNIT MEAN LOWER LOW WATER (PTU MLLW).
 - FOR GUIDED AND ANCHORED SUPPORT DETAILS, SEE USPT-WP-YDDET-060010.
 - FOR SLIDING SUPPORT DETAILS, SEE USPT-WP-YDDET-060011.
 - FOR WIND-INDUCED VIBRATION MITIGATION PLAN AND TUNED VIBRATION ABSORBER (TVA) INSTALLATION, SEE USPT-WP-YDWIV-060001.

- LEGEND**
- GUIDED OR SLIDING SUPPORT
 - ANCHORED SUPPORT
 - ⊙ PI OR VPI LOCATION
 - HIGH FREQUENCY TVA
 - LOW FREQUENCY TVA
 - MEDIUM FREQUENCY TVA

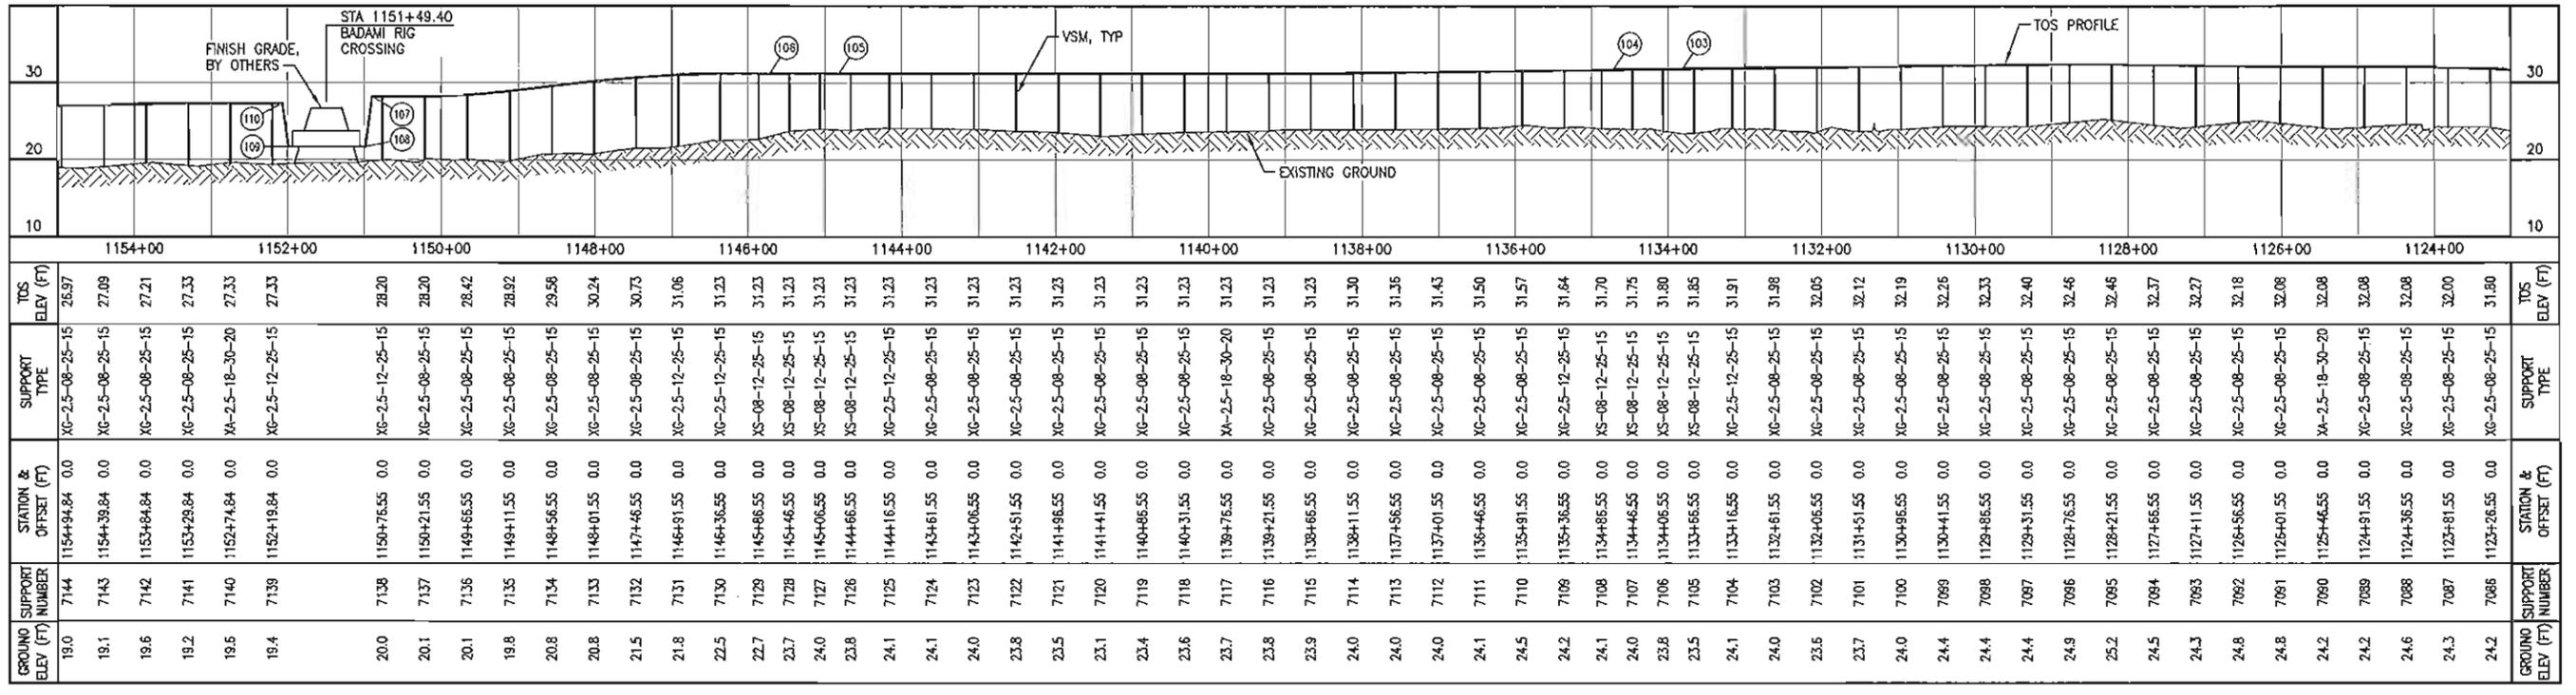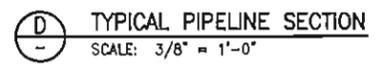

REFERENCE DRAWINGS	DESCRIPTION
USPT-WP-YDSYM-060001	PROJECT NOTES, ABBREVIATIONS AND LEGEND
USPT-WP-YDPAL-060001	SITE PLAN
USPT-WP-YDDET-060001	TYPICAL EXPANSION LOOP DETAIL
USPT-WP-YDDET-060010	GUIDED AND ANCHORED SUPPORT DETAILS
USPT-WP-YDDET-060011	SLIDING SUPPORT DETAILS
USPT-WP-YDWIV-060001	WIND-INDUCED VIBRATION MITIGATION PLAN
USPT-WP-YDPLX-060003	ROAD CROSSING PLAN AND SECTION BADAMI RIG CROSSING



REV	DATE	DESCRIPTION	BY	CHK	APPD	PROJ
10	12/28/11	ISSUED FOR CONSTRUCTION	RTH	JMG	PAC	GMP

ExxonMobil Development

WorleyParsons FLUOR, Baker

EXPORT PIPELINE - PIPELINE ALIGNMENT SHEET PLAN & PROFILE STA 1123+00 TO STA 1155+00			
POINT THOMSON	ALASKA	MODULE	ALASKA
R. HOBBS	DATE 12/11	SCALE AS SHOWN	CHK APPD PAC
DRAWING NO. USPT-WP-YDPAL-060038-001	SHEET 1 of 1	REV 10	

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FILENAME: USPT-WP-YDPAL-060038-001


NOTES

- CENTERLINE OF ALIGNMENT = CENTERLINE OF 12"-LN-644-0049-ME8EV-3'H.
- STATIONING ALONG ALIGNMENT REFLECTS HORIZONTAL DISTANCE.
- HORIZONTAL DATUM IS NAD83, ALASKA STATE PLANE ZONE 3, US FOOT.
- VERTICAL DATUM IS POINT THOMSON UNIT MEAN LOWER LOW WATER (PTU MLLW).
- FOR GUIDED AND ANCHORED SUPPORT DETAILS, SEE USPT-WP-YDDET-060010.
- FOR SLIDING SUPPORT DETAILS, SEE USPT-WP-YDDET-060011.
- FOR WIND-INDUCED VIBRATION MITIGATION PLAN AND TUNED VIBRATION ABSORBER (TVA) INSTALLATION, SEE USPT-WP-YDWP-060001.


LEGEND

- GUIDED OR SLIDING SUPPORT
- ANCHORED SUPPORT
- Ⓜ PI OR VPI LOCATION
- Ⓜ HIGH FREQUENCY TVA
- Ⓜ LOW FREQUENCY TVA
- Ⓜ MEDIUM FREQUENCY TVA

PIPE SUPPORT IDENTIFICATION

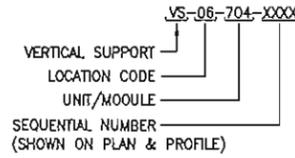


SUPPORT TYPE NOMENCLATURE

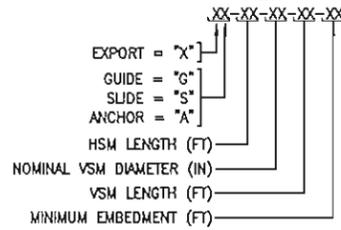

POINT #	DESCRIPTION	STATION	NORTHING	EASTING	ANGLE
111	PI	1160+54.84	5904770.14	1503303.83	45.0°
112	PI	1160+94.84	5904741.86	1503275.55	90.0°
113	PI	1161+74.84	5904798.43	1503218.98	90.0°
114	PI	1162+14.84	5904828.71	1503247.26	45.0°
115	PI	1168+84.84	5905496.71	1503247.26	45.0°
EOP	END OF PIPELINE	1172+86.84	5905780.97	1503531.52	-

LOCATION	MATERIAL	WALL THK (IN)	FBE COATING (MIL)	INSULATION (IN)
1155+00 TO EOP	12.75" DIA API 5L X65	0.406	SHOP: 20 MIN, 32 MAX FIELD: 25 MIN, 39 MAX	3.0

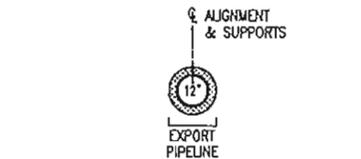


D TYPICAL PIPELINE SECTION
SCALE: 3/8" = 1'-0"

GROUND ELEV (FT)	SUPPORT NUMBER	STATION & OFFSET (FT)	SUPPORT TYPE	TOS ELEV (FT)
11.2	7179	1172+59.84 0.0	XA-2.5-18-30-20	19.75
11.8	7178	1172+19.84 0.0	XG-2.5-08-25-15	19.75
11.7	7177	1171+65.84 0.0	XG-2.5-08-25-15	19.75
11.7	7176	1171+11.84 0.0	XG-2.5-08-25-15	19.87
12.0	7175	1170+57.84 0.0	XG-2.5-08-25-15	20.05
12.4	7174	1170+03.84 0.0	XG-2.5-08-25-15	20.40
12.1	7173	1169+49.84 0.0	XG-2.5-12-25-15	20.88
12.2	7172	1168+99.84 0.0	XS-08-12-25-15	21.21
12.0	7171	1168+69.84 0.0	XS-08-12-25-15	21.31
12.7	7170	1168+19.84 0.0	XG-2.5-12-25-15	21.42
13.1	7169	1167+65.84 0.0	XA-2.5-18-30-20	21.42
13.7	7168	1167+11.84 0.0	XG-2.5-08-25-15	21.42
13.8	7167	1166+57.84 0.0	XG-2.5-08-25-15	21.42
14.0	7166	1166+03.84 0.0	XG-2.5-08-25-15	21.60
14.1	7165	1165+49.84 0.0	XG-2.5-08-25-15	21.89
15.0	7164	1164+95.84 0.0	XG-2.5-08-25-15	22.34
15.3	7163	1164+41.84 0.0	XG-2.5-08-25-15	22.90
15.4	7162	1163+87.84 0.0	XG-2.5-08-25-15	23.47
15.5	7161	1163+33.84 0.0	XG-2.5-08-25-15	23.91
15.9	7160	1162+79.84 0.0	XG-2.5-12-25-15	24.21
16.1	7159	1162+25.84 0.0	XG-2.5-08-25-15	24.37
16.0	7158	1161+71.84 0.0	XS-08-08-25-15	24.49
16.3	7157	1161+17.84 0.0	XS-08-12-25-15	24.62
16.5	7156	1161+14.84 0.0	XS-08-12-25-15	24.75
16.7	7155	1160+74.84 0.0	XS-08-08-25-15	24.88
16.9	7154	1160+30.84 0.0	XG-2.5-12-25-15	25.00
17.1	7153	1159+86.84 0.0	XG-2.5-12-25-15	25.16
17.5	7152	1159+42.84 0.0	XG-2.5-08-25-15	25.35
17.8	7151	1158+98.84 0.0	XG-2.5-08-25-15	25.58
18.7	7150	1158+54.84 0.0	XG-2.5-08-25-15	25.92
18.8	7149	1157+0.84 0.0	XG-2.5-08-25-15	26.27
19.3	7148	1157+14.84 0.0	XG-2.5-08-25-15	26.50
18.8	7147	1156+60.84 0.0	XG-2.5-08-25-15	26.62
18.8	7146	1156+16.84 0.0	XG-2.5-08-25-15	26.74
19.1	7145	1155+42.84 0.0	XG-2.5-08-25-15	26.86

REFERENCE DRAWINGS	DESCRIPTION
USPT-WP-YDSM-060001	PROJECT NOTES, ABBREVIATIONS AND LEGEND
USPT-WP-YDPAL-060001	SITE PLAN
USPT-WP-YDDET-060001	TYPICAL EXPANSION LOOP DETAIL
USPT-WP-YDDET-060010	GUIDED AND ANCHORED SUPPORT DETAILS
USPT-WP-YDDET-060011	SLIDING SUPPORT DETAILS
USPT-WP-YDDET-110001	BADAMI TIE-IN PLAN AND DETAILS
USPT-WP-YDWP-060001	WIND-INDUCED VIBRATION MITIGATION PLAN



REV	DATE	DESCRIPTION	BY	CHK	APPD	PROJ
10	12/28/11	ISSUED FOR CONSTRUCTION	RTH	JAG	PAC	GMP

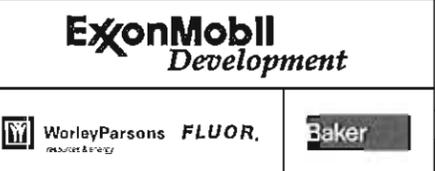


EXPORT PIPELINE - PIPELINE ALIGNMENT SHEET PLAN & PROFILE STA 1155+00 TO EOP			
POINT THOMSON	ALASKA	MODULE	DATE
R. HOBBS	12/11	SCALE AS SHOWN	CHK APPD PAC
DRAWING NO. USPT-WP-YDPAL-060039-001	SHEET 1 of 1	REV	10

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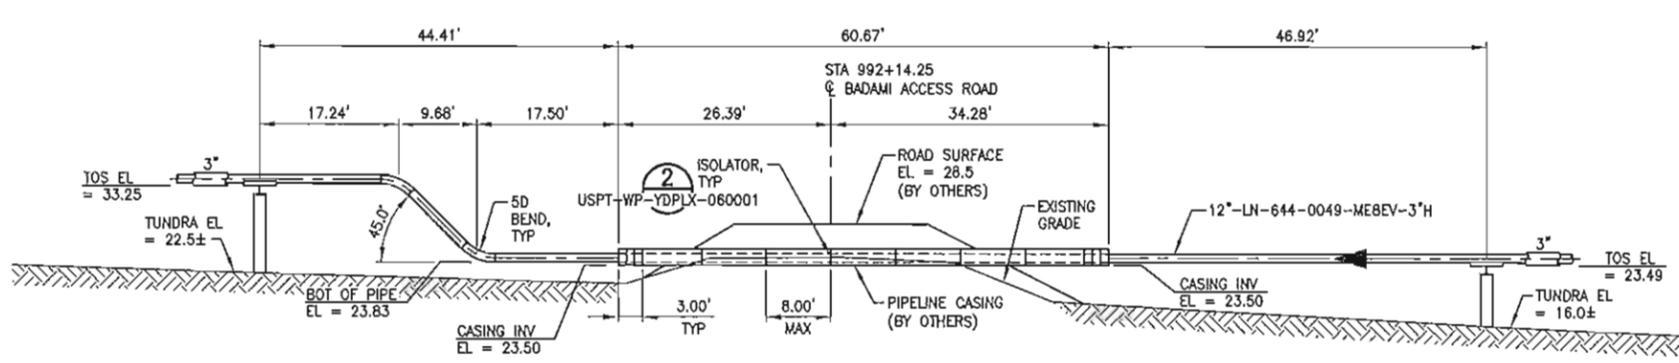
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NOTES


1. CENTERLINE OF ALIGNMENT = CENTERLINE OF 12"-LN-644-0049-ME8EV-3"H.
2. STATIONING ALONG ALIGNMENT REFLECTS HORIZONTAL DISTANCE.
3. HORIZONTAL DATUM IS NAD83, ALASKA STATE PLANE ZONE 3, US FOOT.
4. VERTICAL DATUM IS POINT THOMSON UNIT MEAN LOWER LOW WATER (PTU MLLW).
5. ALL PIPELINE BENDS ARE 50 UNLESS NOTED OTHERWISE.
6. PROPOSED GRAVEL ROADWAYS AND PIPELINE CASINGS ARE BY OTHERS.



1 BADAMI ACCESS ROAD - PLAN
USPT-WP-YDPAL-060033 SCALE: 1" = 10'

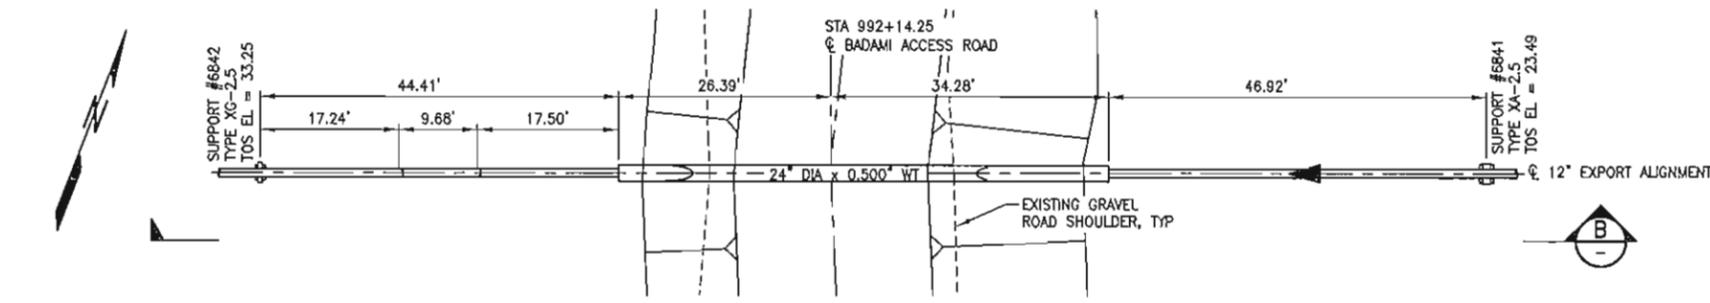

B BADAMI ACCESS ROAD - SECTION
SCALE: 1" = 10'

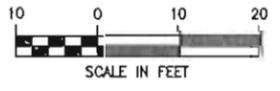

REFERENCE DRAWINGS	DESCRIPTION
USPT-WP-YDPAL-060033	PLAN & PROFILE



REV	DATE	DESCRIPTION	BY	CHK	APPD	PROJ
10	12/28/11	ISSUED FOR CONSTRUCTION	RPH	JMG	PAC	GMP

ExxonMobil
Development


WorleyParsons **FLUOR.** Baker

EXPORT PIPELINE - PIPELINE PIPELINE CROSSING DETAIL BADAMI ACCESS ROAD			
POINT THOMSON			ALASKA
MODULE	DRAWN	DATE	SCALE
R. HOBBS	12/11	AS SHOWN	
CHK	APPD	JMG	PAC
DRAWING NO. USPT-WP-YDPLX-060002-001			SHEET 1 of 10


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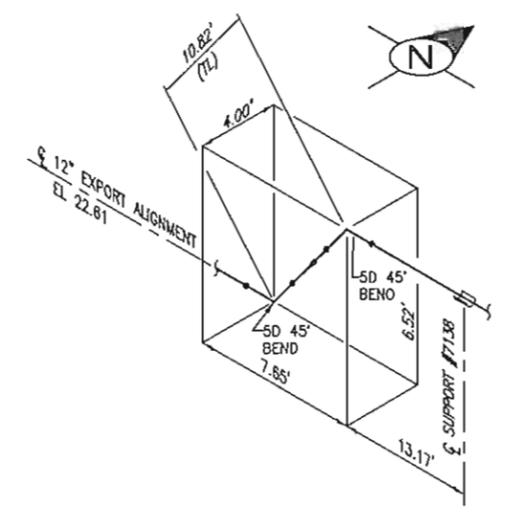
- NOTES**
- CENTERLINE OF ALIGNMENT = CENTERLINE OF 12"-LN-644-0049-MEBEV-3"H.
 - STATIONING ALONG ALIGNMENT REFLECTS HORIZONTAL DISTANCE.
 - HORIZONTAL DATUM IS NAD83, ALASKA STATE PLANE ZONE 3, US FOOT.
 - VERTICAL DATUM IS POINT THOMSON UNIT MEAN LOWER LOW WATER (PTU MLLW).
 - ALL PIPELINE BENDS ARE 5D UNLESS NOTED OTHERWISE.
 - PROPOSED GRAVEL ROADWAYS AND PIPELINE CASINGS ARE BY OTHERS.




3 DETAIL - ROLLING OFFSET
NOT TO SCALE

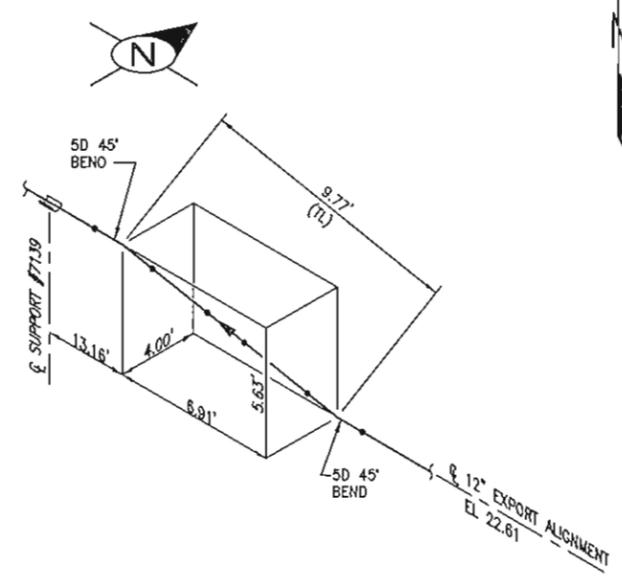


1 BADAMI RIG CROSSING - PLAN
USPT-WP-YDPAL-080038 SCALE: 1" = 10'

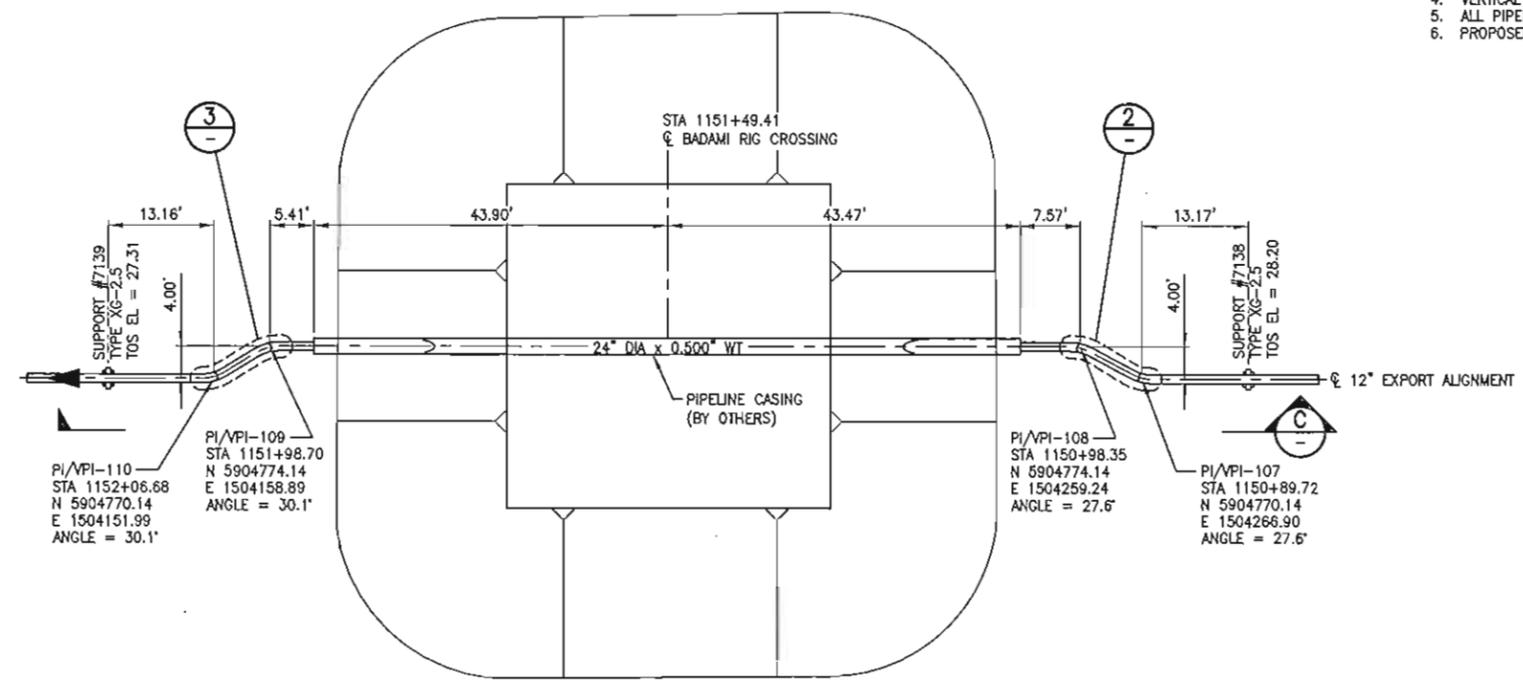


2 DETAIL - ROLLING OFFSET
NOT TO SCALE

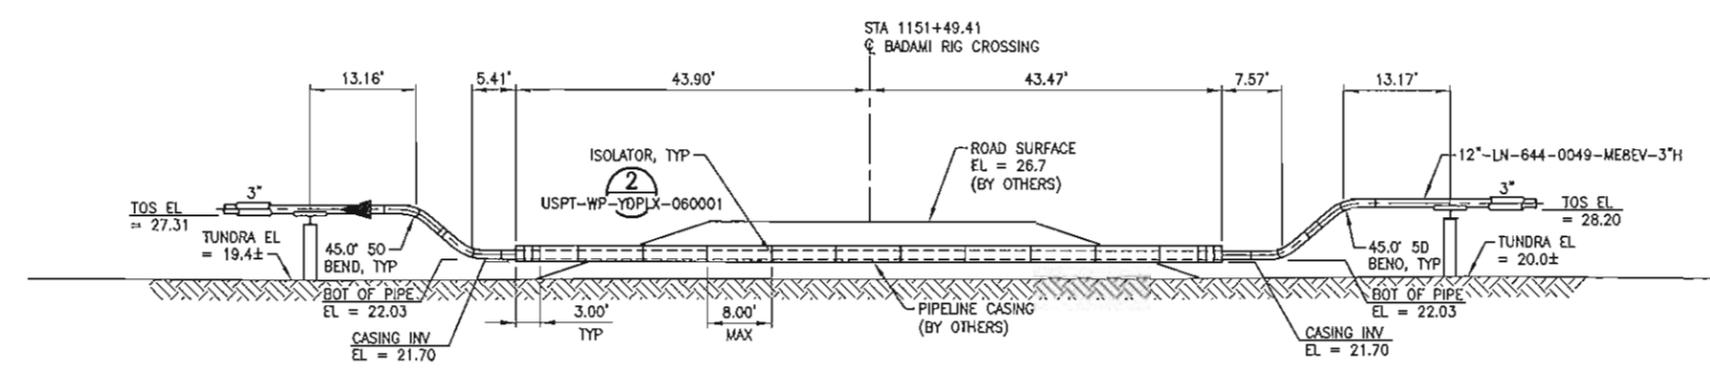

C BADAMI RIG CROSSING - SECTION
SCALE: 1" = 10'

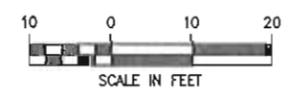

REFERENCE DRAWINGS	DESCRIPTION
USPT-WP-YDPAL-080038	PLAN & PROFILE

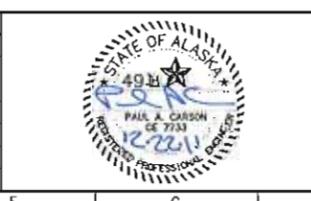

REV	DATE	DESCRIPTION	BY	CHK	APPD	PROJ
10	12/28/11	ISSUED FOR CONSTRUCTION	RTH	JMG	PAC	GMP


ExxonMobil
Development

WorleyParsons **FLUOR**, Baker



EXPORT PIPELINE - PIPELINE PIPELINE CROSSING DETAIL BADAMI RIG CROSSING				ALASKA				
MODULE	DRAWN	DATE	SCALE	CHK	JAG	APPD	PAC	
	R. HOBBS	12/11	AS SHOWN					
DRAWING NO. USPT-WP-YDPLX-060003-001							SHEET 1 of 1	REV 10

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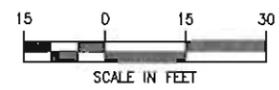
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- NOTES**
- CENTERLINE OF ALIGNMENT = CENTERLINE OF 12"-LN-644-0049-ME8EV-37H.
 - HORIZONTAL BEND ANGLE IS 90 DEGREES TYPICAL, BUT DDES VARY. SEE COORDINATE TABLE ON PLAN AND PROFILE DRAWINGS FOR HORIZONTAL BEND ANGLES AT PI'S (USPT-WP-YDPAL-060010 THRU USPT-WP-YDPAL-060039).
 - HSM LENGTHS VARY. SEE PIPELINE SUPPORT DETAILS ON USPT-WP-YDDET-060010 AND USPT-WP-YDDET-060011.
 - ALL PIPELINE BENDS ARE 5D UNLESS NOTED OTHERWISE.
 - SUPPORT SPACINGS SHOWN ARE TYPICAL, BUT MAY VARY. REFER TO PLAN AND PROFILE DRAWINGS.

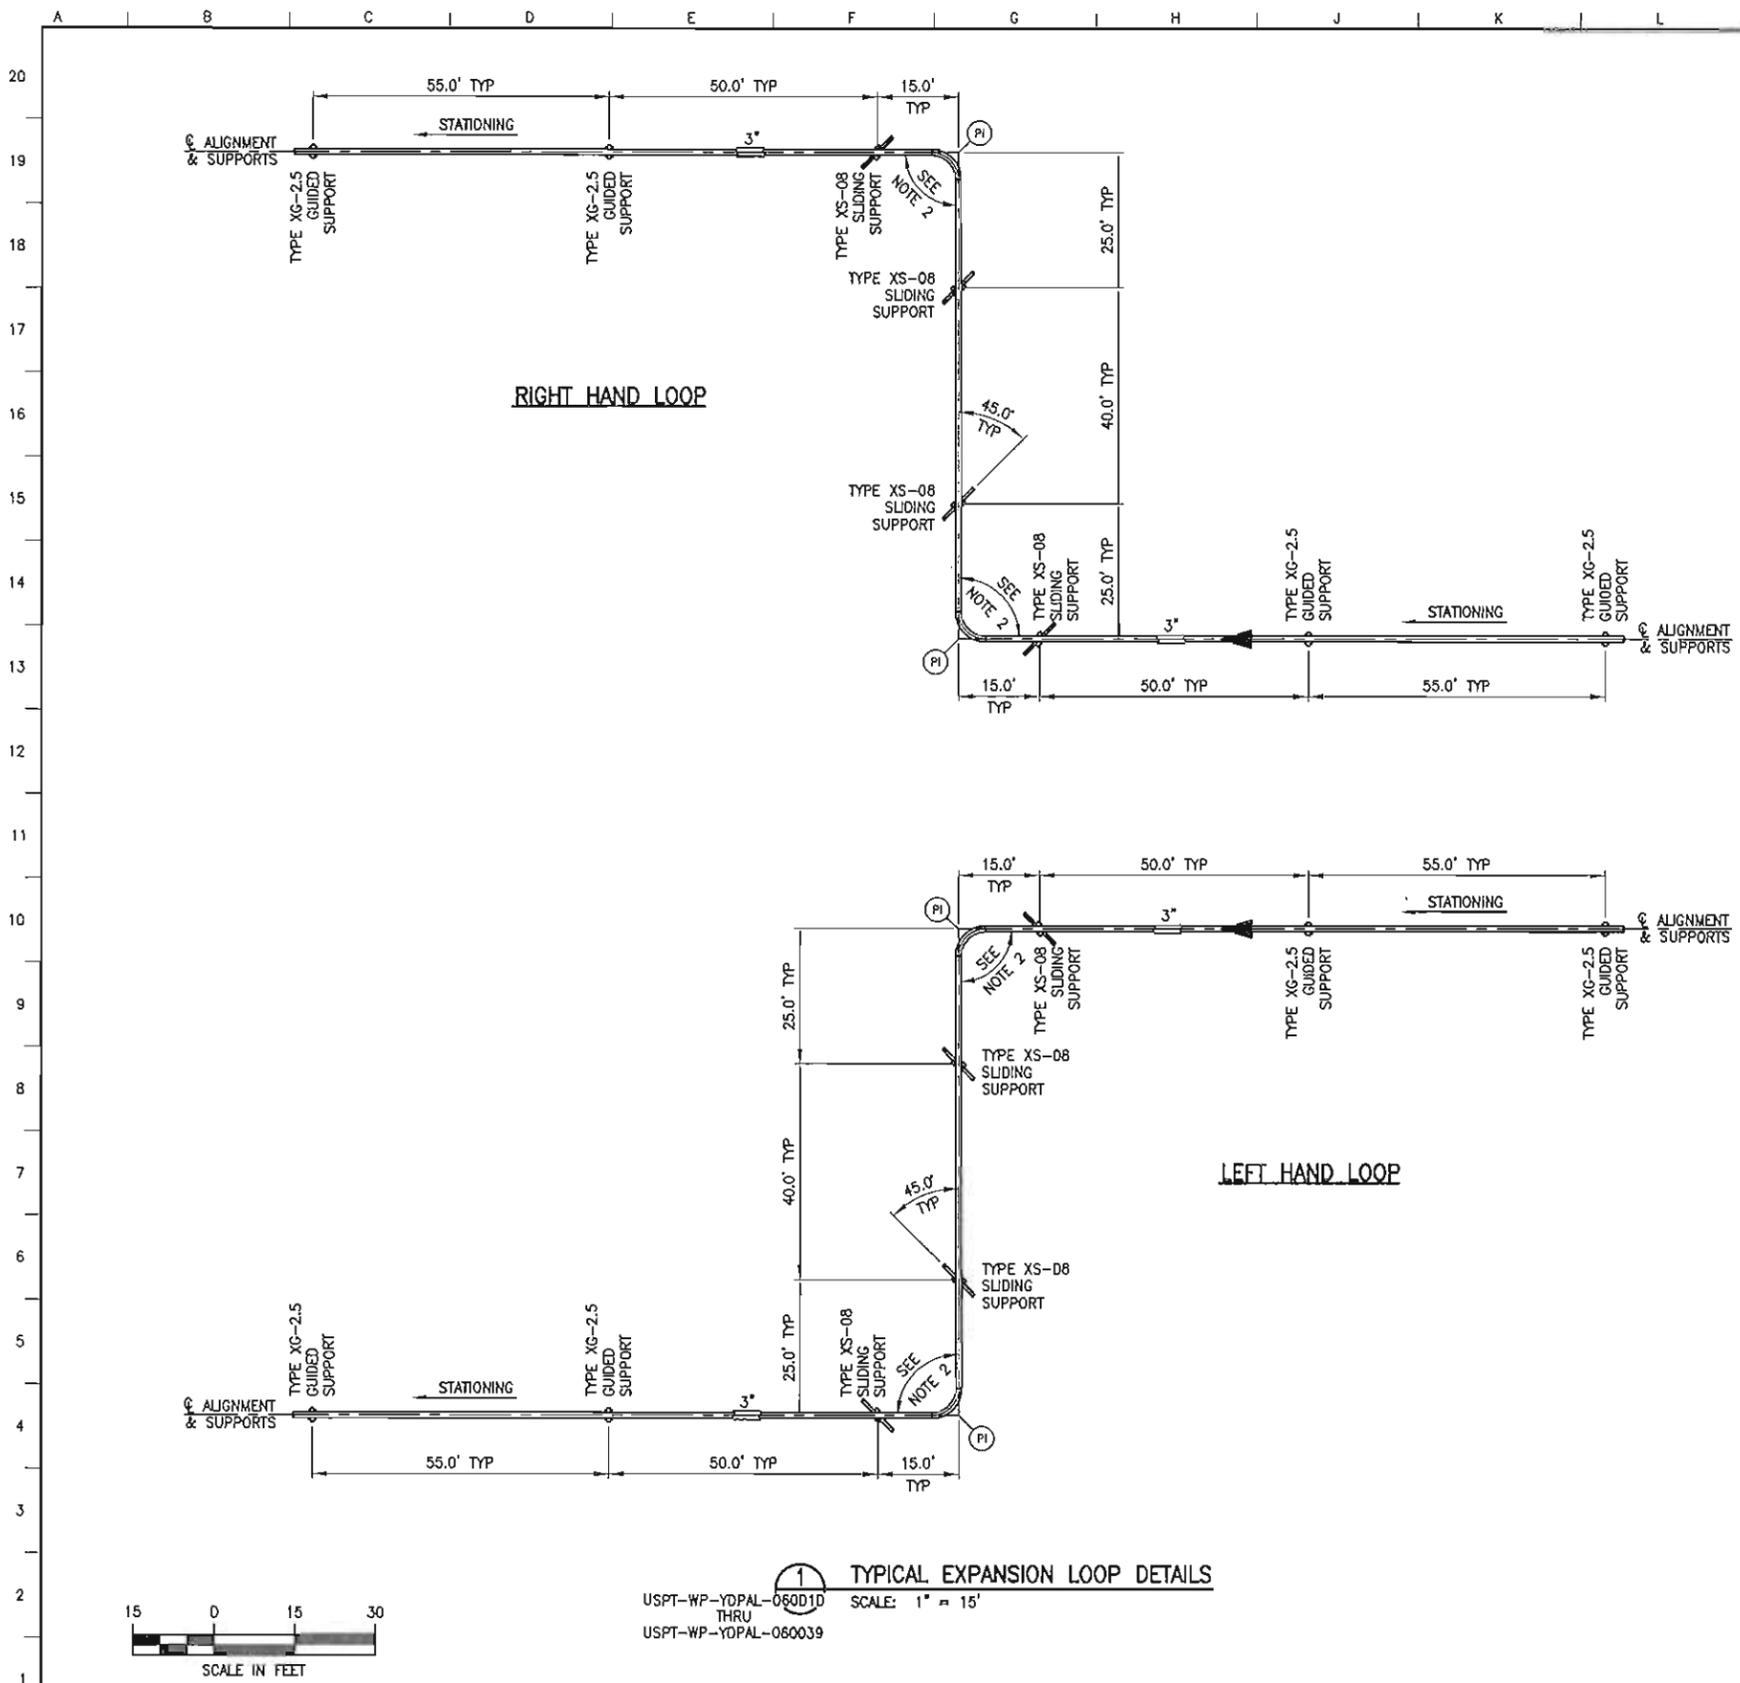

1
TYPICAL EXPANSION LOOP DETAILS
USPT-WP-YDPAL-060010 THRU
USPT-WP-YDPAL-060039
SCALE: 1" = 15'

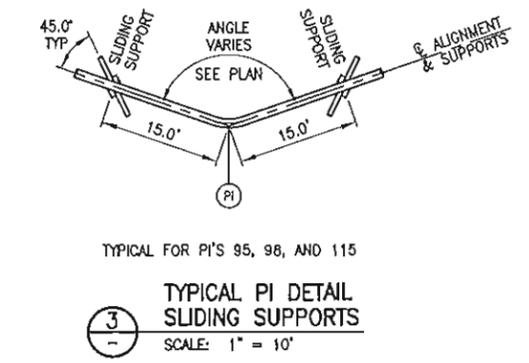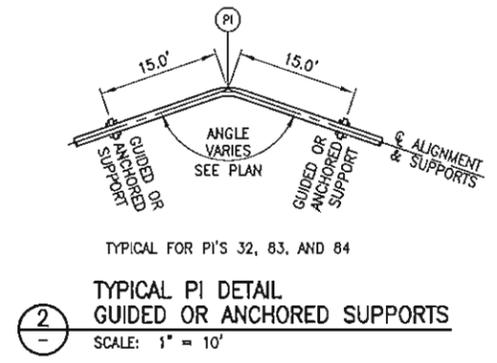

REFERENCE DRAWINGS	DESCRIPTION
USPT-WP-YDPAL-060010 THRU 060039	PLANS & PROFILES
USPT-WP-YDDET-060010	GUIDED AND ANCHORED SUPPORT DETAILS
USPT-WP-YDDET-060011	SLIDING SUPPORT DETAILS




REV	DATE	DESCRIPTION	BY	CHK	APPD	PROJ
10	12/28/11	ISSUED FOR CONSTRUCTION	RTH	GAD	PAC	GMP

**EXPORT PIPELINE - PIPELINE
DETAIL DRAWING
TYPICAL PI AND EXPANSION LOOP DETAILS
WEST WELL PAD JUNCTION TO BADAMI**

POINT THOMSON		ALASKA	
MODULE	DRAWN	DATE	SCALE
R. HOBBS	R. HOBBS	12/11	AS SHOWN
DRAWING NO.	CHECKED	APPROVED	DATE
USPT-WP-YDDET-060001-001	1 of 1		10


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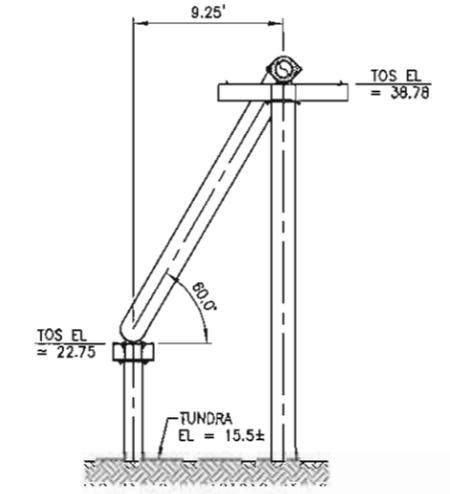


1
BADAMI CREEK EAST VERTICAL LOOP -- PLAN
USPT-WP-YDPAL-060033 SCALE: 1" = 10'

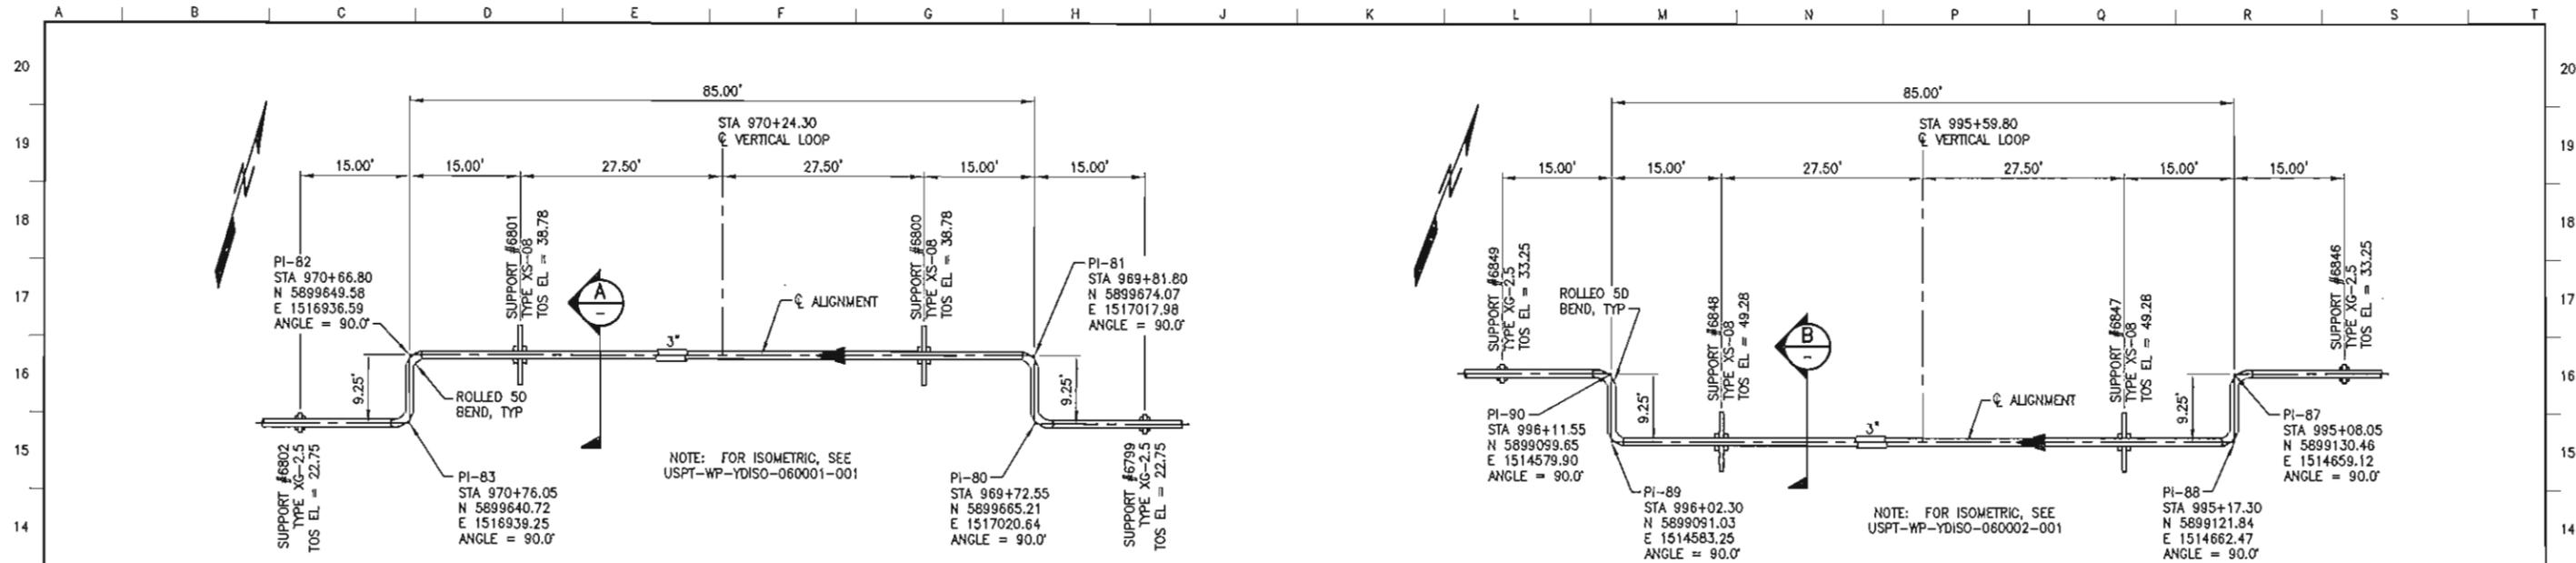
2
BADAMI CREEK WEST VERTICAL LOOP -- PLAN
USPT-WP-YDPAL-060033 SCALE: 1" = 10'




3
Y CREEK VERTICAL LOOP -- PLAN
USPT-WP-YDPAL-060018 SCALE: 1" = 10'

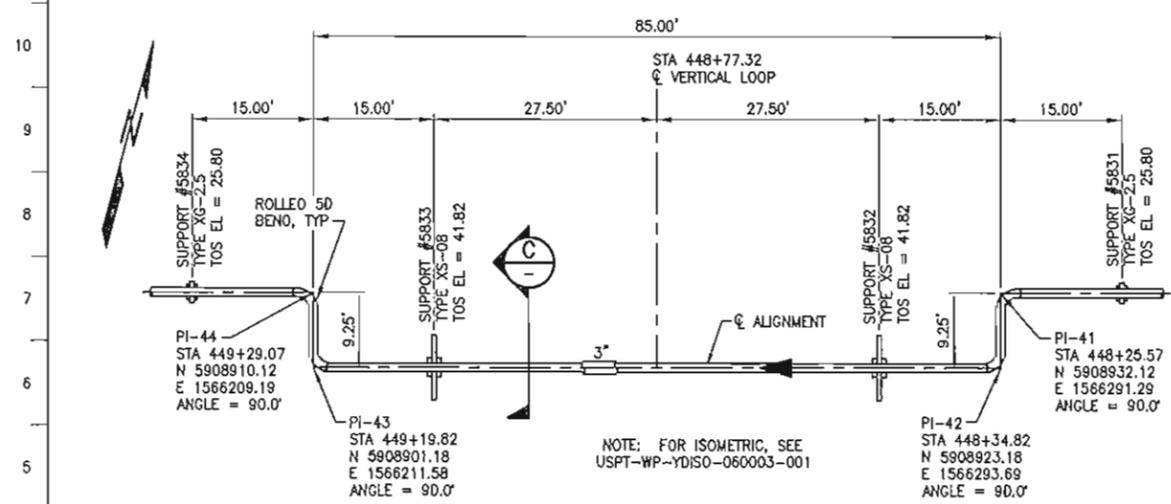


A
BADAMI CREEK EAST VERTICAL LOOP -- ELEVATION
SCALE: 1" = 5'

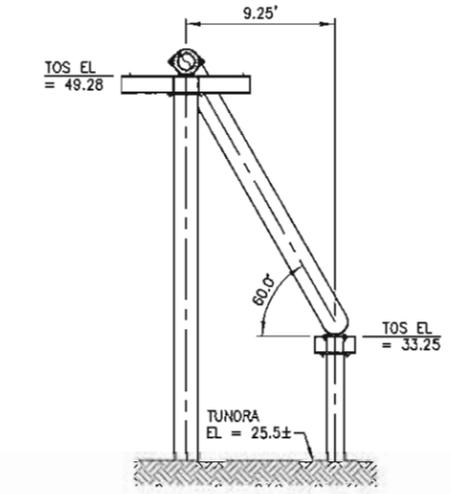

B
BADAMI CREEK WEST VERTICAL LOOP -- ELEVATION
SCALE: 1" = 5'

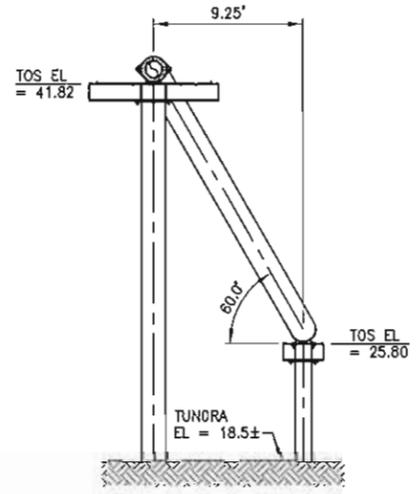

C
Y CREEK VERTICAL LOOP -- ELEVATION
SCALE: 1" = 5'

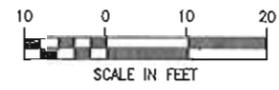

- NOTES**
- CENTERLINE OF ALIGNMENT = CENTERLINE OF 12"-LN-644-0049-MEBEV-3" H.
 - STATIONING ALONG ALIGNMENT REFLECTS HORIZONTAL DISTANCE.
 - HORIZONTAL DATUM IS NAD83, ALASKA STATE PLANE ZONE 3, US FOOT.
 - ALL PIPELINE BENDS ARE 50 UNLESS NOTED OTHERWISE.
 - FOR GUIDED AND ANCHORED SUPPORT DETAILS, SEE USPT-WP-YDDET-060010.
 - FOR SLIDING SUPPORT DETAILS, SEE USPT-WP-YDDET-060011.


REFERENCE DRAWINGS	DESCRIPTION
USPT-WP-YDPAL-060018	PLAN & PROFILE
USPT-WP-YDPAL-060033	PLAN & PROFILE
USPT-WP-YDDET-060010	GUIDED AND ANCHORED SUPPORT DETAILS
USPT-WP-YDDET-060011	SLIDING SUPPORT DETAILS
USPT-WP-YDISO-060001	BADAMI CREEK EAST VERTICAL LOOP ISOMETRIC
USPT-WP-YDISO-060002	BADAMI CREEK WEST VERTICAL LOOP ISOMETRIC
USPT-WP-YDISO-060003	Y CREEK VERTICAL LOOP ISOMETRIC



REV	DATE	DESCRIPTION	BY	CHK	APPR	PROJ
10	12/28/11	ISSUED FOR CONSTRUCTION	RTH	JWG	PLD	GUP



EXPORT PIPELINE - PIPELINE DETAIL DRAWING VERTICAL LOOP DETAILS			
POINT THOMSON		ALASKA	
DRAWN	DATE	SCALE	CHK
R. HOBBS	12/11	AS SHOWN	JWG
DRAWING NO.	SHEET	APPD	REV
USPT-WP-YDDET-060002-001	1 of 1	PLD	10

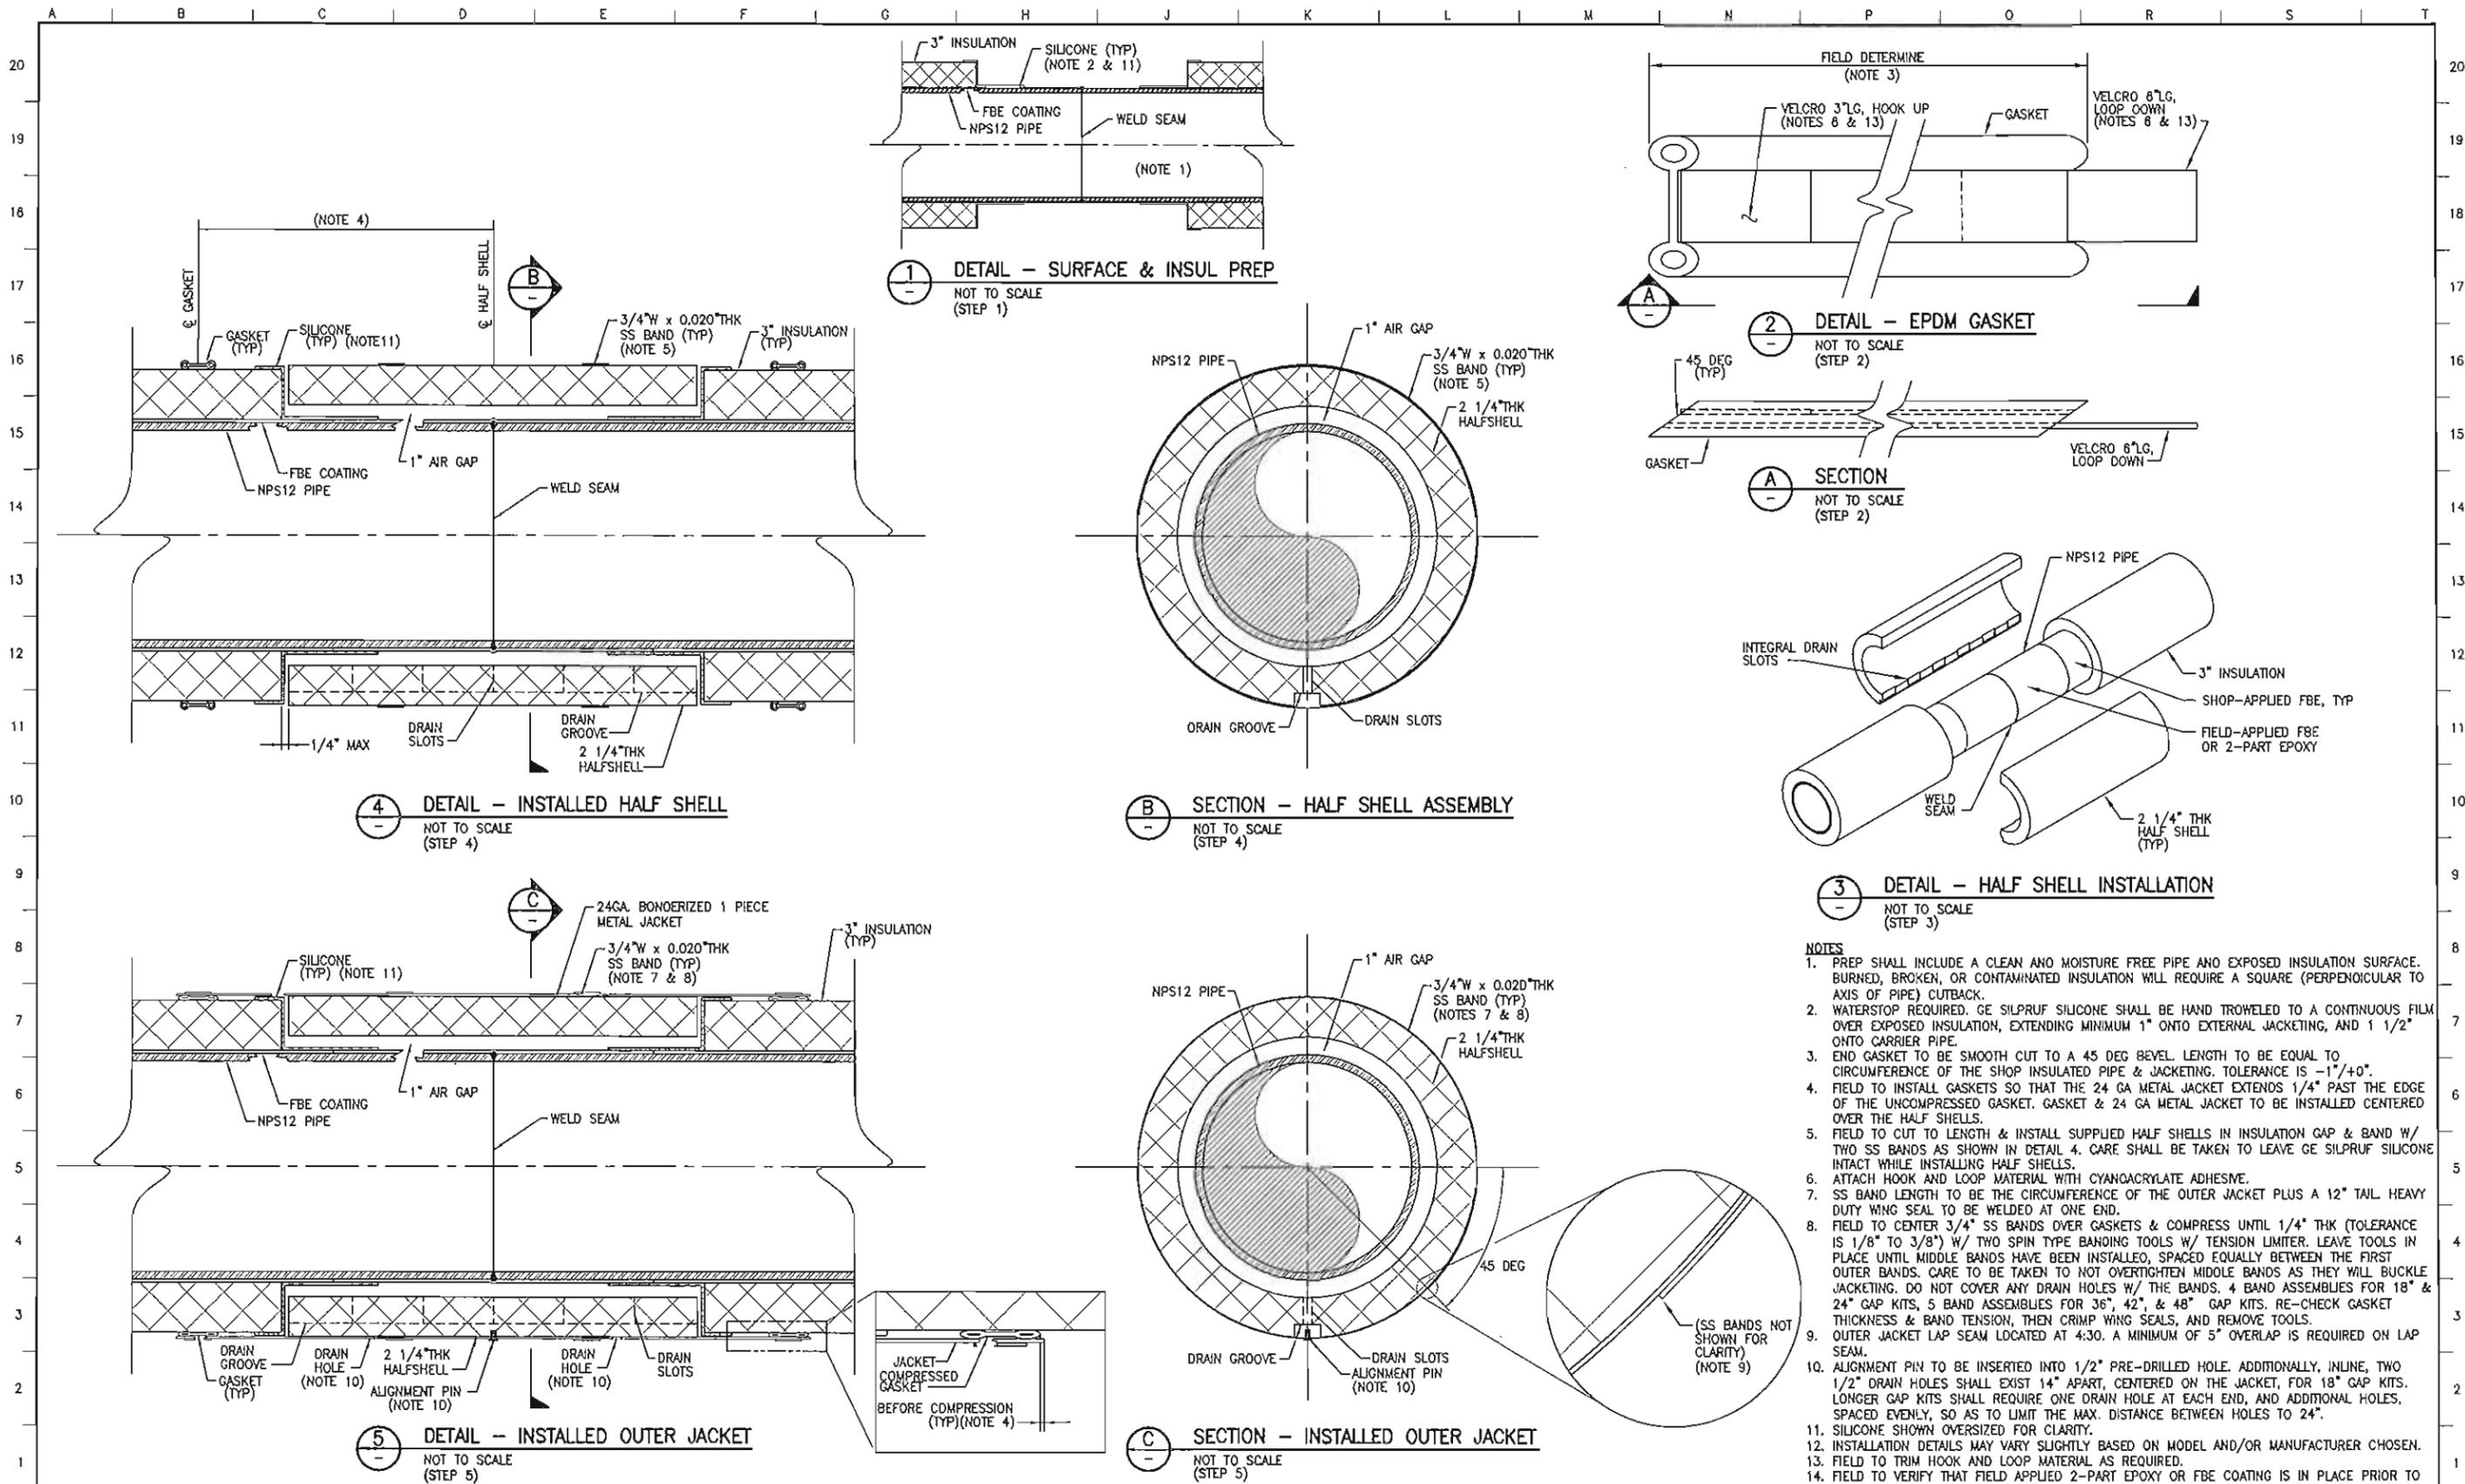

- NOTES**
- PREP SHALL INCLUDE A CLEAN AND MOISTURE FREE PIPE AND EXPOSED INSULATION SURFACE. BURNED, BROKEN, OR CONTAMINATED INSULATION WILL REQUIRE A SQUARE (PERPENDICULAR TO AXIS OF PIPE) CUTBACK.
 - WATERSTOP REQUIRED. GE SILPRUF SILICONE SHALL BE HAND TROWELED TO A CONTINUOUS FILM OVER EXPOSED INSULATION, EXTENDING MINIMUM 1" ONTO EXTERNAL JACKETING, AND 1 1/2" ONTO CARRIER PIPE.
 - END GASKET TO BE SMOOTH CUT TO A 45 DEG BEVEL. LENGTH TO BE EQUAL TO CIRCUMFERENCE OF THE SHOP INSULATED PIPE & JACKETING. TOLERANCE IS -1"/+0".
 - FIELD TO INSTALL GASKETS SO THAT THE 24 GA METAL JACKET EXTENDS 1/4" PAST THE EDGE OF THE UNCOMPRESSED GASKET. GASKET & 24 GA METAL JACKET TO BE INSTALLED CENTERED OVER THE HALF SHELLS.
 - FIELD TO CUT TO LENGTH & INSTALL SUPPLIED HALF SHELLS IN INSULATION GAP & BAND W/ TWO SS BANDS AS SHOWN IN DETAIL 4. CARE SHALL BE TAKEN TO LEAVE GE SILPRUF SILICONE INTACT WHILE INSTALLING HALF SHELLS.
 - ATTACH HOOK AND LOOP MATERIAL WITH CYANOACRYLATE ADHESIVE.
 - SS BAND LENGTH TO BE THE CIRCUMFERENCE OF THE OUTER JACKET PLUS A 12" TAIL HEAVY DUTY WING SEAL TO BE WELDED AT ONE END.
 - FIELD TO CENTER 3/4" SS BANDS OVER GASKETS & COMPRESS UNTIL 1/4" THK (TOLERANCE IS 1/8" TO 3/8") W/ TWO SPIN TYPE BANDING TOOLS W/ TENSION LIMITER. LEAVE TOOLS IN PLACE UNTIL MIDDLE BANDS HAVE BEEN INSTALLED, SPACED EQUALLY BETWEEN THE FIRST OUTER BANDS. CARE TO BE TAKEN TO NOT OVERTIGHTEN MIDDLE BANDS AS THEY WILL BUCKLE JACKETING. DO NOT COVER ANY DRAIN HOLES W/ THE BANDS. 4 BAND ASSEMBLIES FOR 18" & 24" GAP KITS, 5 BAND ASSEMBLIES FOR 36", 42", & 48" GAP KITS. RE-CHECK GASKET THICKNESS & BAND TENSION, THEN CRIMP WING SEALS, AND REMOVE TOOLS.
 - OUTER JACKET LAP SEAM LOCATED AT 4:30. A MINIMUM OF 5" OVERLAP IS REQUIRED ON LAP SEAM.
 - ALIGNMENT PIN TO BE INSERTED INTO 1/2" PRE-DRILLED HOLE. ADDITIONALLY, IN LINE, TWO 1/2" DRAIN HOLES SHALL EXIST 14" APART, CENTERED ON THE JACKET, FOR 18" GAP KITS. LONGER GAP KITS SHALL REQUIRE ONE DRAIN HOLE AT EACH END, AND ADDITIONAL HOLES, SPACED EVENLY, SO AS TO LIMIT THE MAX. DISTANCE BETWEEN HOLES TO 24".
 - SILICONE SHOWN OVERSIZED FOR CLARITY.
 - INSTALLATION DETAILS MAY VARY SLIGHTLY BASED ON MODEL AND/OR MANUFACTURER CHOSEN.
 - FIELD TO TRIM HOOK AND LOOP MATERIAL AS REQUIRED.
 - FIELD TO VERIFY THAT FIELD APPLIED 2-PART EPOXY OR FBE COATING IS IN PLACE PRIOR TO THE INSTALLATION OF EACH WELD PACK.

REFERENCE DRAWINGS	DESCRIPTION
USPT-WP-YDPA-060002 THRU 060009	PLANS & PROFILES

REV	DATE	DESCRIPTION	BY	CHK	APPD	PROJ
10	12/28/11	ISSUED FOR CONSTRUCTION	JNA	JAG	PAC	OMP



ExxonMobil Development

EXPORT PIPELINE - PIPELINE
DETAIL DRAWING
WELD PACK INSULATION KITS

POINT THOMSON ALASKA

USPT-WP-YDPA-060002 THRU 060009

DATE 12/11 SCALE NONE

WorleyParsons FLUOR Baker


1 of 1 10

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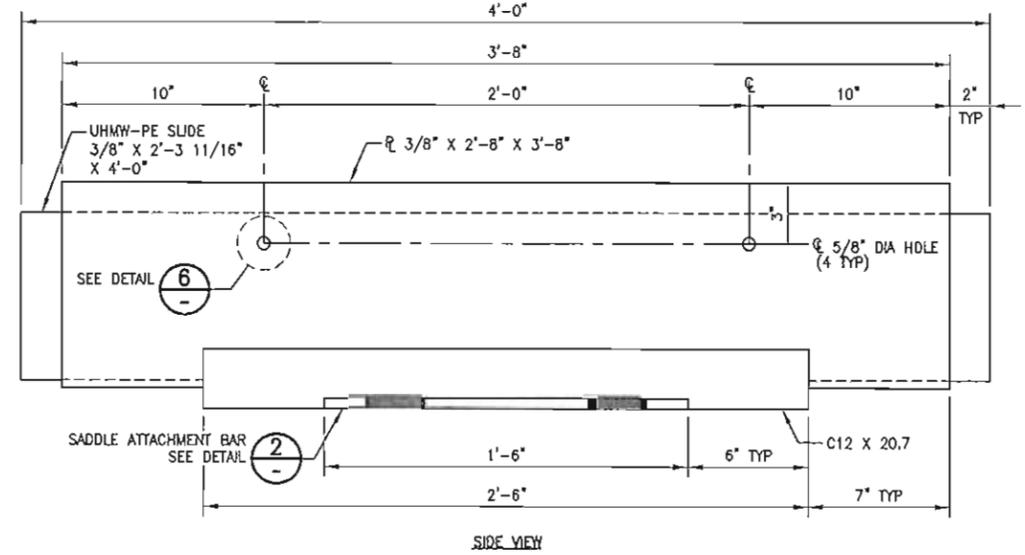
FILENAME: USPT-WP-YDDET-060009-001

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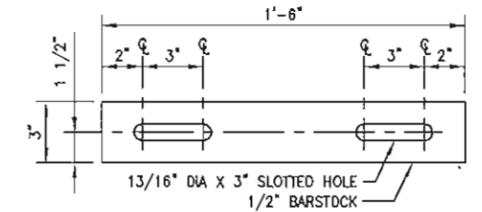
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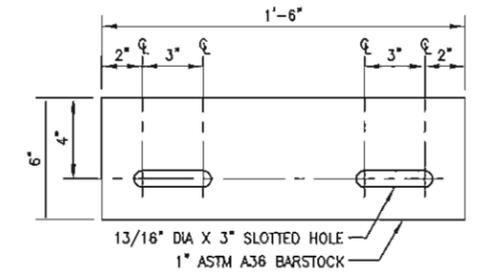
END VIEW




SIDE VIEW

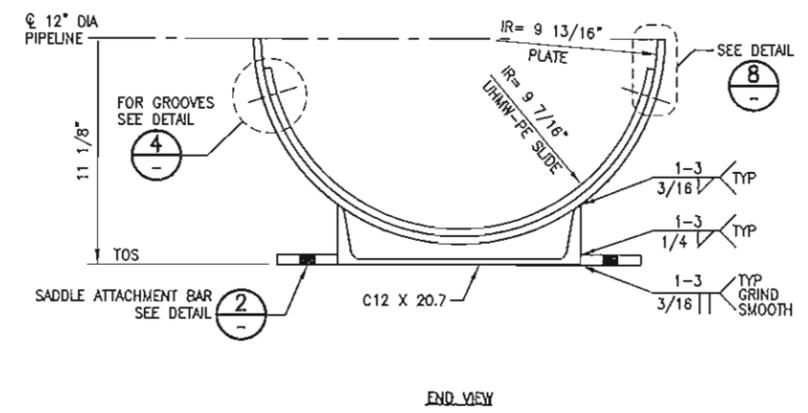


2 SADDLE ATTACHMENT BAR DETAIL
SCALE: 3" = 1'-0"




3 SHIM ATTACHMENT BAR DETAIL
SCALE: 3" = 1'-0"

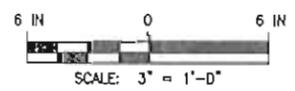


1 TYPICAL GUIDED SADDLE DETAIL
USPT-WP-YDDET-060010 SCALE: 3" = 1'-0"

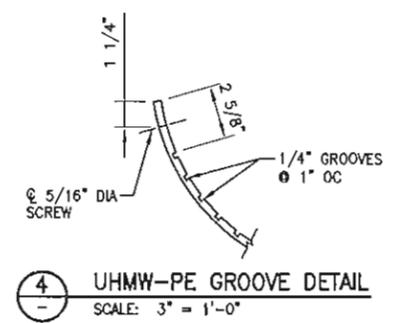


4 UHMW-PE GROOVE DETAIL
SCALE: 3" = 1'-0"

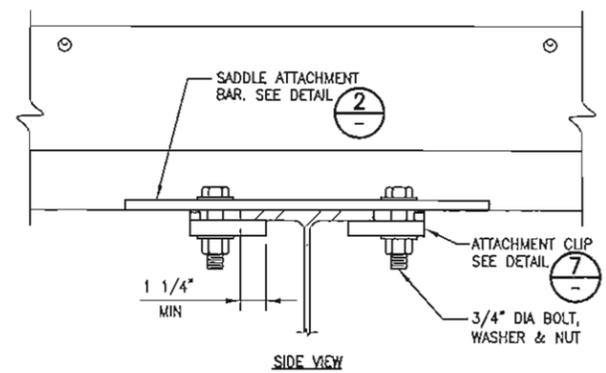


5 SADDLE ATTACHMENT DETAIL
SCALE: 3" = 1'-0"

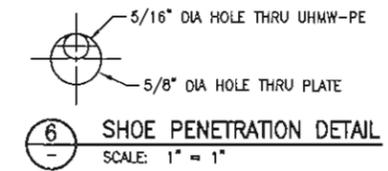


6 SHOE PENETRATION DETAIL
SCALE: 1" = 1"

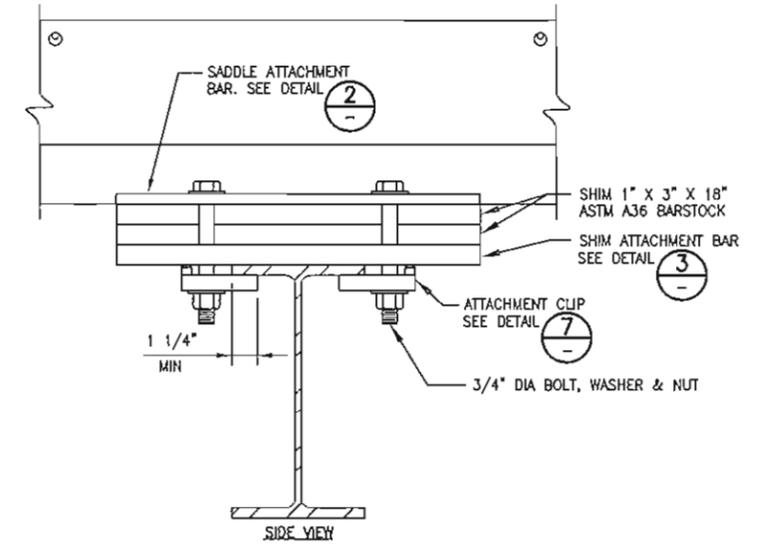

9 SADDLE SHIM DETAIL
SCALE: 3" = 1'-0"

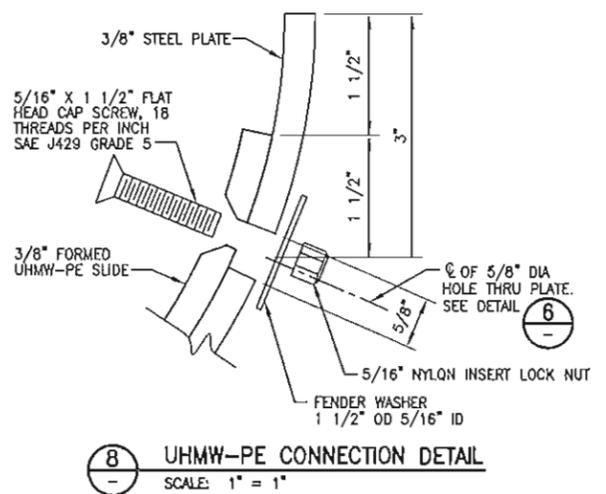

8 UHMW-PE CONNECTION DETAIL
SCALE: 1" = 1"

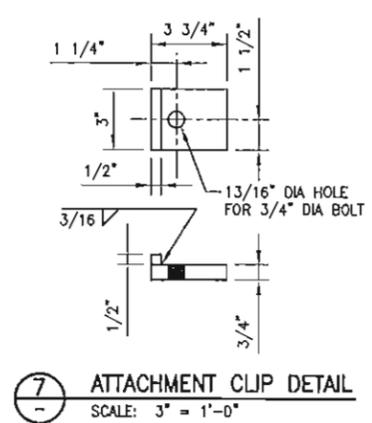

7 ATTACHMENT CLIP DETAIL
SCALE: 3" = 1'-0"

SADDLE NOTES

1. DRILL OR PUNCH (4) 5/8" DIA HOLES THRU 3/8" STEEL PLATE.
2. DRILL AND INSTALL UHMW-PE AT ROOM TEMPERATURE (APPROX. 65° F).
3. CLAMP UHMW-PE AS REQUIRED TO ENSURE A CLOSE FIT BEFORE DRILLING.
4. DRILL 5/16" DIA HOLE THRU UHMW-PE AT THE TOP CENTER OF THE 5/8" DIA HOLE.
5. COUNTERSINK INNER SURFACE OF UHMW-PE FOR FLAT HEAD SCREW. USE 5/8 X 3/2" COUNTERSINK BIT, TO A DEPTH OF 1/4". TOP SURFACE OF SCREW MUST BE BELOW UHMW-PE SURFACE.
6. INSTALL SCREW, WASHER AND NUT. TORQUE NUT TO A SNUG FIT, THEN LOOSEN BY ONE TURN.
7. ALL BOLTS 3/4" DIA OR LARGER SHALL BE ASTM A32D GRADE L7 WITH ASTM A194 GRADE 7 S4 NUT AND F436 WASHERS. ALL SADDLE PLATES AND SHAPES SHALL BE ASTM A36.

ATTACHMENT NOTES

1. TORQUE BOLTS PER AISC TURN-OF-NUT TENSIONING.
2. CENTER SADDLE LENGTHWISE ON THE BEAM.

REFERENCE DRAWINGS	DESCRIPTION
USPT-WP-YDDET-060010	GUIDED AND ANCHORED SUPPORT DETAILS



REV	DATE	DESCRIPTION	BY	CHK	APPD	PROJ
10	12/28/11	ISSUED FOR CONSTRUCTION	REF	JAG	PAC	GMP


ExxonMobil
Development

WorleyParsons **FLUOR**, Baker

POINT THOMSON				ALASKA			
MODULE	DRAWN	DATE	SCALE	CHK	APPD	JAG	PAC
	R. HOBBS	12/11	AS SHOWN				
DRAWING NO. USPT-WP-YDDET-060013-001							REV
							1 of 1

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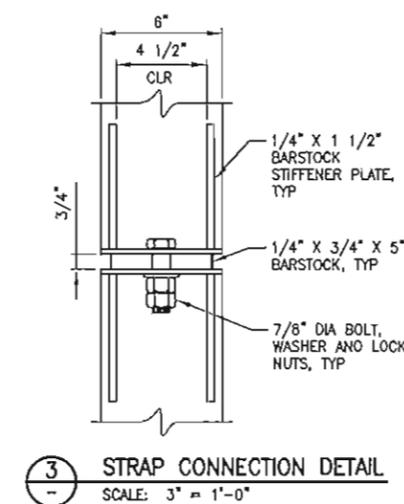
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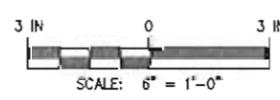
- NOTES**
1. ALL SADDLE PLATES AND SHAPES SHALL BE ASTM A36 UNLESS OTHERWISE NOTED.
 2. ALL BOLTS SHALL BE 7/8" DIA ASTM A320 GRADE L7 WITH ASTM A194 GRADE 7 S4 NUTS AND F436 WASHER. TORQUE BOLTS TO 100 FT-LB WITH SINGLE NUT AND TIGHTEN LOCK NUT.
 3. STAINLESS STEEL STRIPS SHALL HAVE A CLASS 2B FINISH.
 4. FOR THE COMPLETE SPECIFICATIONS OF THE PIPE SLIDE PLATE, SEE SPECIFICATION USPT-WP-YSPDS-000030.

1 TYPICAL SLIDING SADDLE DETAIL
USPT-WP-YDDET-060011 SCALE: 6" = 1'-0"

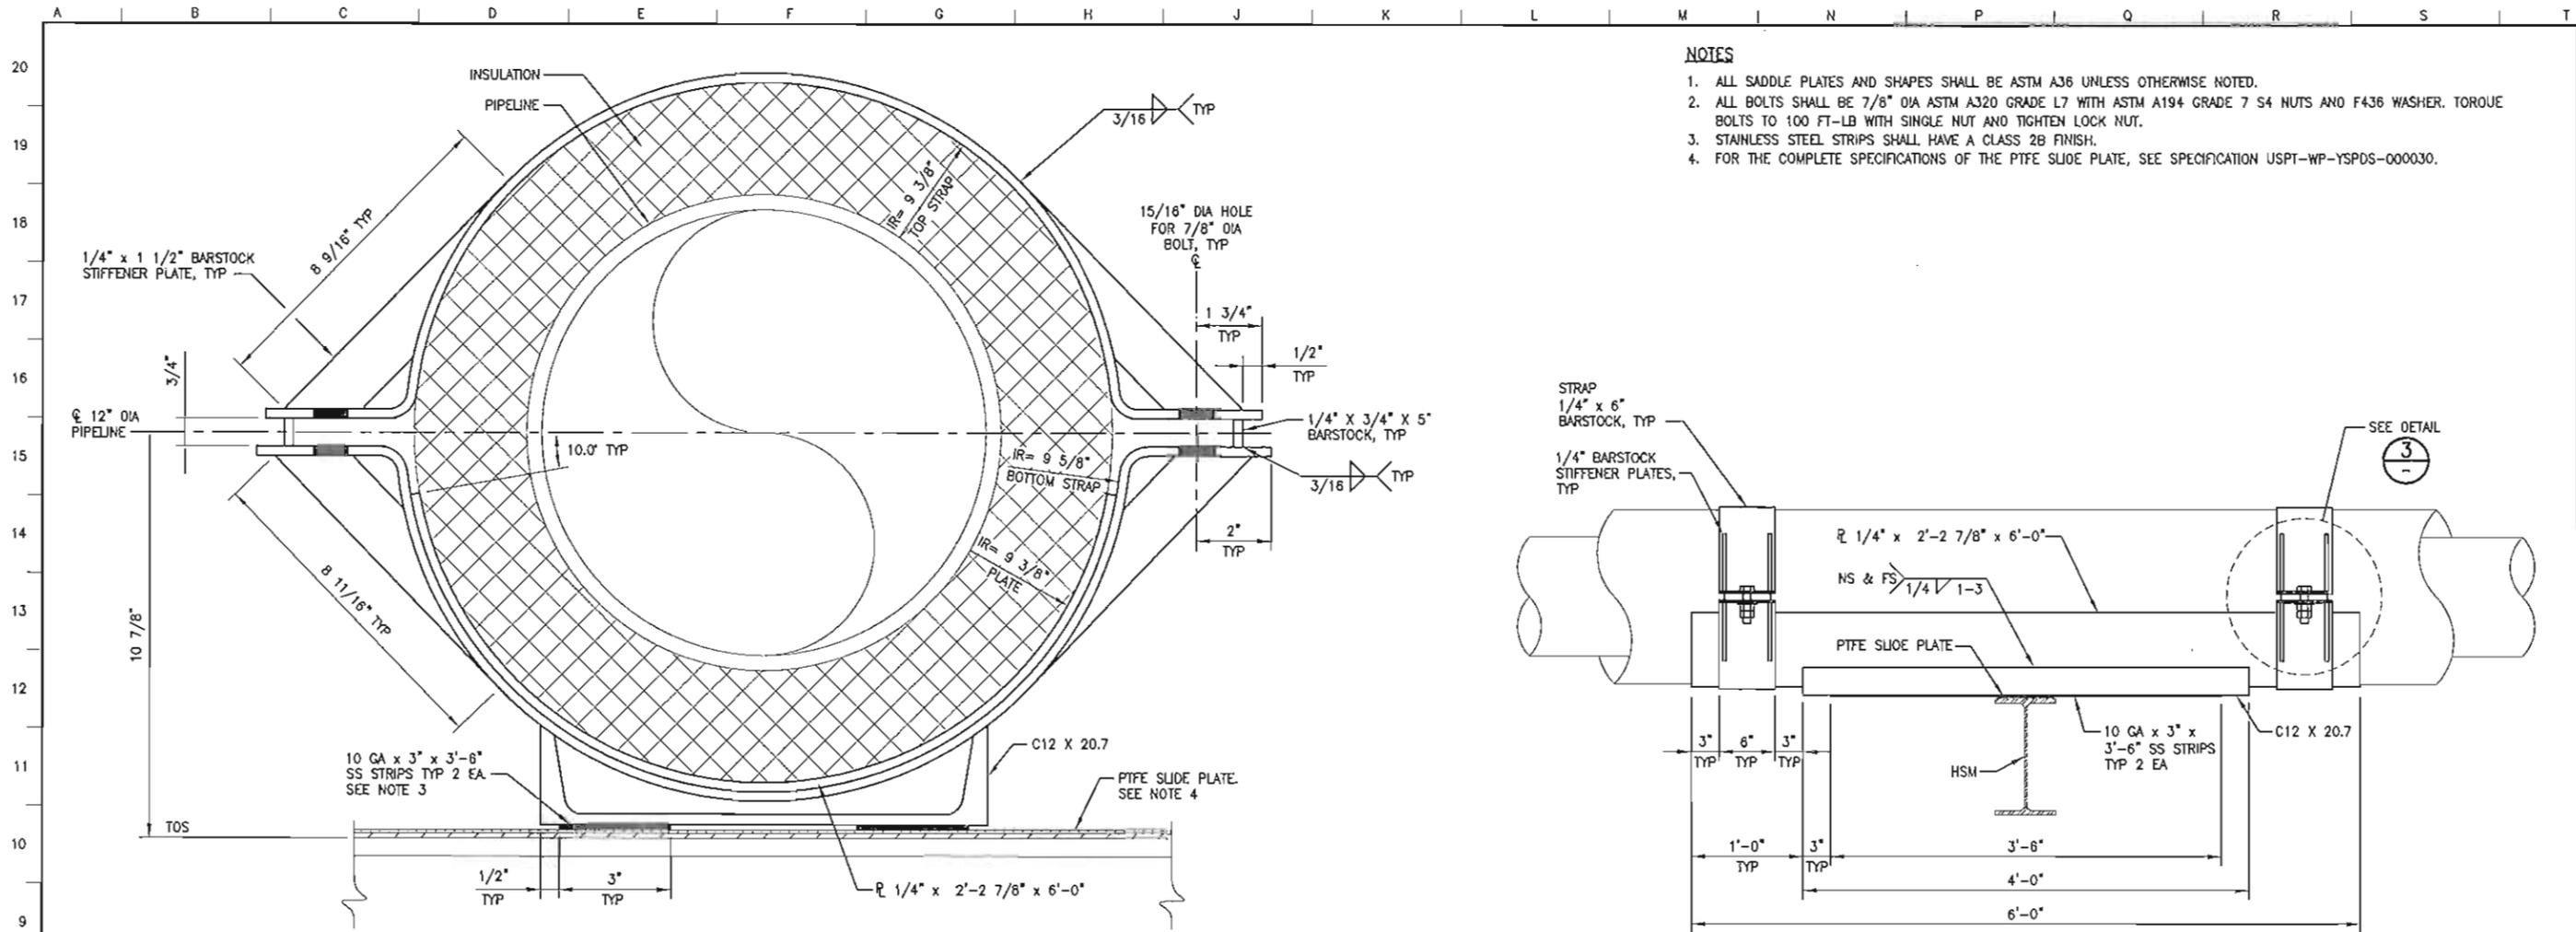2 TYPICAL SLIDING SADDLE ELEVATION
SCALE: 1 1/2" = 1'-0"



3 STRAP CONNECTION DETAIL
SCALE: 3" = 1'-0"



REFERENCE DRAWINGS	DESCRIPTION	REV	DATE	DESCRIPTION	BY	CHK	APPD	PROJ
USPT-WP-YDDET-060011	SLIDING SUPPORT DETAILS	10	12/28/11	ISSUED FOR CONSTRUCTION	RFH	JND	PAC	GMP


**EXPORT PIPELINE - PIPELINE
DETAIL DRAWING
SLIDING SADDLE DETAILS**

POINT THOMSON ALASKA

MODULE	R. HOBBS	DATE	12/11	SCALE	AS SHOWN	CHK	JND
DRAWING NO.	USPT-WP-YDDET-060014-001		SHEET	1	REV	1	10



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FILENAME: USPT-WP-YDDET-060014-001

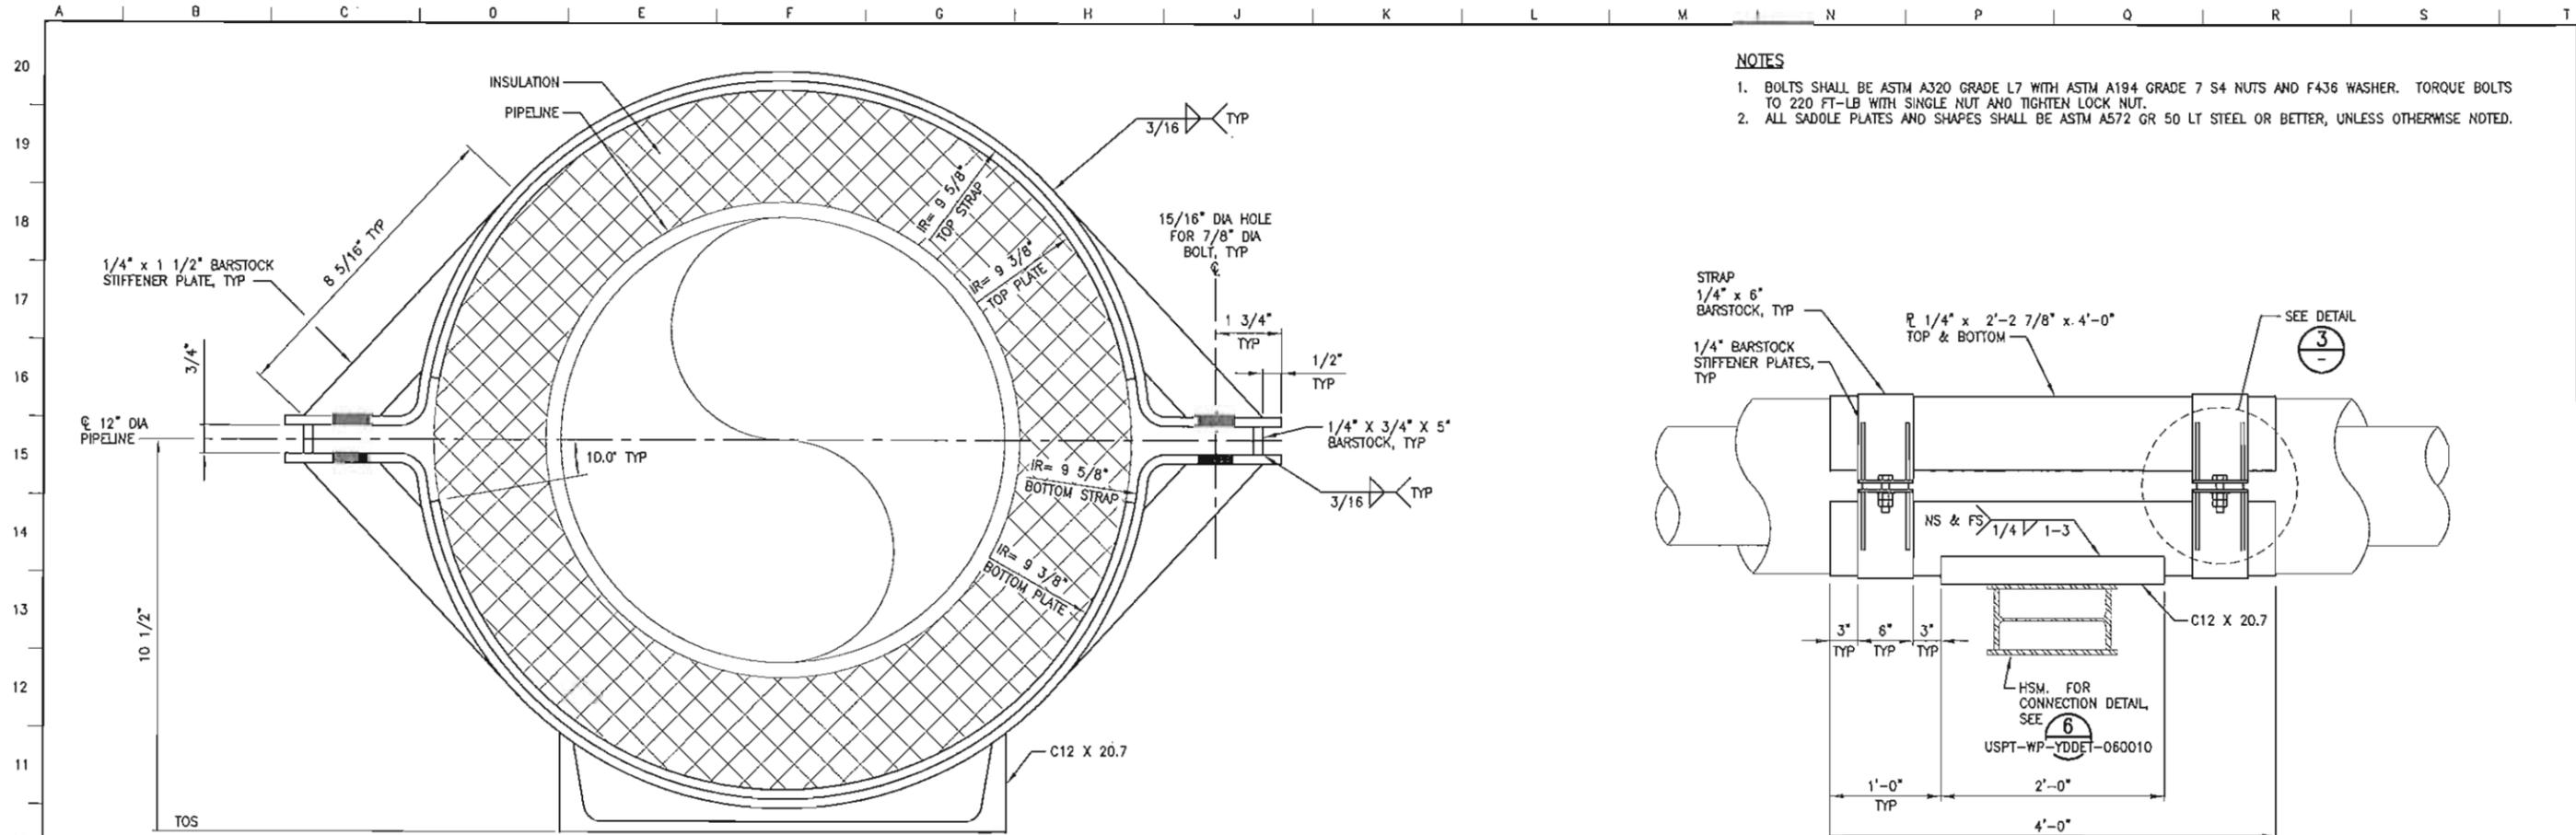

1 TYPICAL ANCHOR SADDLE DETAIL
 USPT-WP-YDDET-060010 SCALE: 6" = 1'-0"

2 TYPICAL SLIDING SADDLE ELEVATION
 SCALE: 1 1/2" = 1'-0"

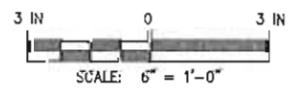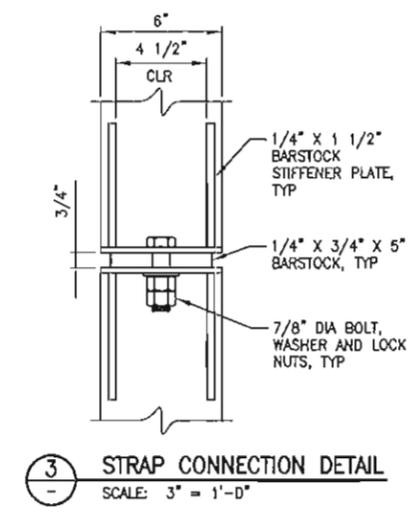

REFERENCE DRAWINGS	DESCRIPTION
USPT-WP-YDDET-060010	GUIDED AND ANCHORED SUPPORT DETAILS



REV	DATE	DESCRIPTION	BY	CHK	APPRO	PROJ
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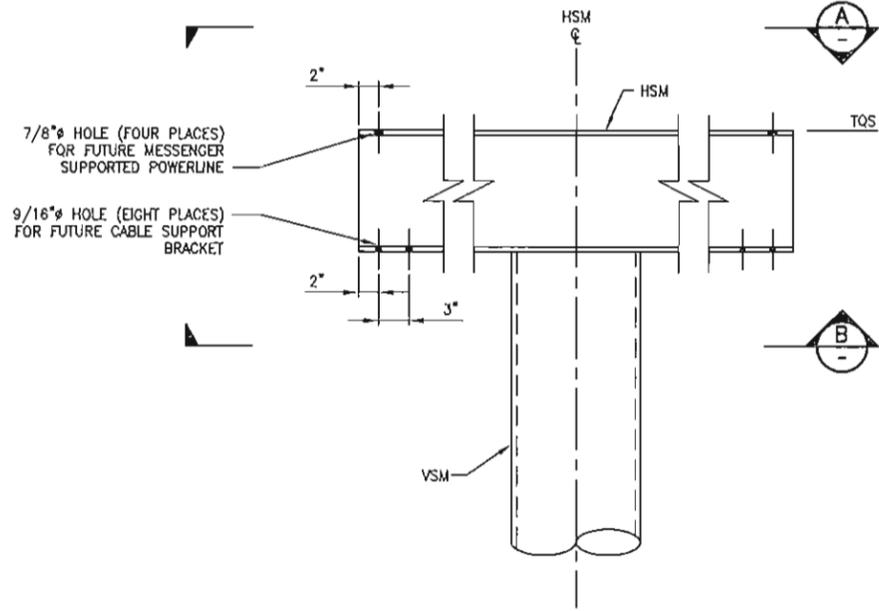
ExxonMobil
 Development

WorleyParsons **FLUOR**, Baker


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DETAIL DRAWING				ANCHOR SADDLE DETAILS			
MODULE	DRWN	DATE	SCALE	CHK	JWG	APPRO	PAC
USPT-WP-YDDET-060015-001	R. HOBBS	12/11	AS SHOWN				
DRAWING NO.						SHEET	REV
USPT-WP-YDDET-060015-001						1 of 1	10

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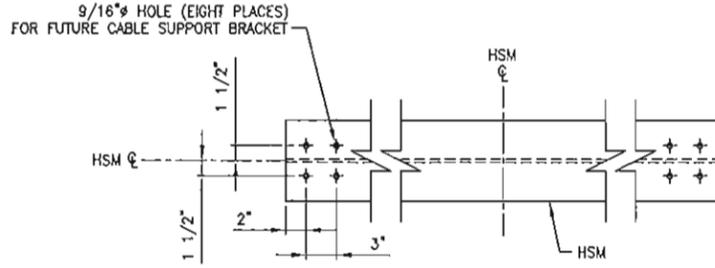
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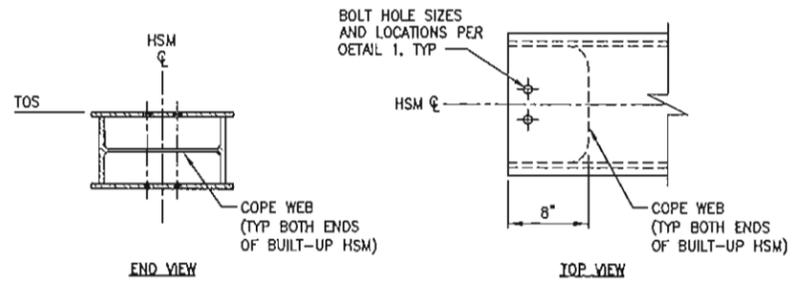
1 HSM SIDE VIEW
 USPT-WP-YDDET-060010
 USPT-WP-YDDET-060011
 NOT TO SCALE



A HSM TOP VIEW
 NOT TO SCALE

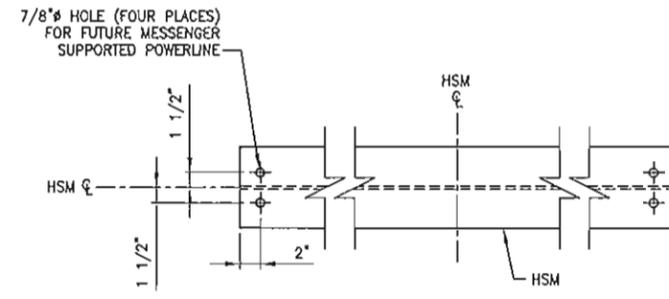

B HSM BOTTOM VIEW
 NOT TO SCALE



2 W12x35 BUILT-UP HSM COPING DETAIL
 USPT-WP-YDDET-060010
 NOT TO SCALE

NOTES
 1. ATTACHMENT CONCEPT DEVELOPED BY DRYDEN & LARUE, INC. CONSULTING ENGINEERS.

SCHEDULE/QUANTITY HSM'S REQUIRING BOLT HOLES FOR MESSENGER/ELEC ATTACHMENT SUPPORTS 5007 THRU 5432			
SUPPORT TYPE	HSM TYPE	HSM LENGTH (FT)	QUANTITY
XA-08	W12x35 BUILT-UP	8	10
XA-11	W12x35 BUILT-UP	11	2
XG-08	W12x50	8	347
XG-11	W12x50	11	22
XS-12	W12x35	12	21
XS-15	W12x35	15	18
XS-18	W12x35	18	6

REFERENCE DRAWINGS	DESCRIPTION
USPT-WP-YDDET-060010	GUIDED AND ANCHORED SUPPORT DETAILS
USPT-WP-YDDET-060011	SLIDING SUPPORT DETAILS



REV	DATE	DESCRIPTION	BY	CHK	APPD	PROJ
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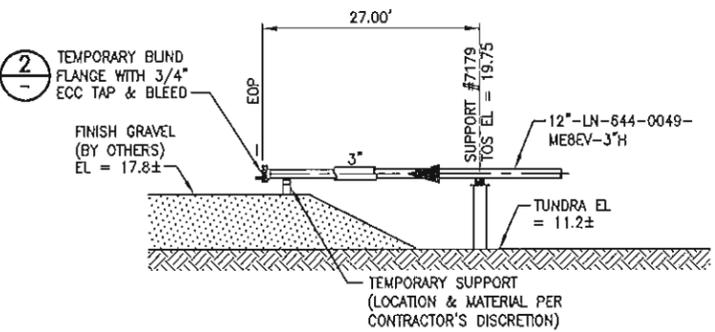
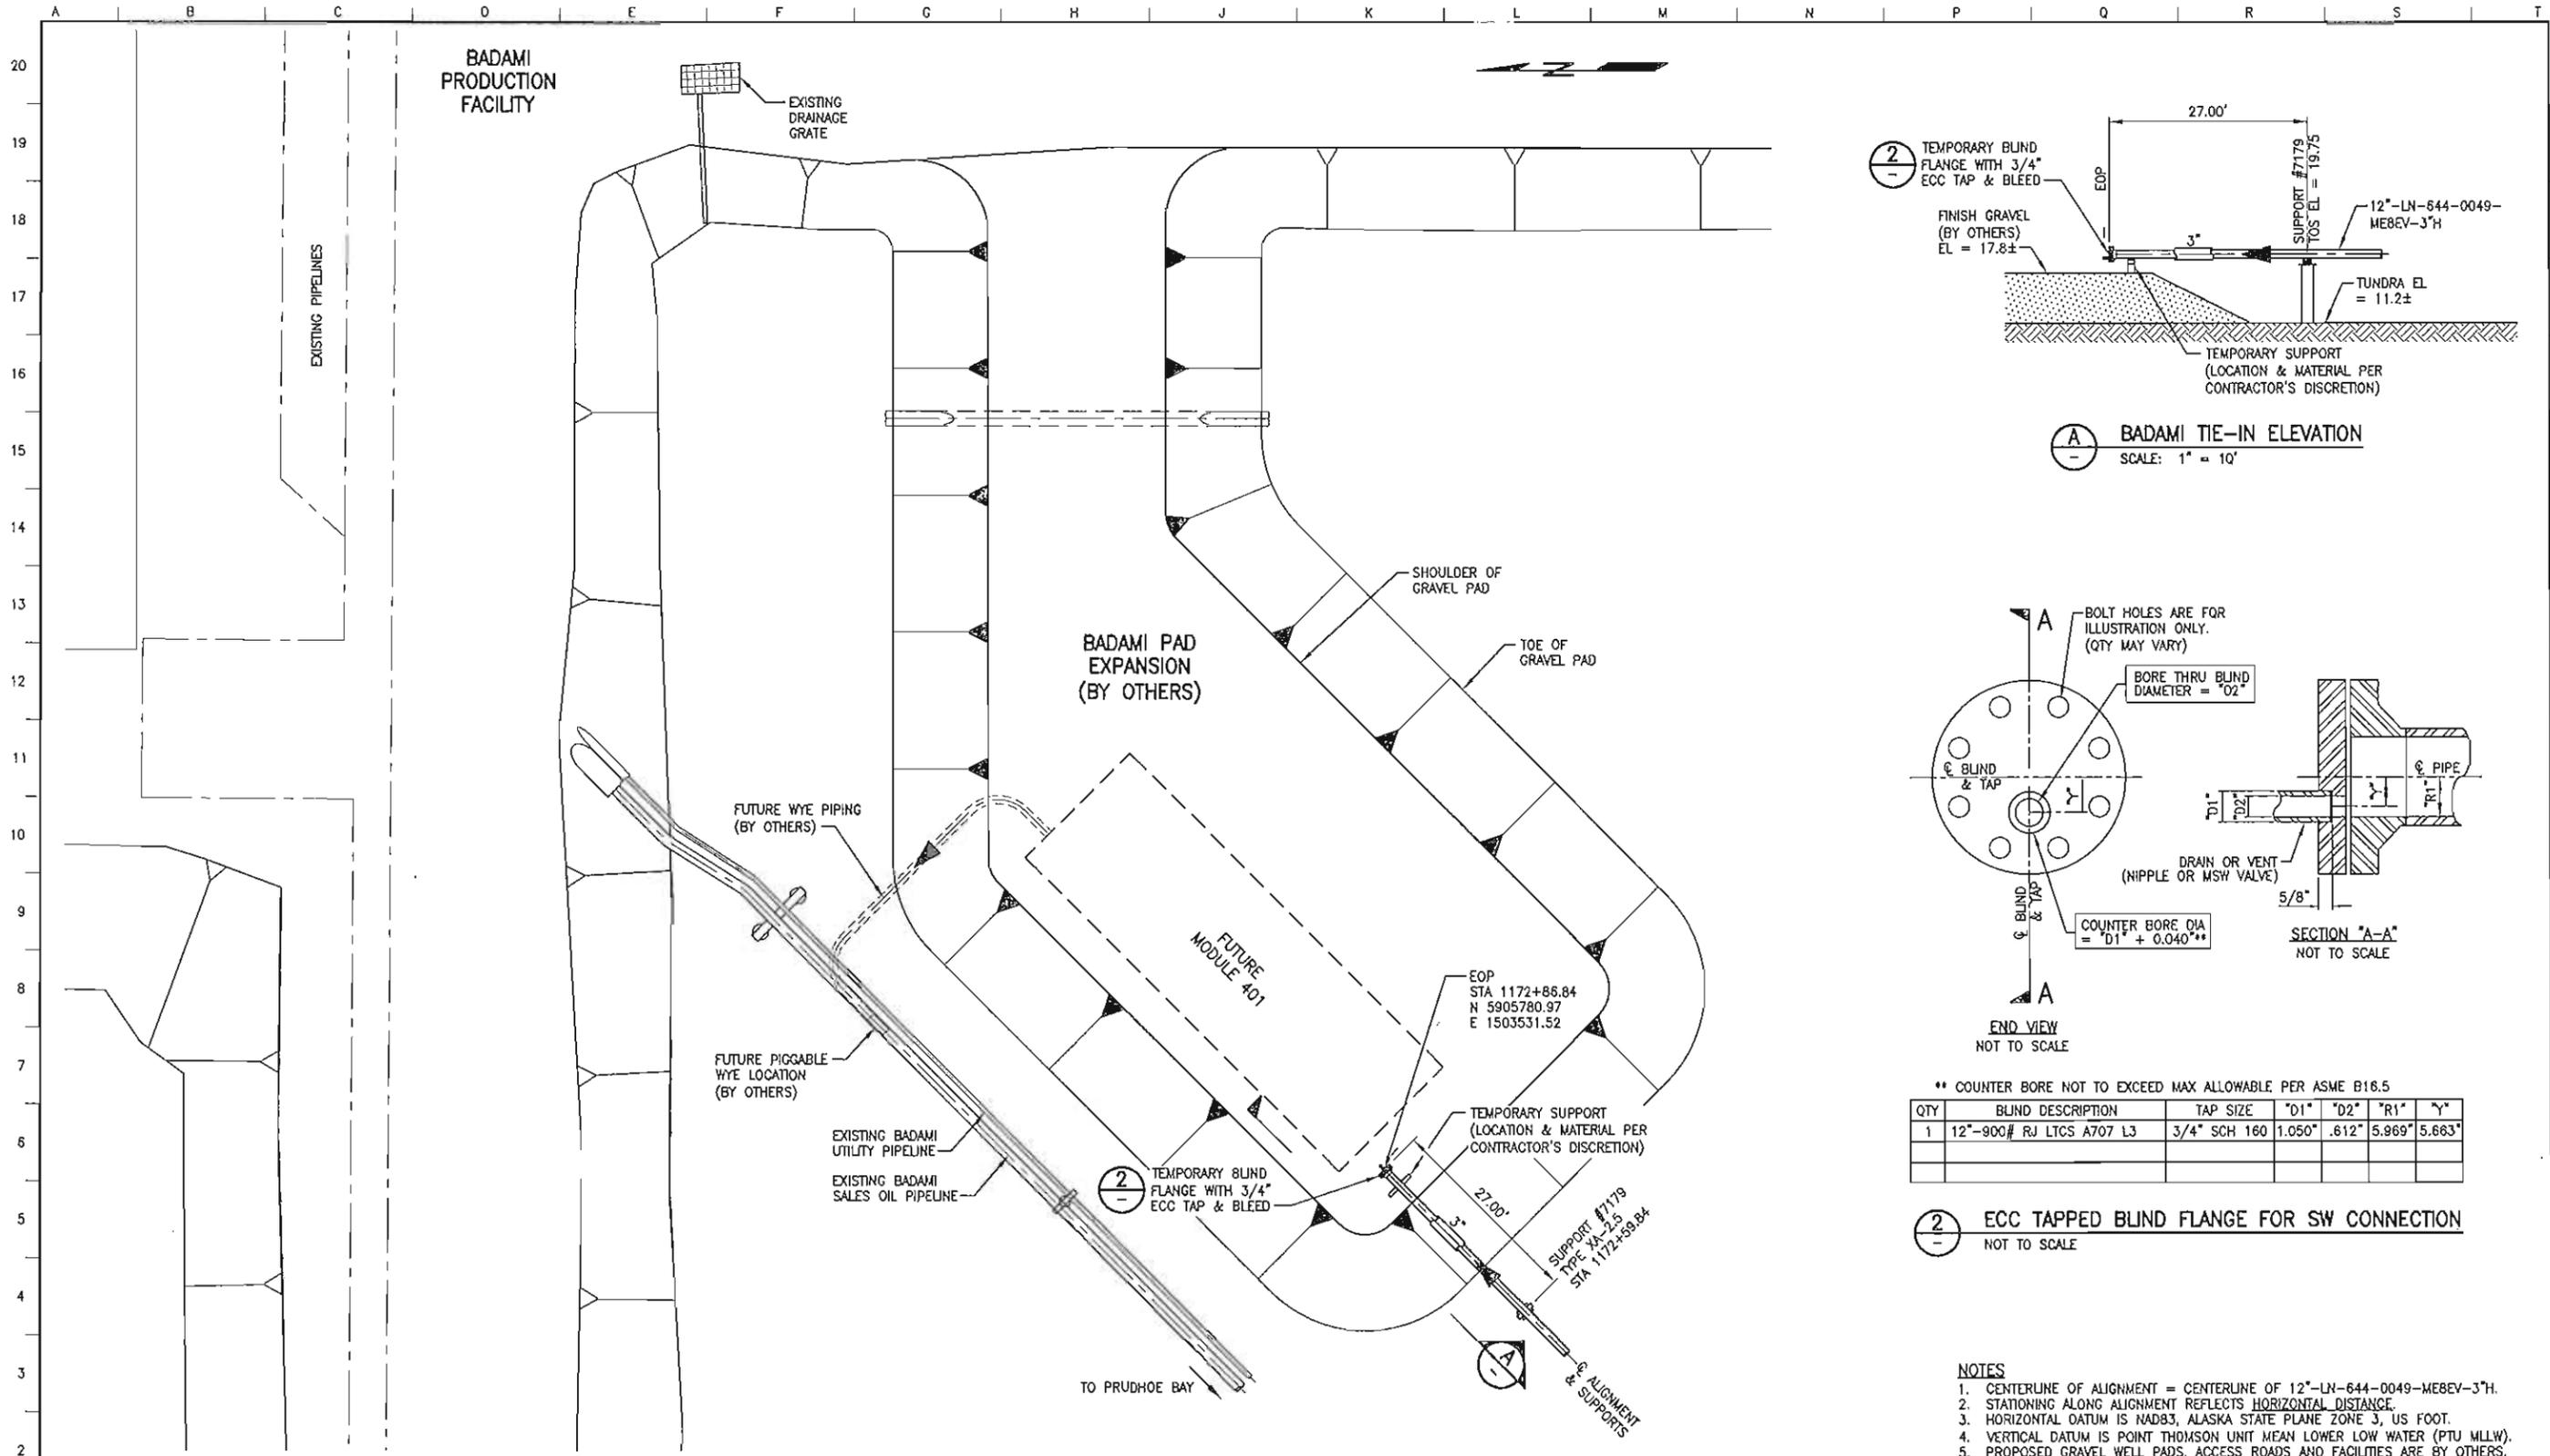
ExxonMobil
Development

WorleyParsons **FLUOR** **Baker**


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POINT THOMSON				ALASKA			
MODULE	DRAWN	DATE	SCALE	CHK	APPD	PAID	REV
	R. HOBBS	12/11	NONE				
DRAWING NO. USPT-WP-YDDET-060016-001							SHEET 1 of 1

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FILENAME: USPT-WP-YDDET-060016-001



(A) BADAMI TIE-IN ELEVATION
SCALE: 1" = 10'

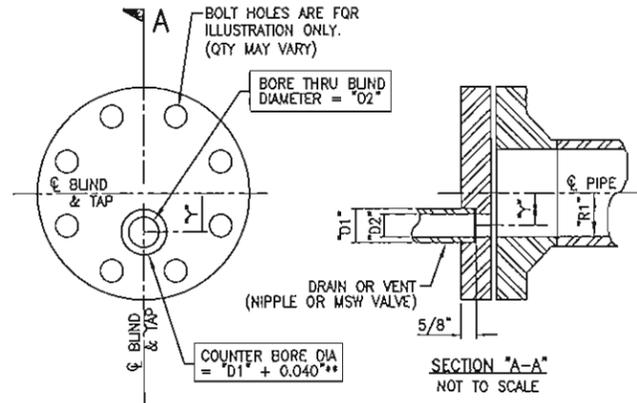


** COUNTER BORE NOT TO EXCEED MAX ALLOWABLE PER ASME B16.5

QTY	BLIND DESCRIPTION	TAP SIZE	"D1"	"D2"	"R1"	"Y"
1	12"-900# RJ LTCS A707 L3	3/4" SCH 160	1.050"	.612"	5.969"	5.663"

(2) ECC TAPPED BLIND FLANGE FOR SW CONNECTION
NOT TO SCALE

- NOTES**
- CENTERLINE OF ALIGNMENT = CENTERLINE OF 12"-LN-644-0049-ME8EV-3"H.
 - STATIONING ALONG ALIGNMENT REFLECTS HORIZONTAL DISTANCE.
 - HORIZONTAL DATUM IS NAD83, ALASKA STATE PLANE ZONE 3, US FOOT.
 - VERTICAL DATUM IS POINT THOMSON UNIT MEAN LOWER LOW WATER (PTU MLLW).
 - PROPOSED GRAVEL WELL PADS, ACCESS ROADS AND FACILITIES ARE BY OTHERS.

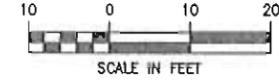

(1) BADAMI TIE-IN PLAN
USPT-WP-YDPAL-080039 SCALE: 1" = 10'

REFERENCE DRAWINGS	DESCRIPTION
USPT-WP-YDPAL-080039	PLAN & PROFILE




REV	DATE	DESCRIPTION	BY	CHK	APPD	PROJ
10	12/28/11	ISSUED FOR CONSTRUCTION	RFH	JMG	PAG	GMP



PT FACILITIES AT BADAMI - PIPELINE				ALASKA			
MODULE	DRAWN	DATE	SCALE	CHK	APPD	JWG	PAC
	R. HOBBS	12/11	AS SHOWN				
DRAWING NO.	USPT-WP-YDDET-110001-001			SHEET	1 of 1		
REV				10			

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FILENAME: USPT-WP-YDDET-110001-001

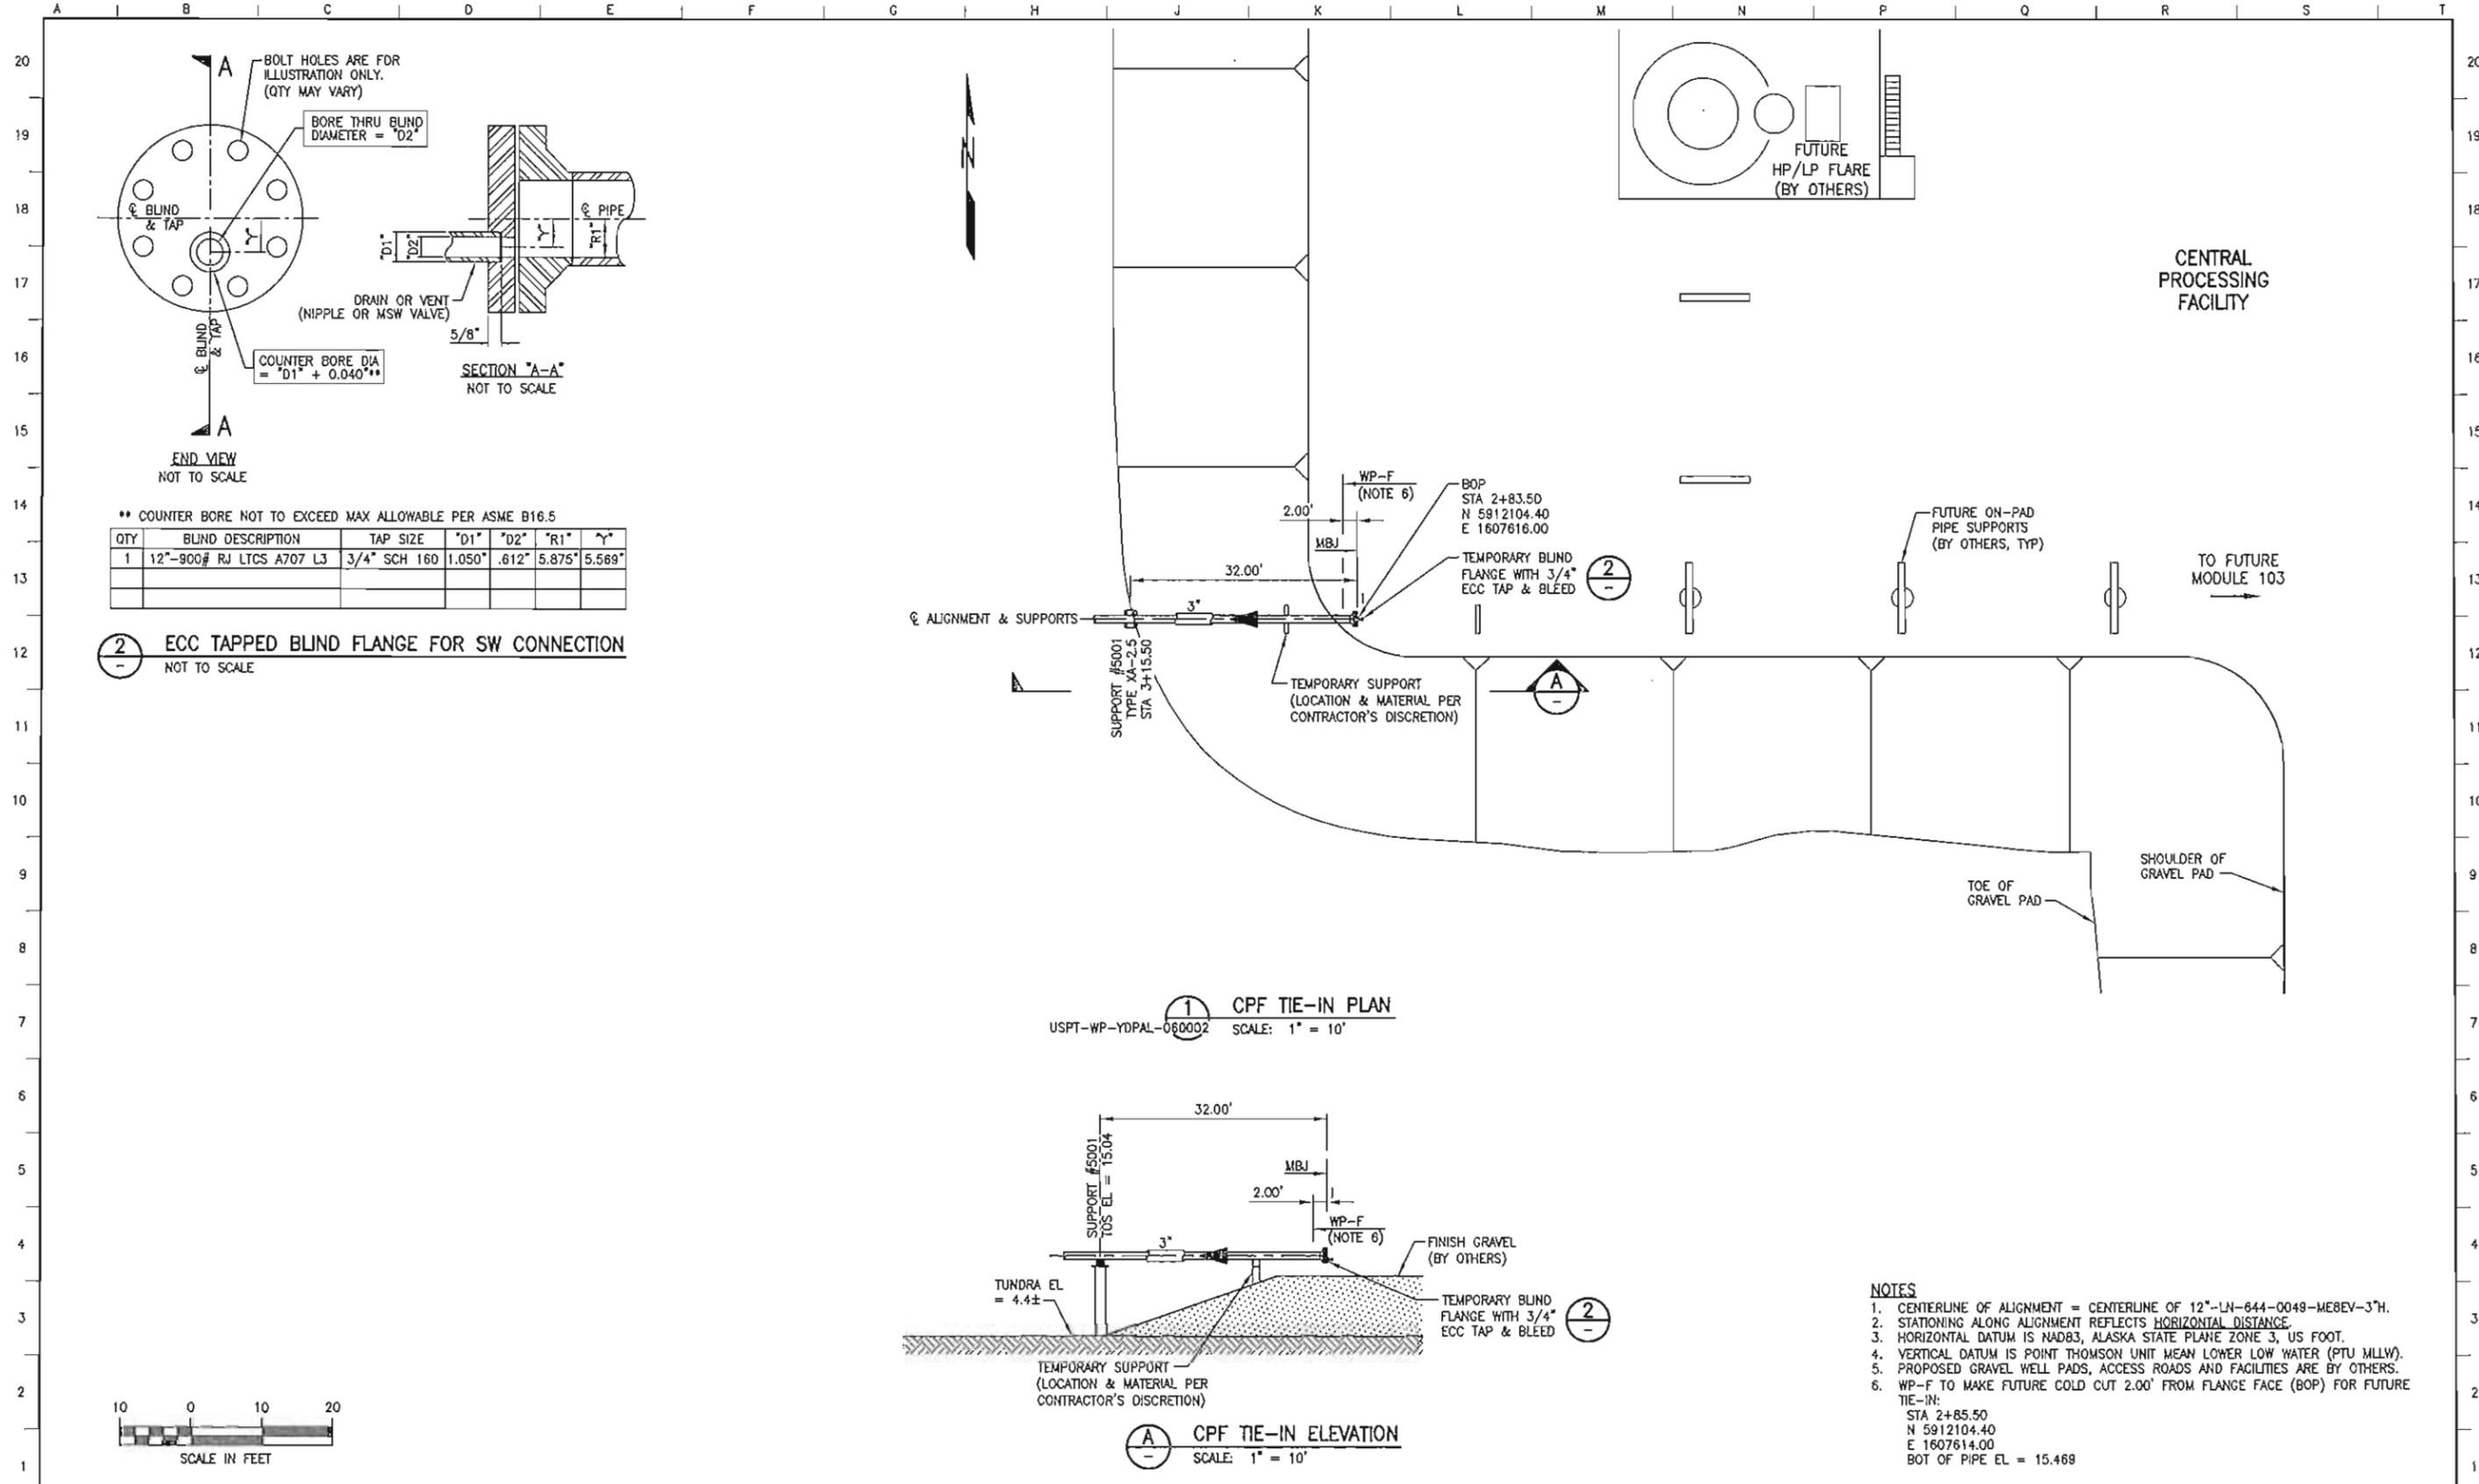

** COUNTER BORE NOT TO EXCEED MAX ALLOWABLE PER ASME B16.5


QTY	BLIND DESCRIPTION	TAP SIZE	"D1"	"D2"	"R1"	"Y"
1	12"-900# RJ LTCS A707 L3	3/4" SCH 160	1.050"	.612"	5.875"	5.569"

2 - ECC TAPPED BLIND FLANGE FOR SW CONNECTION
NOT TO SCALE

1 - CPF TIE-IN PLAN
USPT-WP-YDPAL-060002 SCALE: 1" = 10'

A - CPF TIE-IN ELEVATION
SCALE: 1" = 10'


- NOTES**
- CENTERLINE OF ALIGNMENT = CENTERLINE OF 12"-LN-644-0049-ME8EV-3"H.
 - STATIONING ALONG ALIGNMENT REFLECTS HORIZONTAL DISTANCE.
 - HORIZONTAL DATUM IS NAD83, ALASKA STATE PLANE ZONE 3, US FOOT.
 - VERTICAL DATUM IS POINT THOMSON UNIT MEAN LOWER LOW WATER (PTU MLLW).
 - PROPOSED GRAVEL WELL PADS, ACCESS ROADS AND FACILITIES ARE BY OTHERS.
 - WP-F TO MAKE FUTURE COLD CUT 2.00' FROM FLANGE FACE (BOP) FOR FUTURE TIE-IN:
STA 2+85.50
N 5912104.40
E 1607614.00
BOT OF PIPE EL = 15.469

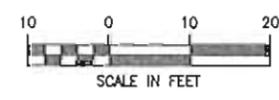

REFERENCE DRAWINGS	DESCRIPTION
USPT-WP-YDPAL-060002	PLAN & PROFILE



REV	DATE	DESCRIPTION	BY	CHK	APPD	PROJ
10	12/28/11	ISSUED FOR CONSTRUCTION	RFH	JAG	PAC	GMP

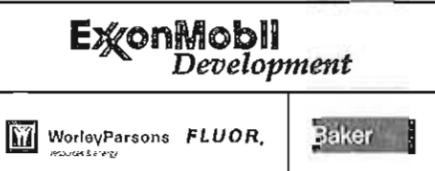


EXPORT PIPELINE FACILITIES AT CPF -- PIPELINE				ALASKA			
MODULE	DRAWN	DATE	SCALE	CHK	APPD	JWG	PAC
	R. HOBBS	12/11	AS SHOWN				
DRAWING NO.	SHEET		REV				
USPT-WP-YDPAL-280001-001	1 of 1		10				

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FILENAME: USPT-WP-YDPAL-280001-001

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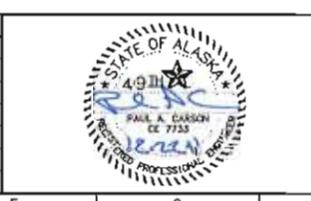


BILL OF MATERIAL										
ITEM	S/F	QUANTITY	SIZE	SCH/RTG	DESCRIPTION					ITEM ID
1	F	160 LF	12"	0.406"WT	PIPE LTCS API 5L X65Q-PSL2 HFW BE					20
2	F	4	12"	0.406"WT	10.31MM (0.406") WT 836.10M CVN ϕ -46C(-50F)					19
					INDUCTION BEND LTCS API 5L X65Q-PSL2 HFW BE					
					12.70 MM (0.500") WT 836.10M 90 DEG 5D WITH					
					20 TANGENTS EA END CVN ϕ -46C(-50F)					
3	F	2	12"		SADDLE SLIDING SEE DWG					18
					USPT-WP-YDDET-060014-001 FOR DETAILS.					
4	F	2	12"		SADDLE GUIDED SEE DWG					18
					USPT-WP-YDDET-060013-001 FOR DETAILS.					

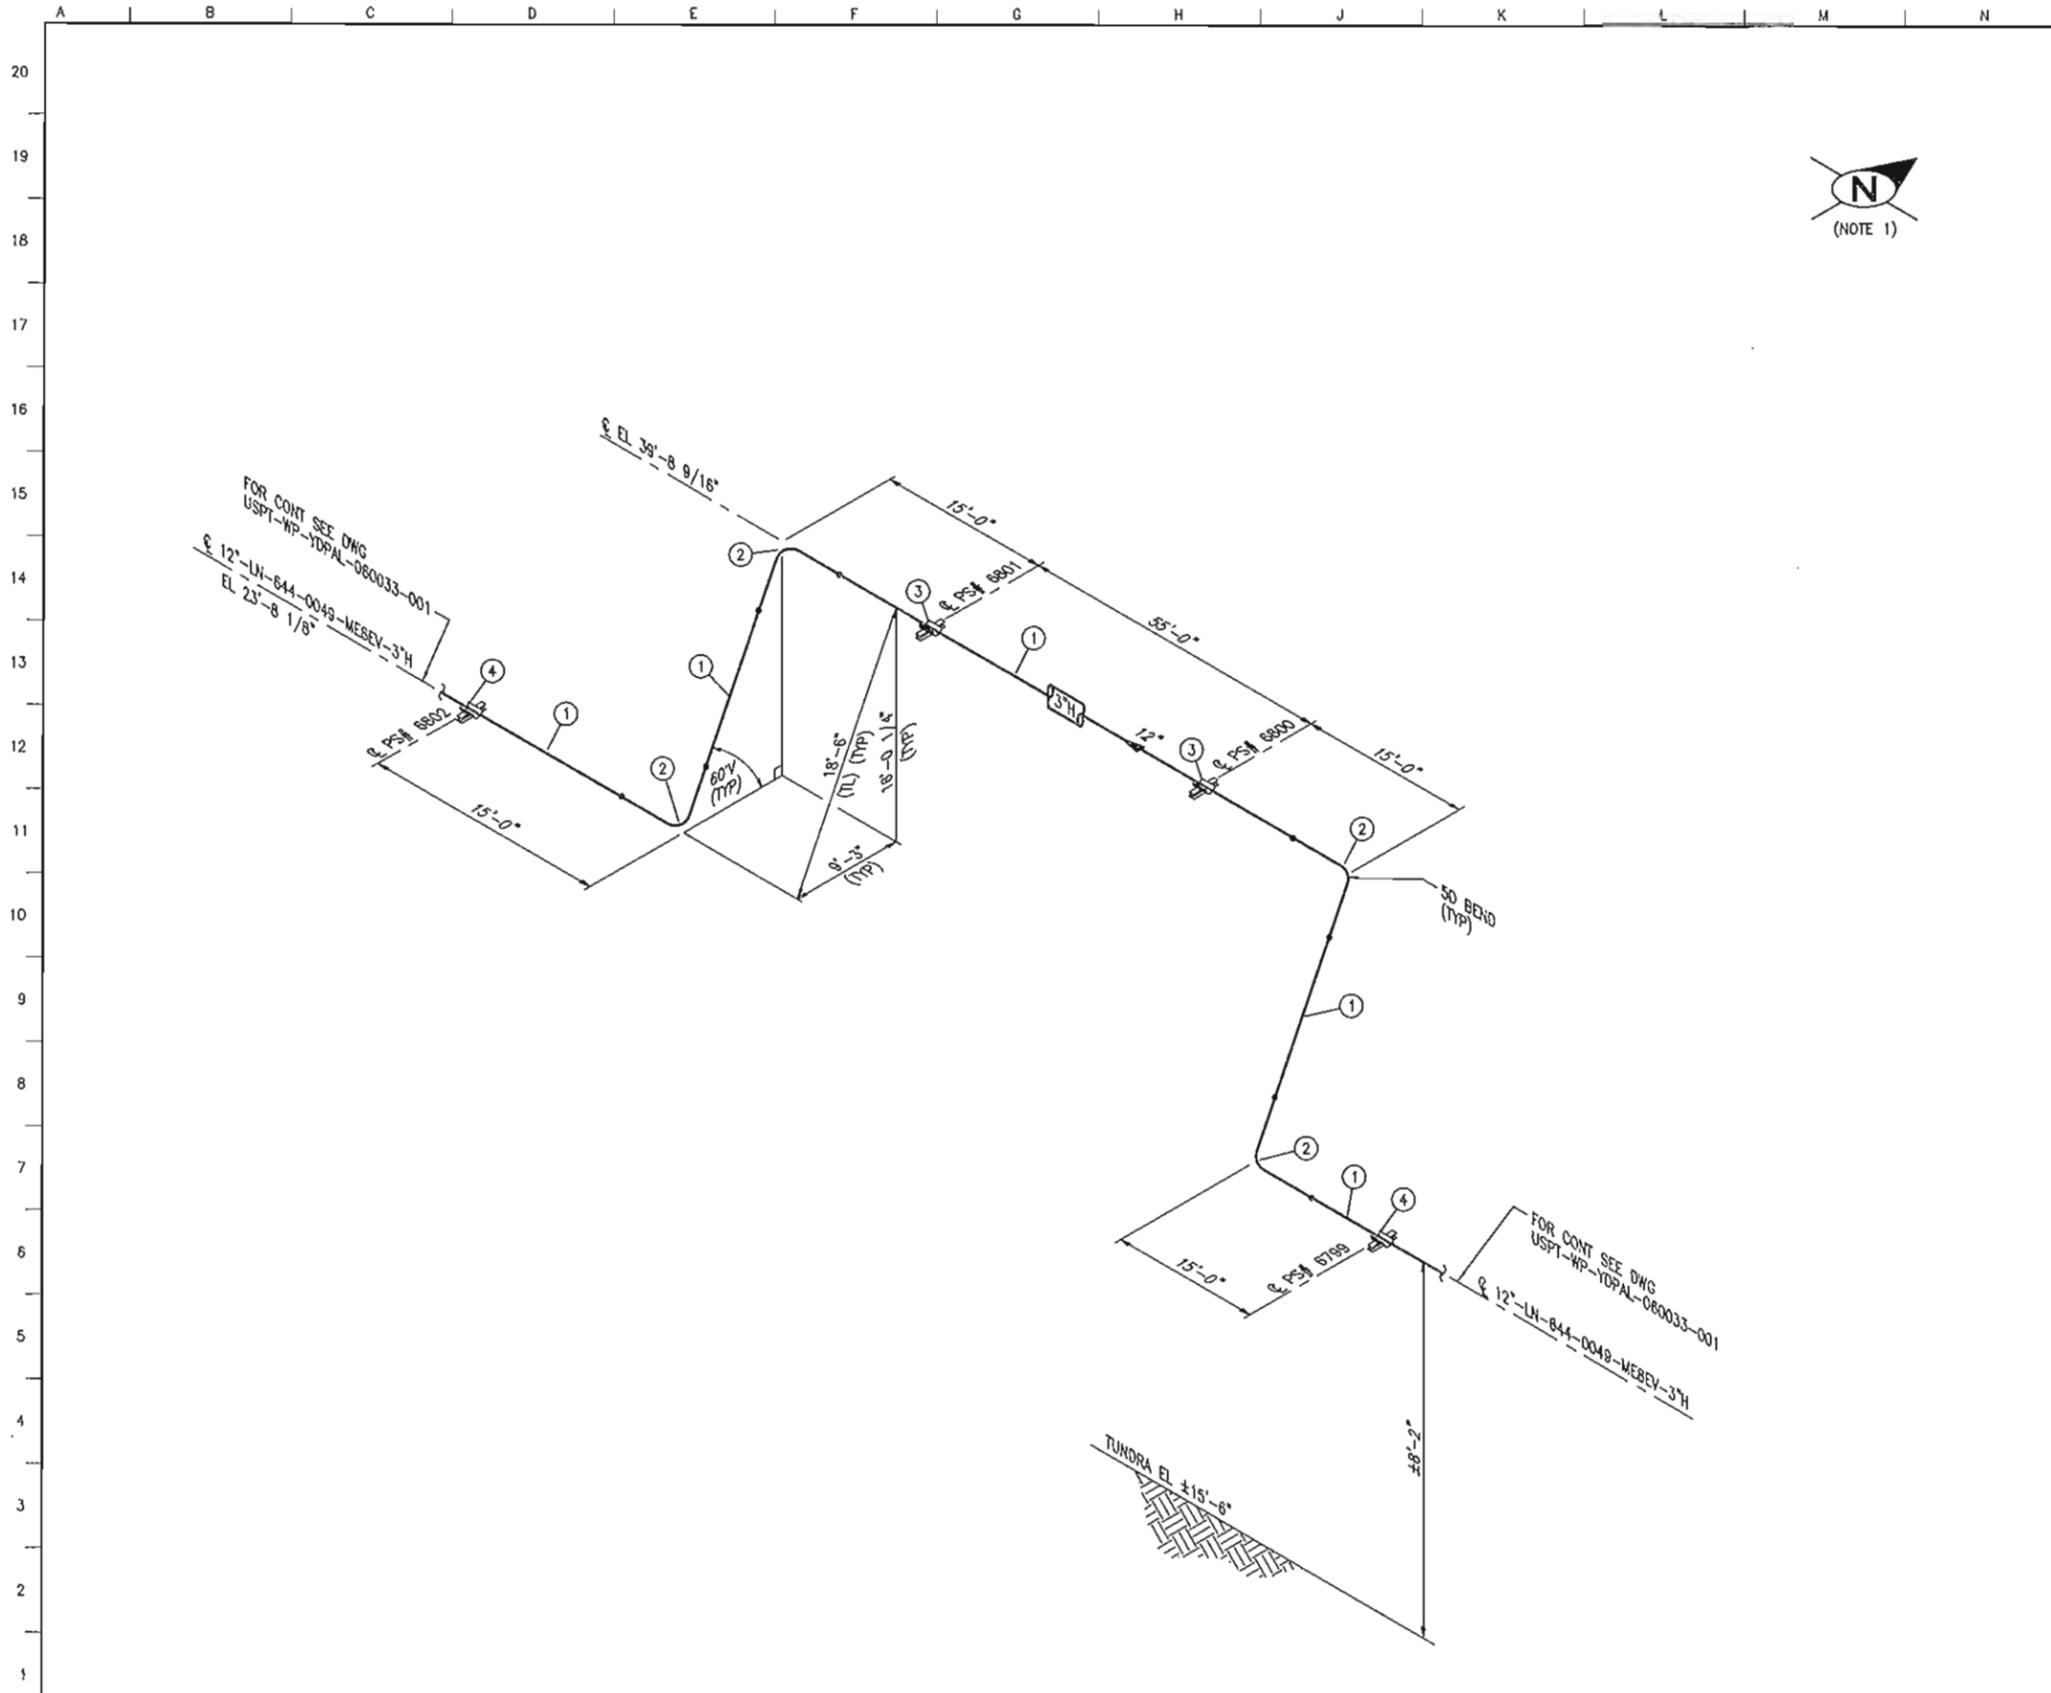DESIGN DATA		
CODE: B31.4	CLEAR: PER SPEC	WELD PROC: PER SPEC
CLASS: ME8EV	PAINT: FBE	STRESS RELIEVE: NO
DESIGN PRESS: 2035 PSIG	INSULATION: 3"H	NUMBER OF WELDS:
DESIGN TEMP: 200° F	HYDRO TEST: 3053 PSIG	
OPERATING PRESS: 325 PSIG	X-RAY QTY: PER SPEC	SERVICE: CONDENSATE
OPERATING TEMP: 150° F	INTERP: B31.4	
LINE NO.: 12"-LN-644-0049-ME8EV-3"H		
PLN NO.: USPT-WP-YDDET-060002-001		

NOTES:
1. NORTH ARROW SHOWN FOR REFERENCE ONLY. SEE DWG USPT-WP-YDPAL-060033-001 FOR ACTUAL ORIENTATION.

REFERENCE DRAWINGS	DESCRIPTION
USPT-WP-YDPAL-060033	PLAN & PROFILE
USPT-WP-YDDET-060002	VERTICAL LOOPS




REV	DATE	DESCRIPTION	BY	CHK	APPD	PROJ
10	12/28/11	ISSUED FOR CONSTRUCTION	JNA	JAG	PAC	GMP

ExxonMobil
Development

WorleyParsons **FLUOR**, **Baker**

EXPORT PIPELINE - PIPELINE ISOMETRIC					
BADAMI CREEK EAST VERTICAL LOOP					
12"-LN-644-0049-ME8EV-3"H					
POINT THOMSON			ALASKA		
MODULE	DRAWN	DATE	SCALE	CHK	JAG
	J. AUBURN	12/11	NONE	CHK	JAG
DRAWING NO. USPT-WP-YDISO-060001-001					REV
SHEET 1 of 1					10

FILENAME: USPT-WP-YDISO-060001-001

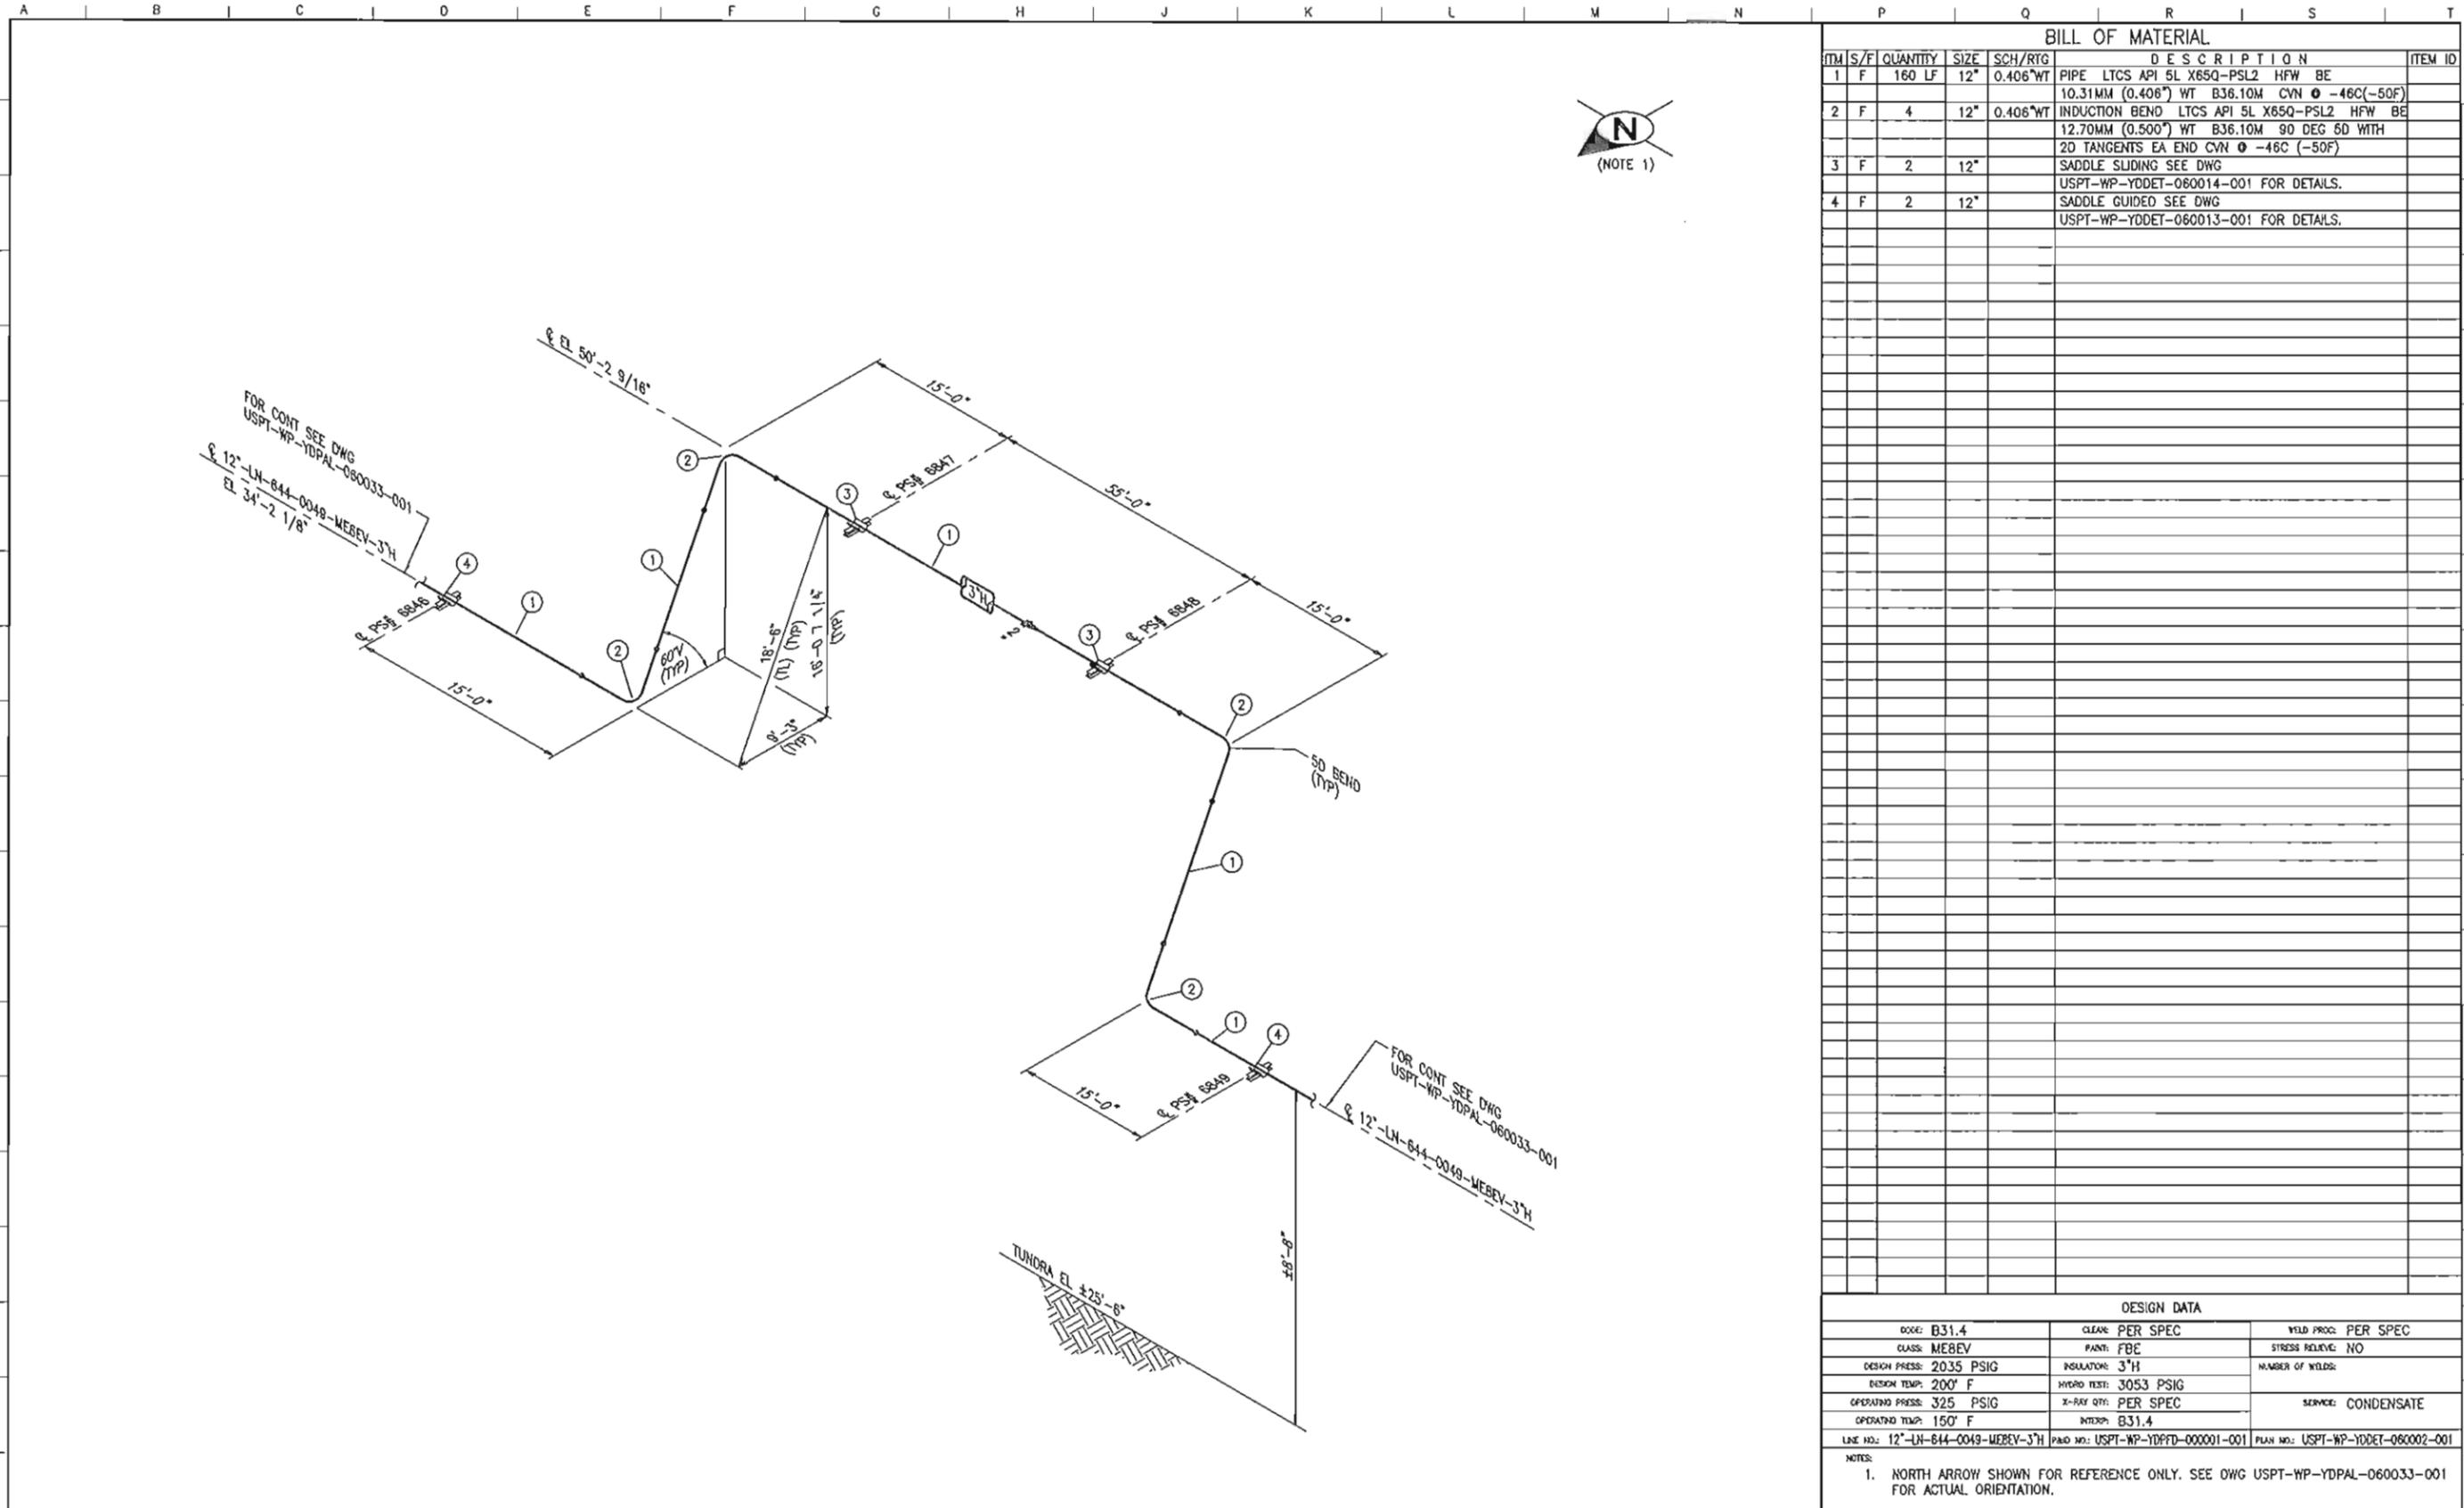

BILL OF MATERIAL										
ITEM	S/F	QUANTITY	SIZE	SCH/RTG	DESCRIPTION					ITEM ID
1	F	160 LF	12"	0.406"WT	PIPE LTCS API 5L X65Q-PSL2 HFW BE					
2	F	4	12"	0.406"WT	10.31MM (0.406") WT B36.10M CVN -46C (-50F)					
					INDUCTION BEND LTCS API 5L X65Q-PSL2 HFW BE					
					12.70MM (0.500") WT B36.10M 90 DEG 5D WITH					
					2D TANGENTS EA END CVN -46C (-50F)					
3	F	2	12"		SADDLE SLIDING SEE DWG					
					USPT-WP-YDDET-060014-001 FOR DETAILS.					
4	F	2	12"		SADDLE GUIDED SEE DWG					
					USPT-WP-YDDET-060013-001 FOR DETAILS.					

DESIGN DATA		
CODE: B31.4	CLEAR: PER SPEC	YIELD PROG: PER SPEC
CLASS: MEBEV	PAINT: FBE	STRESS RELIEVE: NO
DESIGN PRESS: 2035 PSIG	INSULATION: 3"H	NUMBER OF WELDS:
DESIGN TEMP: 200° F	HYDRO TEST: 3053 PSIG	
OPERATING PRESS: 325 PSIG	X-RAY QTY: PER SPEC	SERVICE: CONDENSATE
OPERATING TEMP: 150° F	INTEROP: B31.4	
LINE NO: 12"-LN-644-0049-MEBEV-3"H PLAN NO: USPT-WP-YDDET-060002-001		

NOTES:
1. NORTH ARROW SHOWN FOR REFERENCE ONLY. SEE DWG USPT-WP-YDPAL-060033-001 FOR ACTUAL ORIENTATION.

REFERENCE DRAWINGS	DESCRIPTION
USPT-WP-YDPAL-060033	PLAN & PROFILE
USPT-WP-YDDET-060002	VERTICAL LOOPS

REV	DATE	DESCRIPTION	BY	CHK	APPD	PROJ
10	12/28/11	ISSUED FOR CONSTRUCTION	JNA	JAG	P/c	GWP




EXPORT PIPELINE - PIPELINE ISOMETRIC					
BADAMI CREEK WEST VERTICAL LOOP					
12"-LN-644-0049-MEBEV-3"H					
POINT THOMSON		ALASKA			
MODULE	DRAWN	DATE	SCALE	CHK	JWO
	J. AUGURN	12/11	NONE	APPD	FAC
DRAWING NO. USPT-WP-YDISO-060002-001				SHEET	REV
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FILENAME: USPT-WP-YDISO-060002-001

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BILL OF MATERIAL						
ITEM	S/F	QUANTITY	SIZE	SCH/RTG	DESCRIPTION	ITEM ID
1	F	160 LF	12"	0.406"WT	PIPE LTCS API 5L X65Q-PSL2 HFW BE	
2	F	4	12"	0.406"WT	10.31MM (0.406") WT B36.10M CVN -46C(-50F) INDUCTION BEND LTCS API 5L X65Q-PSL2 HFW BE	
3	F	2	12"		12.70MM (0.500") WT B36.10M 90 DEG 5D WITH 2D TANGENTS EA END CVN -46C (-50F)	
4	F	2	12"		SADDLE SLIDING SEE DWG USPT-WP-YDDET-060014-001 FOR DETAILS.	
					SADDLE GUIDED SEE DWG USPT-WP-YDDET-060013-001 FOR DETAILS.	


DESIGN DATA		
CODE: B31.4	CLEAR: PER SPEC	WELD PROC: PER SPEC
CLASS: MEBEV	PAINT: FBE	STRESS RELIEVE: NO
DESIGN PRESS: 2035 PSIG	INSULATOR: 3"H	NUMBER OF WELDS:
DESIGN TEMP: 200° F	HYDRO TEST: 3053 PSIG	
OPERATING PRESS: 325 PSIG	X-RAY OPT: PER SPEC	SERVICE: CONDENSATE
OPERATING TEMP: 150° F	INTERP: B31.4	
LINE NO: 12"-LN-844-0049-MEBEV-3"H P&ID NO: USPT-WP-YDPID-000001-001 PLAN NO: USPT-WP-YDDET-060002-001		

NOTES:

- NORTH ARROW SHOWN FOR REFERENCE ONLY. SEE DWG USPT-WP-YDPAL-060016-001 FOR ACTUAL ORIENTATION.

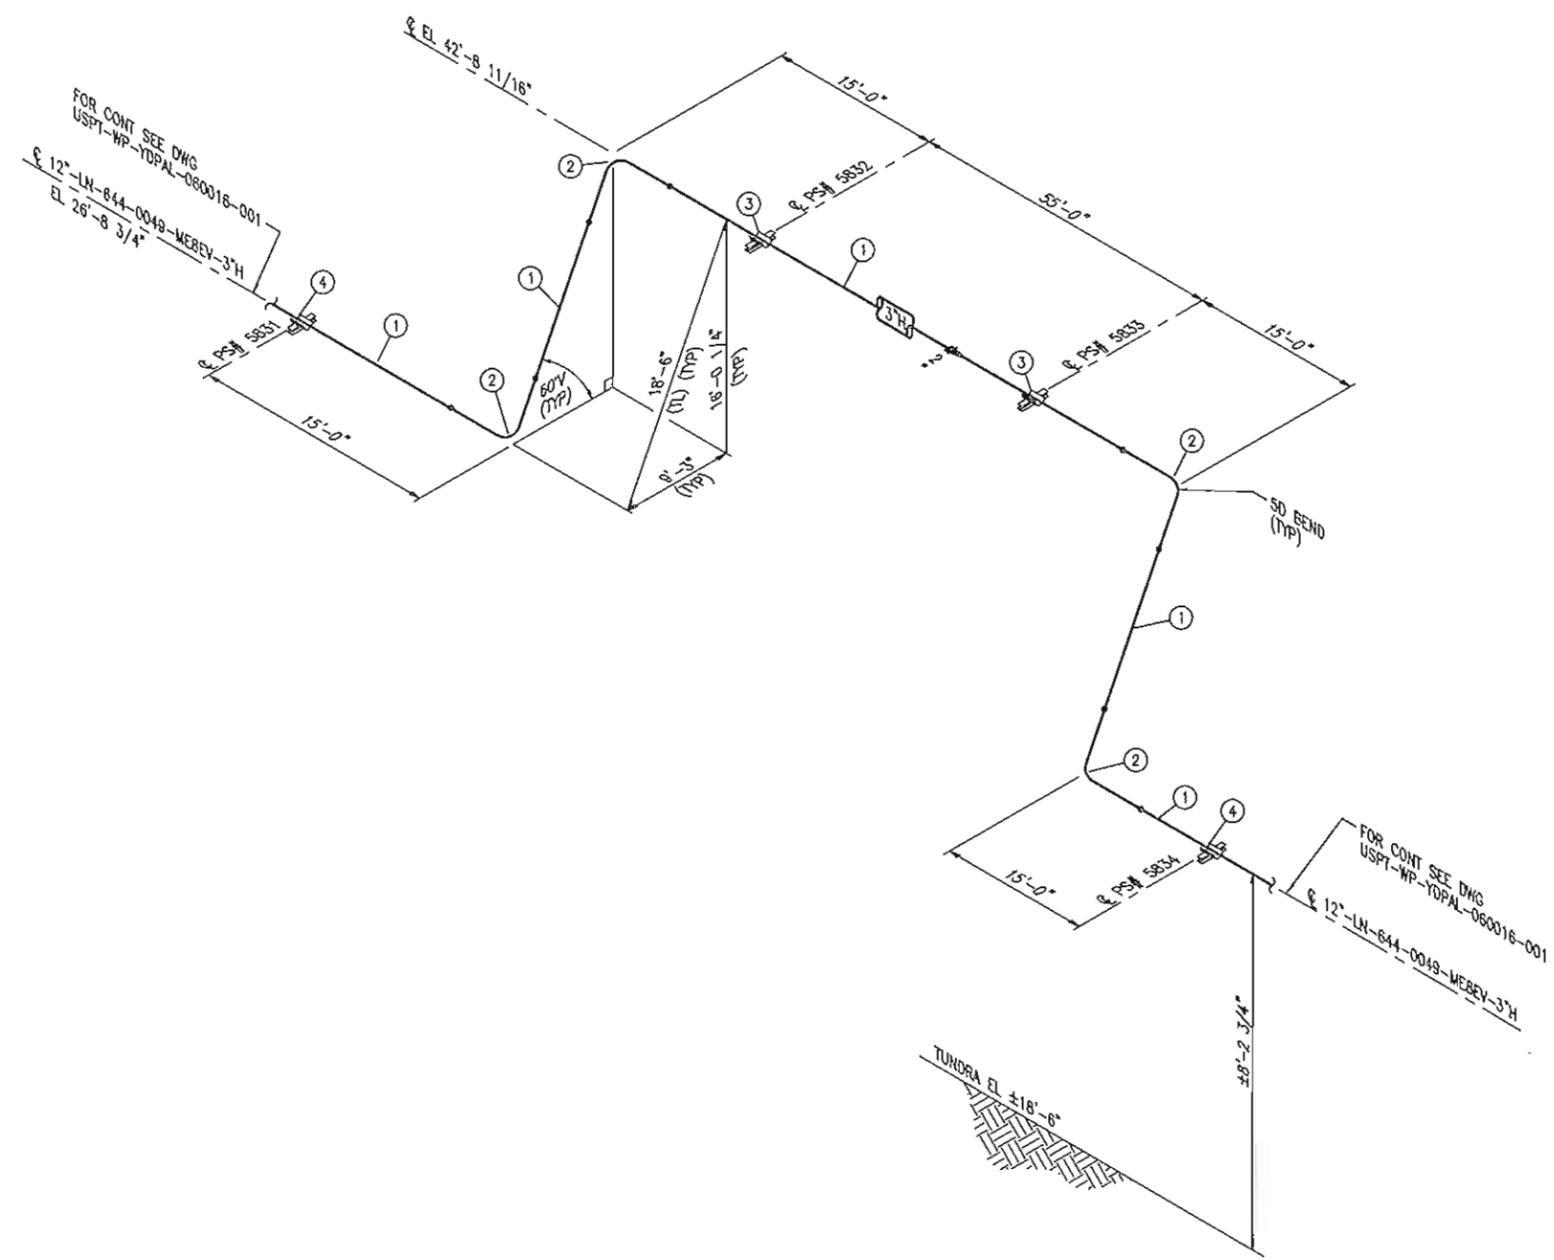REFERENCE DRAWINGS	DESCRIPTION
USPT-WP-YDPAL-060016	PLAN & PROFILE
USPT-WP-YDDET-060002	VERTICAL LOOPS


REV	DATE	DESCRIPTION	BY	CHK	APPD	PSOU
10	12/28/11	ISSUED FOR CONSTRUCTION	JJA	JAG	PAC	GWP

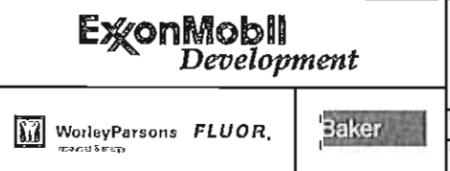

EXPORT PIPELINE - PIPELINE ISOMETRIC			
12" CREEK VERTICAL LOOP			
12"-LN-844-0049-MEBEV-3"H			
POINT THOMSON	ALASKA		
DRAWN: J. AUBURN	DATE: 12/11	SCALE: NONE	CHK APPD: JAG PAC
DRAWING NO. USPT-WP-YDISO-060003-001	SHEET 1 of 1	REV 10	

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FILENAME: USPT-WP-YDISO-060003-001

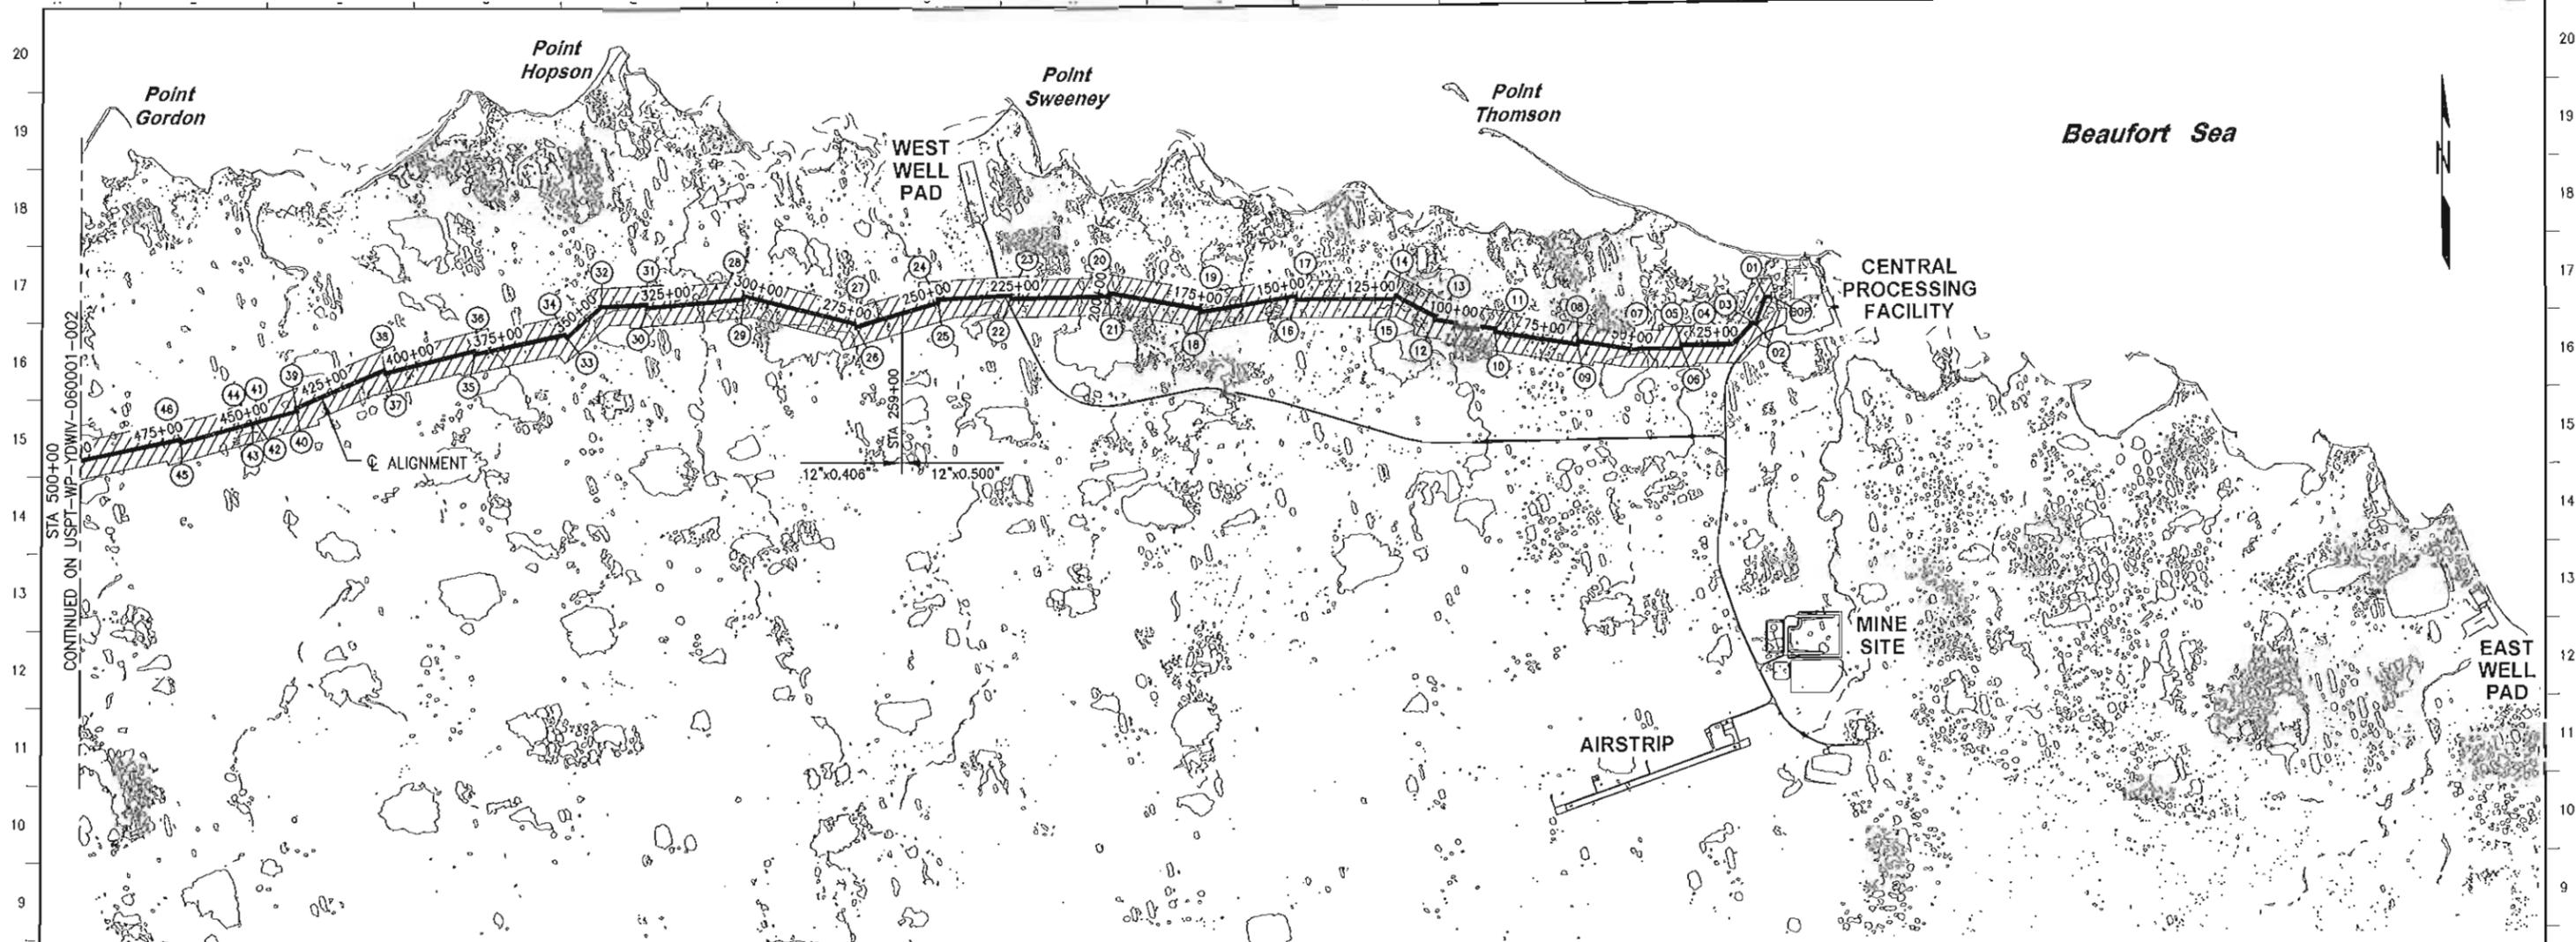

LEGEND

PIPELINE SECTIONS REQUIRING TUNED VIBRATION ABSORBERS (TVA)

PIPELINE PI LOCATION


- NOTES**
- CENTERLINE OF ALIGNMENT = CENTERLINE OF 12"-LN-644-0049-MEBEV-3"H.
 - STATIONING ALONG ALIGNMENT REFLECTS HORIZONTAL DISTANCE.
 - FOR PLANS AND PROFILES, SEE DRAWINGS USPT-WP-YOPAL-060002 THRU USPT-WP-YOPAL-060039.
 - FOR TYPICAL TUNED VIBRATION ABSORBER (TVA) DETAILS, SEE USPT-WP-YDWIV-060002.
 - NOTE THAT DEVICE "L" IS DIFFERENT ON THE 0.500" WT PIPELINE AND THE 0.406" WT PIPELINE.

TVA DEVICE CONFIGURATIONS FOR THE 12"x0.500" POINT THOMSON EXPORT PIPELINE (PTEP) - BOP TO STA 259+00

PIPELINE	QUANTITY	DEVICE	INSULATED DIAMETER (IN)	TVA PART NUMBER	PLATE ASSEMBLY PART NUMBER	NUMBER OF PLATES	DISTANCE FROM END OF ARM (IN)	BASE WEIGHT (LBS)	PLATE WEIGHT (LBS)	STRAP WEIGHT (LBS)	TOTAL WEIGHT (LBS)	SPECIALTY ITEM NUMBER (NOTE 5)
12"x0.500"(3") PTEP@55'	147	L	18.75	J-21784-460-186-2	Y-47006-6-1	6	1.875	18	90	9.0	117	SP-644704-01
	139	M	18.75	J-21784-350-186-1	Y-47006-4-1	4	3.875	17	60	9.0	86	SP-644704-02
	156	H	18.75	J-21784-140-186-1	Y-47006-3-1	3	1.875	23	45	9.0	77	SP-644704-03

TVA DEVICE CONFIGURATIONS FOR THE 12"x0.406" POINT THOMSON EXPORT PIPELINE (PTEP) - STA 259+00 TO EOP

PIPELINE	QUANTITY	DEVICE	INSULATED DIAMETER (IN)	TVA PART NUMBER	PLATE ASSEMBLY PART NUMBER	NUMBER OF PLATES	DISTANCE FROM END OF ARM (IN)	BASE WEIGHT (LBS)	PLATE WEIGHT (LBS)	STRAP WEIGHT (LBS)	TOTAL WEIGHT (LBS)	SPECIALTY ITEM NUMBER (NOTE 5)
12"x0.406"(3") PTEP@55'	522	L	18.75	J-21784-550-186-1	Y-47006-5-1	5	0.750	18	75	9.0	102	SP-644704-04
	503	M	18.75	J-21784-350-186-1	Y-47006-4-1	4	3.875	17	60	9.0	86	SP-644704-02
	556	H	18.75	J-21784-140-186-1	Y-47006-3-1	3	1.875	23	45	9.0	77	SP-644704-03

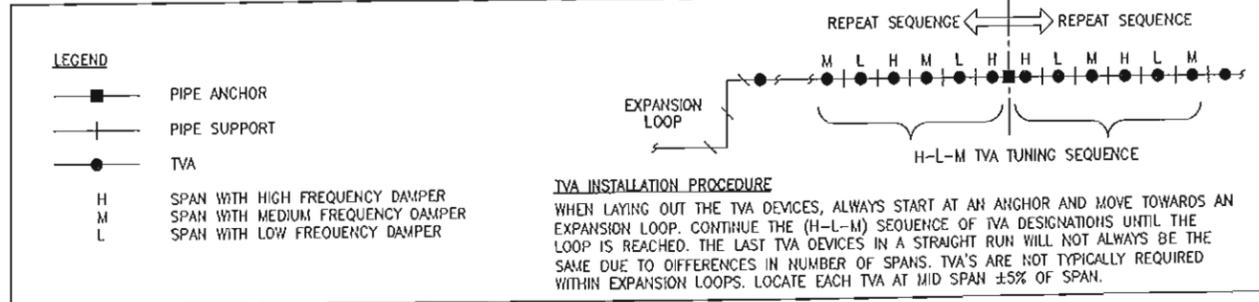

REFERENCE DRAWINGS

REFERENCE DRAWINGS	DESCRIPTION
USPT-WP-YOPAL-060002 THRU 060039	PLANS & PROFILES
USPT-WP-YDWIV-060002	TYPICAL TUNED VIBRATION ABSORBER DETAILS



REV	DATE	DESCRIPTION	BY	CHK	APPD	PROJ
10	12/28/11	ISSUED FOR CONSTRUCTION	RFH	JAG	PAC	GWP
11	03/02/12	ISSUED FOR CONSTRUCTION	RFH	JAG	PAC	GWP

ExxonMobil Development


WorleyParsons FLUOR Baker

EXPORT PIPELINE - PIPELINE WIND-INDUCED VIBRATION MITIGATION SITE PLAN BOP TO STA 500+00

MODULE	DRAWN	DATE	SCALE	CHK	APPD	ALASKA
R. HOBBS	R. HOBBS	12/11	AS SHOWN	R. HOBBS	PAC	11

USPT-WP-YDWIV-060001-001 1 of 2 11


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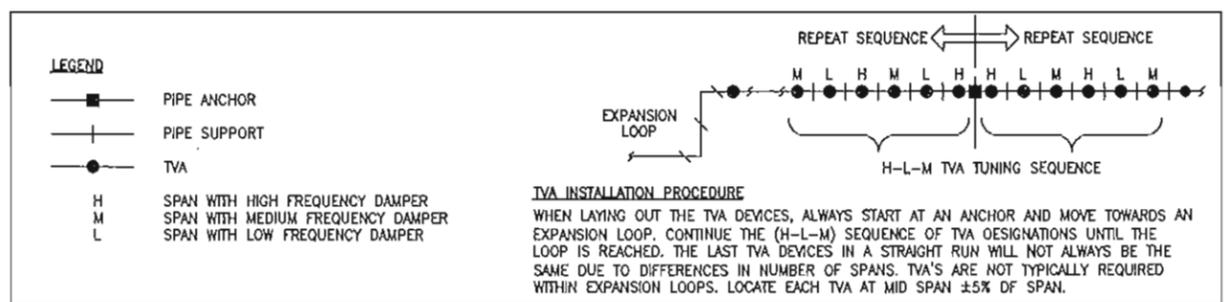
LEGEND

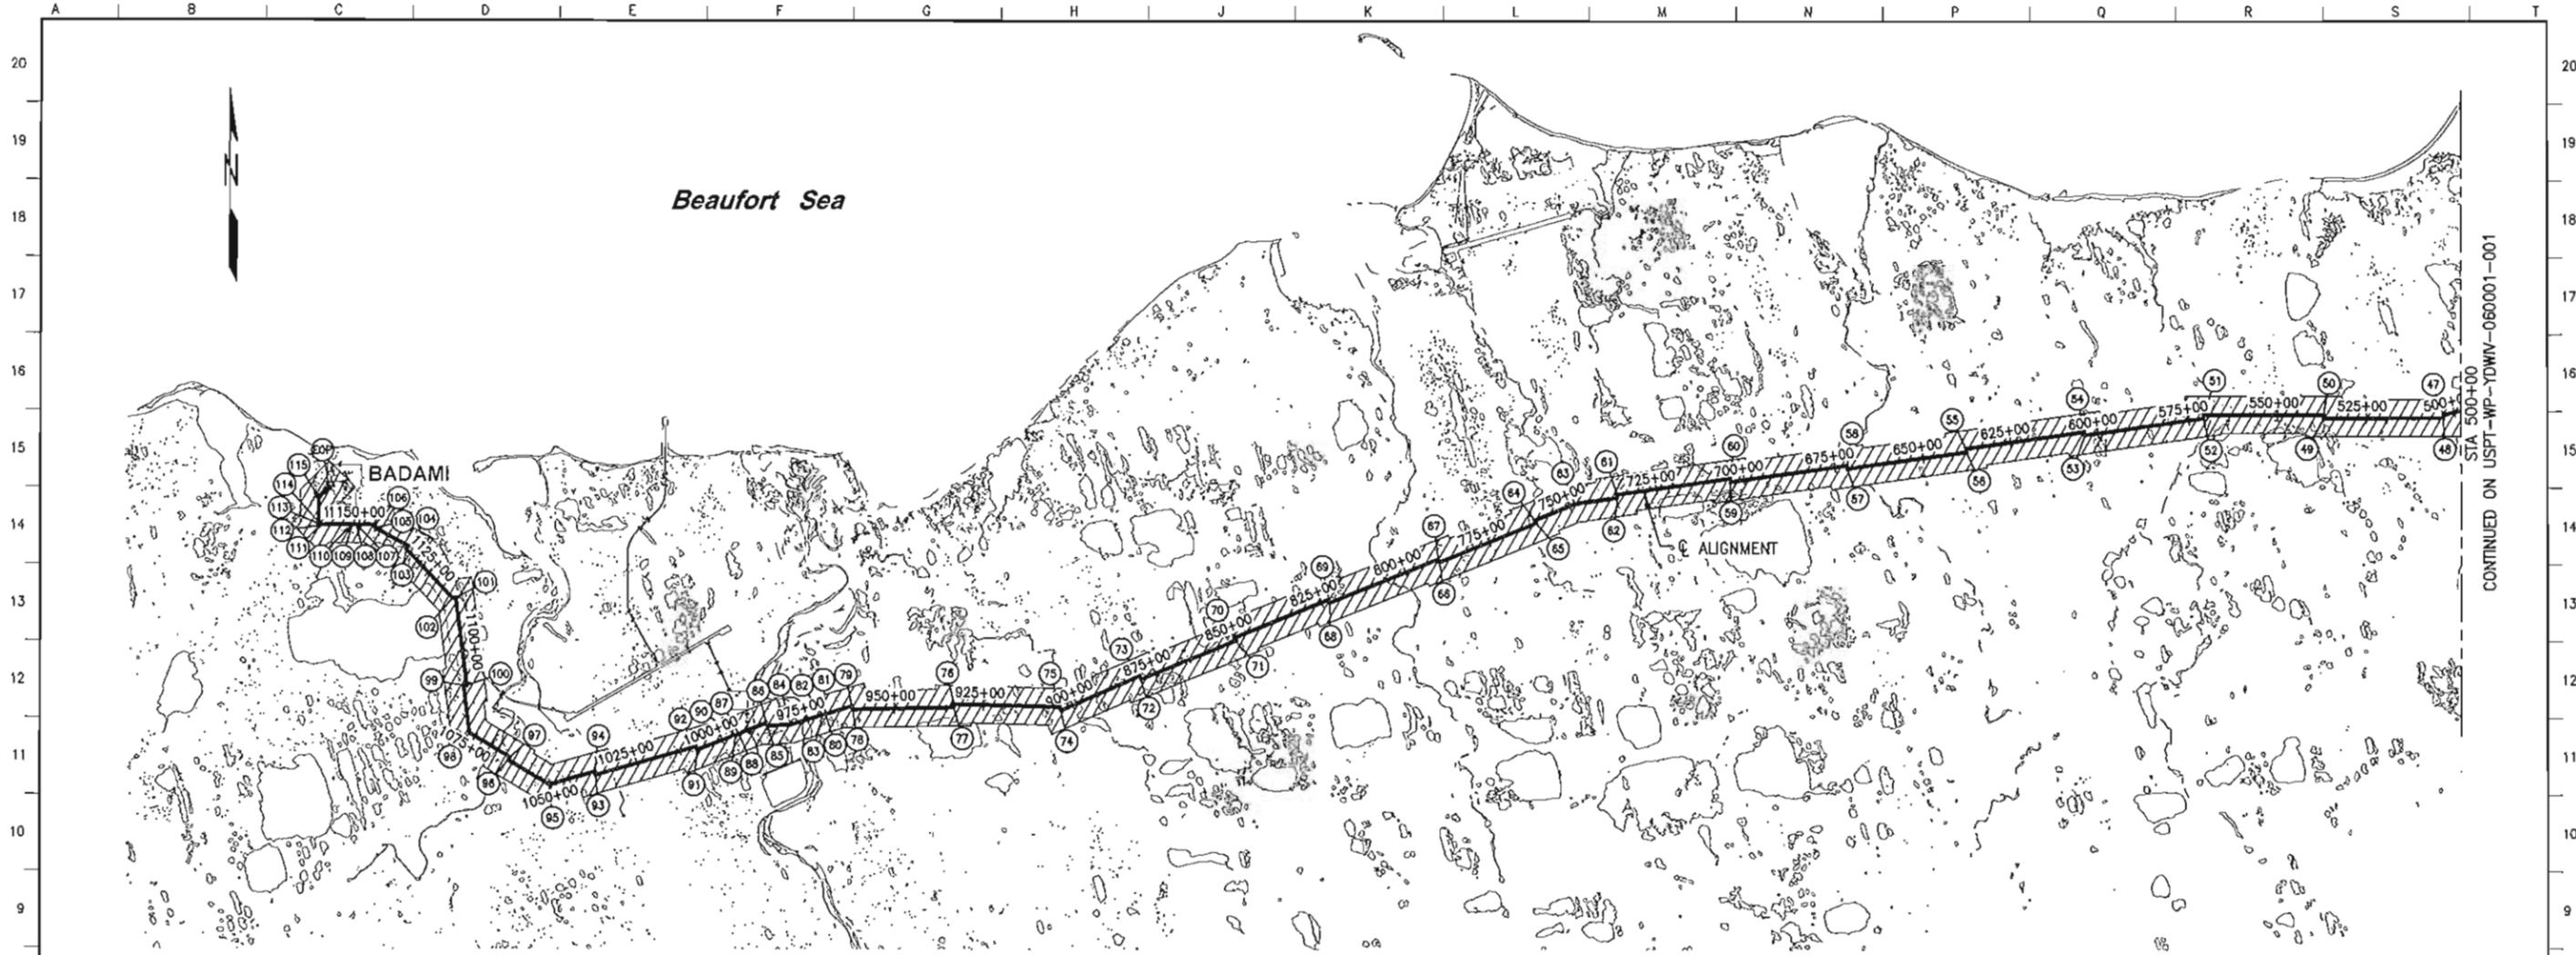PIPELINE SECTIONS REQUIRING TUNED VIBRATION ABSORBERS (TVA)

PIPELINE PI LOCATION




- NOTES**
- CENTERLINE OF ALIGNMENT = CENTERLINE OF 12"-LN-844-0049-ME8EV-3"H.
 - STATIONING ALONG ALIGNMENT REFLECTS HORIZONTAL DISTANCE.
 - FOR PLANS AND PROFILES, SEE DRAWINGS USPT-WP-YDPAL-060002 THRU USPT-WP-YDPAL-D6D039.
 - FOR TYPICAL TUNED VIBRATION ABSORBER (TVA) DETAILS, SEE USPT-WP-YDWIV-060002.

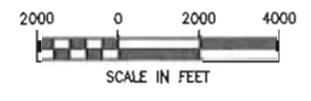

REFERENCE DRAWINGS	DESCRIPTION
USPT-WP-YDPAL-060002 THRU 060039	PLANS & PROFILES
USPT-WP-YDWIV-060002	TYPICAL TUNED VIBRATION ABSORBER DETAILS



REV	DATE	DESCRIPTION	BY	CHK	APPD	PROJ
10	12/28/11	ISSUED FOR CONSTRUCTION	RFH	JW3	PAG	GHP

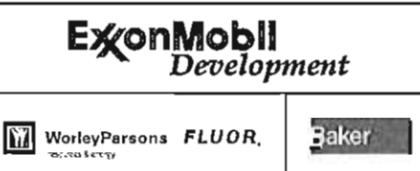

EXPORT PIPELINE - PIPELINE WIND-INDUCED VIBRATION MITIGATION SITE PLAN STA 500+00 TO EOP			
POINT THOMSON	ALASKA	SCALE	AS SHOWN
DESIGN	DATE	CHK	APPD
R. HOBBS	12/11	AS SHOWN	PAC
DRAWING NO.	USPT-WP-YDWIV-060001-002	SHEET	2 OF 10

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FILENAME: USPT-WP-YDWIV-060001-002

